RODGERS CREEK AREA 5

CYPRESS BOWL ROAD, WEST VANCOUVER

LANDSCAPE SET: ISSUED FOR DEVELOPMENT PERMIT JULY 16TH, 2024

& Septemper 20, 2024

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RODGERS CREEK AREA 5

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LANDSCAPE CONTEXT

Every project comes with its own stories that set itself apart from the rest. Rogers Creek Area 5 is not an exception in the ways of the remarkable mountainous land involved, and the setting of unique location with a truly natural space and min-blowing views to the city of Vancouver and Burrard Inlet. Cypress Mountain isn't single mountain at all it is a collection of mountains, ridges., creeks, plateaus and valleys located in the southern section of Cypress provincial park. It has an enormous mountain culture, a concept that helps define every aspect of project sit in this location. This mountain culture is based on the fascinating interconnection between human beings and potential of rugged landscapes as a reference to the lifestyle and passions of people who are drown to this particular site seeking for their dream homes.



LANDSCAPE VISIONING

Connection to Nature

The unique natural setting of the site serves as our primary inspiration, shaping both the architecture and landscape design to integrate seamlessly with the surrounding environment. Our design aims to authentically respond to the mountain's natural conditions, fostering a strong connection with the landscape. By carefully considering the site's existing features, we aim to create a landscape that honors its history while embracing new opportunities.

Unique Landscape

Our landscape architecture is integral to creating a distinctive ground-level experience, characterized by multi-terraced open spaces that embody the unique mountain lifestyle. This experience fosters a sense of belonging for residents who appreciate the region's natural beauty, celebrating the spirit of the mountain.

A Nest/Home Experience

Our vision for the project extends beyond architectural sophistication, aiming to create a mountain destination that offers recreational and cultural possibilities for both residents and visitors. From outdoor lounging to community gatherings, our design caters to a diverse range of activities.

LANDSCAPE DESIGN PRINCIPLES

- Create Meaningful Open Space
- Develop Community Character
- Pedestrian-Oriented Local Street
- Minimize Disturbance & Preserve Existing Features
- Reserve and Restore Natural Habitat
- Conserve and Protect Water Resources
- Minimize Fire Hazard


LANDSCAPE DESIGN APPROACHES


- 1. Integrate site plan with the forest, blending into the mountain and maximizing views of greenery while minimizing exposure of parking structures.
- 2. Provide access to mountain trails from outdoor and indoor amenities, offering opportunities to explore the mountain greenway.
- 3. Connect indoor and outdoor spaces with naturalized landscapes.
- 4. Incorporate rainwater and mountain creeks to create water features.
- 5. Introduce native plant species, local stones/boulders to reflect the site's characteristics.
- 6. Manage vegetated slopes and structures to restore trees and understory plantings.
- 7. Define a mountain home/community within the Cypress Mountain North Shore forest, catering to the desires of those drawn to the site.
- 8. Explore a design language that communicates the land's story and spirit, blending naturalized yet elegant expressions that distinguish the project while harmonizing with the surroundings.
- 9. Design entrance roads and amenity building as gateways that define arrival experiences unique to the site.
- 10. Develop access roads to ensure safe, enjoyable travel and walking experience for bott drivers and pedestrians.
- 11. Utilize grading changes to create multi-terraced landscapes to create a public destination.
- 12. Featured structure is introduced to enhance the Nest/Home experience.
- 13. Provide a variety of passive and active amenities in centrally located open space.
- 14. Children playground and family gathering space are integrated to optimize the space use. 15. Trees and vegetations to selected and located to maximize views and comply to the wildfire management plan.
- 16. Designate public accessibility along public trail and semi-public zones at strata road levels, with semi-private zones along the tower frontage to establish a hierarchy of privacy.
- 17. Develop an easy-to-navigate walkway system that prioritizes pedestrian access to amenities and facilities.
- 18. Explore additional opportunities to enhance the residential and recreational experiences within the community, such as provide featured rest spot for public trail.

CHARACTER ZONES

Based on the analysis of the existing site conditions and potential proposed programs, the landscape area has been categorized into the following different areas.

- Conservation and Restoration Area
- Existing Public Trail and Wetland Area
- Strata Road Streetscape
- Feature Areas
- Southern Green Slope

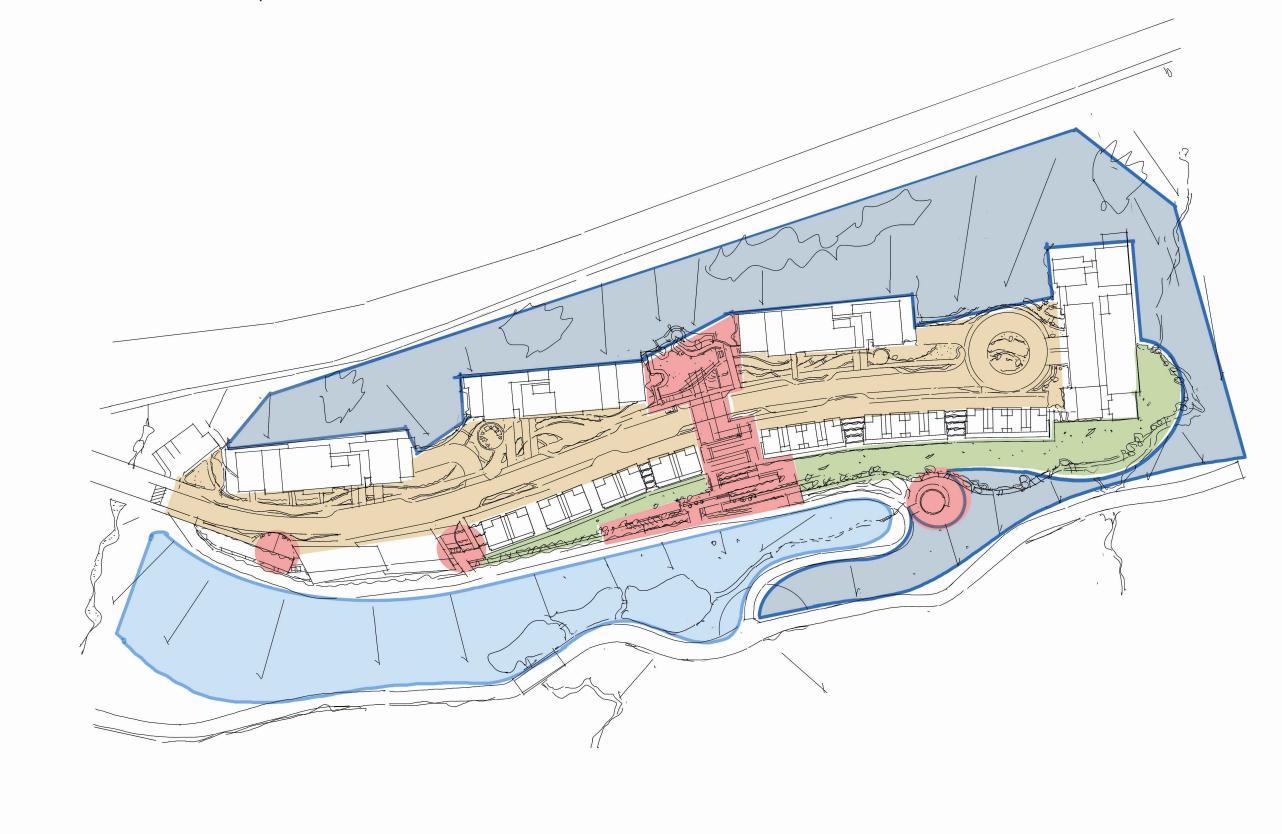

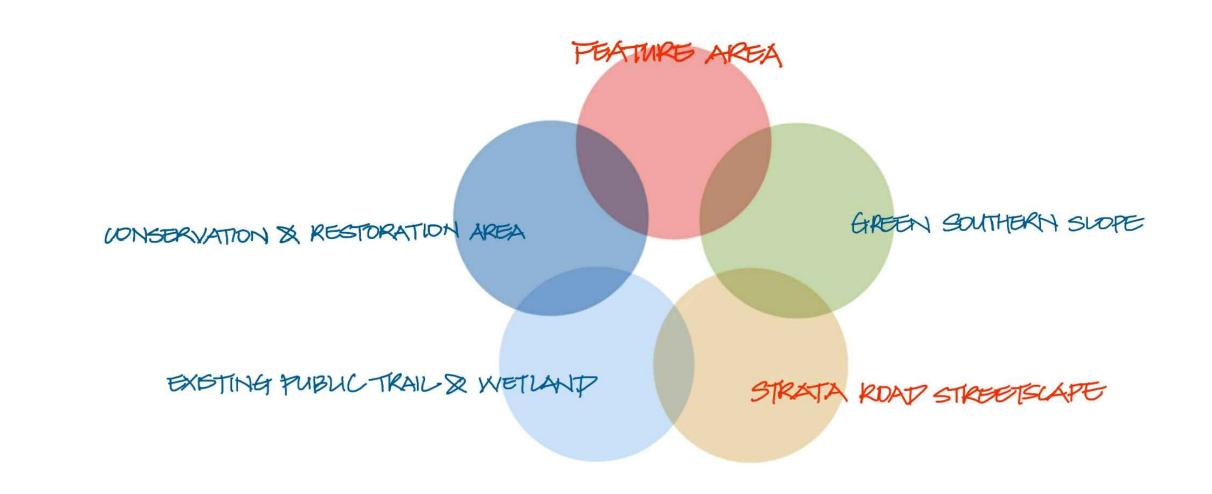

CONSERVATION AND RESTORATION AREA

Protect existing soil, watercourses, trees, and rock features. Consult with an arborist, civil engineer, and environmentalist to minimize disturbance and stabilize the slopes. Develop a management plan to cover tree protection, soil protection and stabilization, and watercourse restoration. Human access should be limited to this area given the steep slope and vulnerable environmental conditions.

Vegetation in this area helps maintain site stability and reduce wildfire hazard. Native planting will be used to increase planting establishment and reduce fuel load. Plant selection should reduce ladder fuel (small trees and brush that can help a fire spread from the ground to the tree canopy). Tree planting spacing should maintain buffer zones for fire hazard.

Watercourses will be retained and restored to minimize development impact on local hydrology and ecosystems. Environmental strategies should be applied as advised by environmentalists and arborists based on the City's bylaws and local management plan.

EXISTING PUBLIC TRAIL AND WETLAND AREA

This zone has been constructed based on the previously approved design. PWL was hired to provide landscape improvements for the public trail. The wetland on the site is a 3-tier retention pond which serves as part of the on-site storm management. Given our project development on the upper hillside of the wetland, surface drainage or bioswales should be considered to incorporate into the existing water retention and swales.

STRATA ROAD STREETSCAPE

The street culming incorporates parallel parking, planting beds, pedestrian crossings, and street furniture to create a safe street for pedestrians. The travel lanes are narrowed to the minimal required dimension to allow for maximized landscape space. At the intersection with parking ramps, the landscape is arranged to provide visual clearance and safety for drivers and pedestrians. An elevated crosswalk for the central park is proposed to further accentuate the focus and themed area and reduce vehicle speeds at this location.

Street trees are planted to offer shade to people while maintaining southern ocean views from building units. The road is constructed on top of the parking structure with no rainwater infiltration capacity. However, rainwater management is still needed to be considered. In our case, the idea is to catch and channel street runoff to street boulevards. With the help of road longitudinal slope, rainwater is led to different on-site detention and retention water features. Major dry and wet swales are proposed in the central park, which will be discussed in the feature areas. All the raingardens along the boulevards are connected to hold water on-site to avoid peak storm flow and slowly release water to the local creeks, which reduces potential soil erosion and flooding downstream and downhill.

FEATURE AREAS

The feature areas include the central park, the terrace, and a series of frontage garden places.

The central park sits in the largest open space on the site and will serve as the major outdoor amenity for residents and visitors. It is a family-oriented gathering space providing accessibility to all ages and groups of people. A multi-purpose lawn is offered for large group gatherings and set away from the road with a green buffer for safety. A playground takes advantage of the existing mountain slope and is created to offer themed adventure play. Using custom design structure to create a unique community place. In our case, the concept of "Nest" is proposed to indicate the home and mountain spirit. The unique theme structure is constructed to demonstrate the theme and help reinforce the character of the community, which is considered one of the principles of a healthy and sustainable community. In the central park, other amenities such as sheltered seating, outdoor picnic areas, informal amphitheater, therapeutic garden are all provided to meet different age and group needs.

The terrace stretches approximately 18 meters high, 30 meters deep, and 20 meters wide as an important interface between the public realm/trail and strata space/road. The design intent is to create a publicly accessible space for people on the trail and become an animated frontage zone for the project. Stormwater management plays a great role in the design when rainwater is led to fall through the cascaded weirs to form a manmade mountain stream. It acts for stormwater retention while at the same time forms a significant visual interest for the public. It also helps to educate the public on stormwater treatment and encourages robust environmental stewardship. Plenty of seat spaces are provided for public rest and to enjoy the views. It is not only an amenity space of the project; it also aims to create a public destination for everyone visiting the mountain trails.


The decking space at the amenity building provides outdoor space for people to enjoy the spectacular views. It also serves as a welcome pedestrian gateway for visitors entering the site and wanting to know more about the projects and the neighborhood.

Several outdoor gardens are provided at each of the high-rise front door areas. Seating, bike racks, wayfinding elements, and accent lighting are provided to create usable and meaningful outdoor space and encourage nature surveillance. All doorways are designed to pass through a raingarden to form the feel of territory and accentuate the entrance experience.

SOUTHERN GREEN SLOPE

The southern slope to the amenity building and townhouse will be constructed by the city's request. The landscape on the slope should utilize (1) typical Rodgers Creek character for walls using natural stone and/or Mechanically Stabilized Earth (MSE) bags (and formal Allan Block or other concrete/wood cribbing is not supported); and (2) Landscaping must comply with the wildland fire plan attached

LANDSCAPE STRATEGIES FOR WILDFIRE MITIGATION

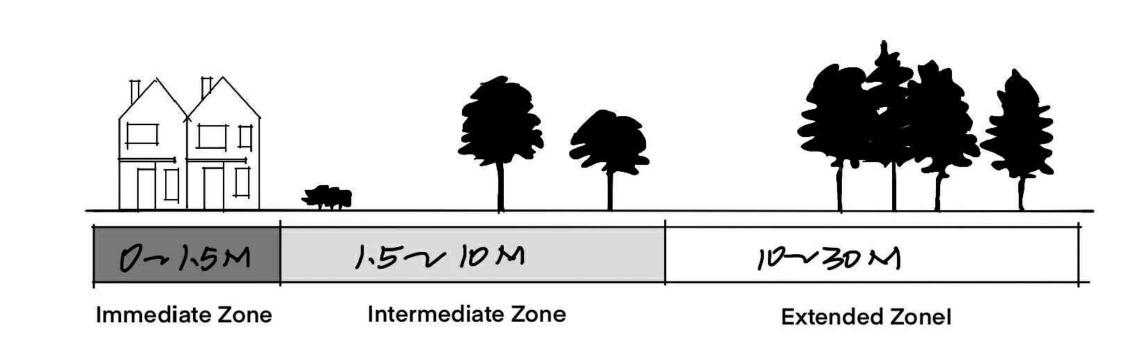

In General, landscaping strategies follows the recommendations by Wildfire Hazard DP Area Assessment Report and ensure that no conifer species or long grasses with a mature height greater than 30cm are installed in new landscaping. This includes hedges of cedar, cypress, or yew species. No combustible materials, including fencing and decks, are permitted within 1.5m of the structure.

FireSmart divide the area around the home into "priority zones", which radiate out from the structure and reflect the different ignition pathways.

The Immediate Zone is the area immediately adjacent to a structure, out to 1.5 m. A non-combustible surface extends around the entire structure and any attachments, such as decks.

The Intermediate Zone is the area within 1.5 and 10 m of the home or building. Plant selection within this zone focus on species with low flammability. Plants recommended by FireSmart BC Landscaping Guide are preferred. Any landscaping features, such as garden beds, retaining walls, or outdoor structures, are constructed from non-combustible or fire-resistant materials. Decks and fences are made from materials like metal or treated wood that are less susceptible to ignition. Cleaning up debris, garbage, or storage is also of primary importance in this area.

The Extended Zone includes the area beyond 10 m from a structure. Wildfires in forests within this zone can subject the building to radiant heat and may produce an ember shower onto the building. Forest fuels are generally treated aggressively in this area to prevent a crown fire from establishing and reduce the intensity of radiant heat and ember production. Landscape design considers the ease of maintenance and treatments that may include removal of ground fuel, thinning of trees, and lift pruning of retained trees. New trees are spaced to prevent the spread of fire and allow for their individual maintenance and lifting pruning. The landscape design in the extended zone also considers clear, accessible routes for fire fighting equipment and personnel can significantly improve emergency response capabilities.

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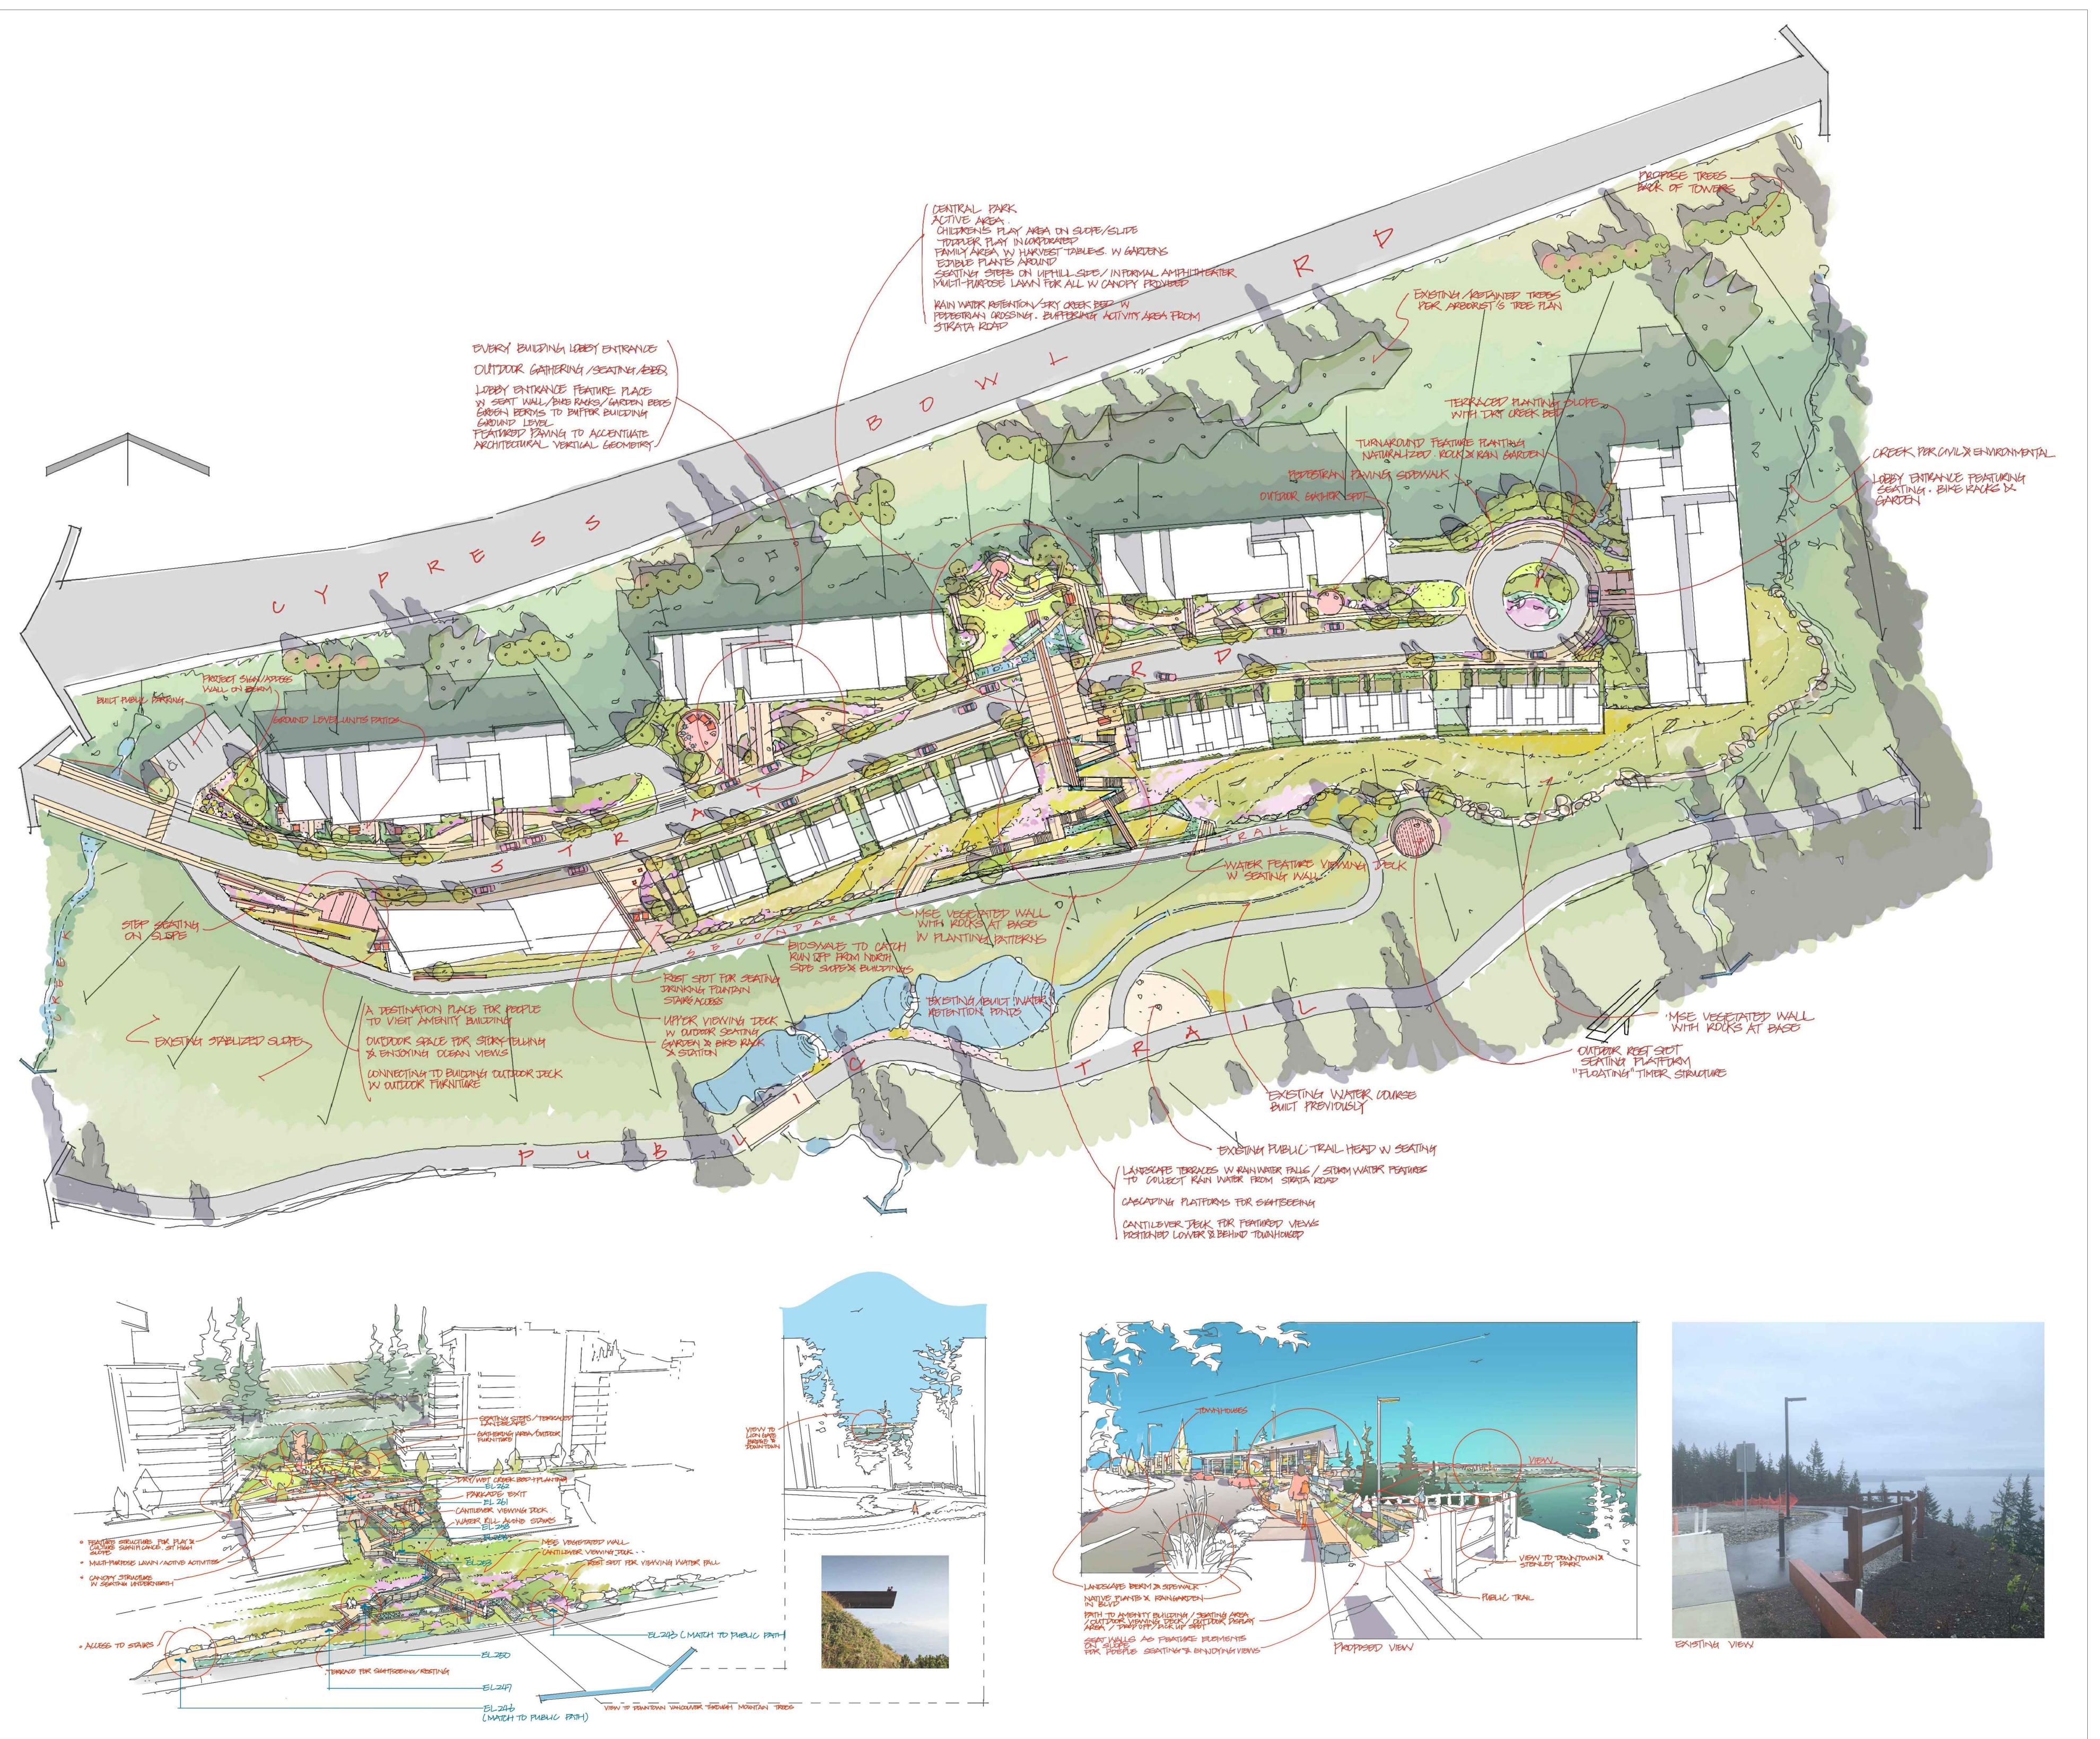
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Drawing Title

LANDSCAPE DESIGN RATIONALE & WILD FIRE MANAGEMENT

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CONCEPT

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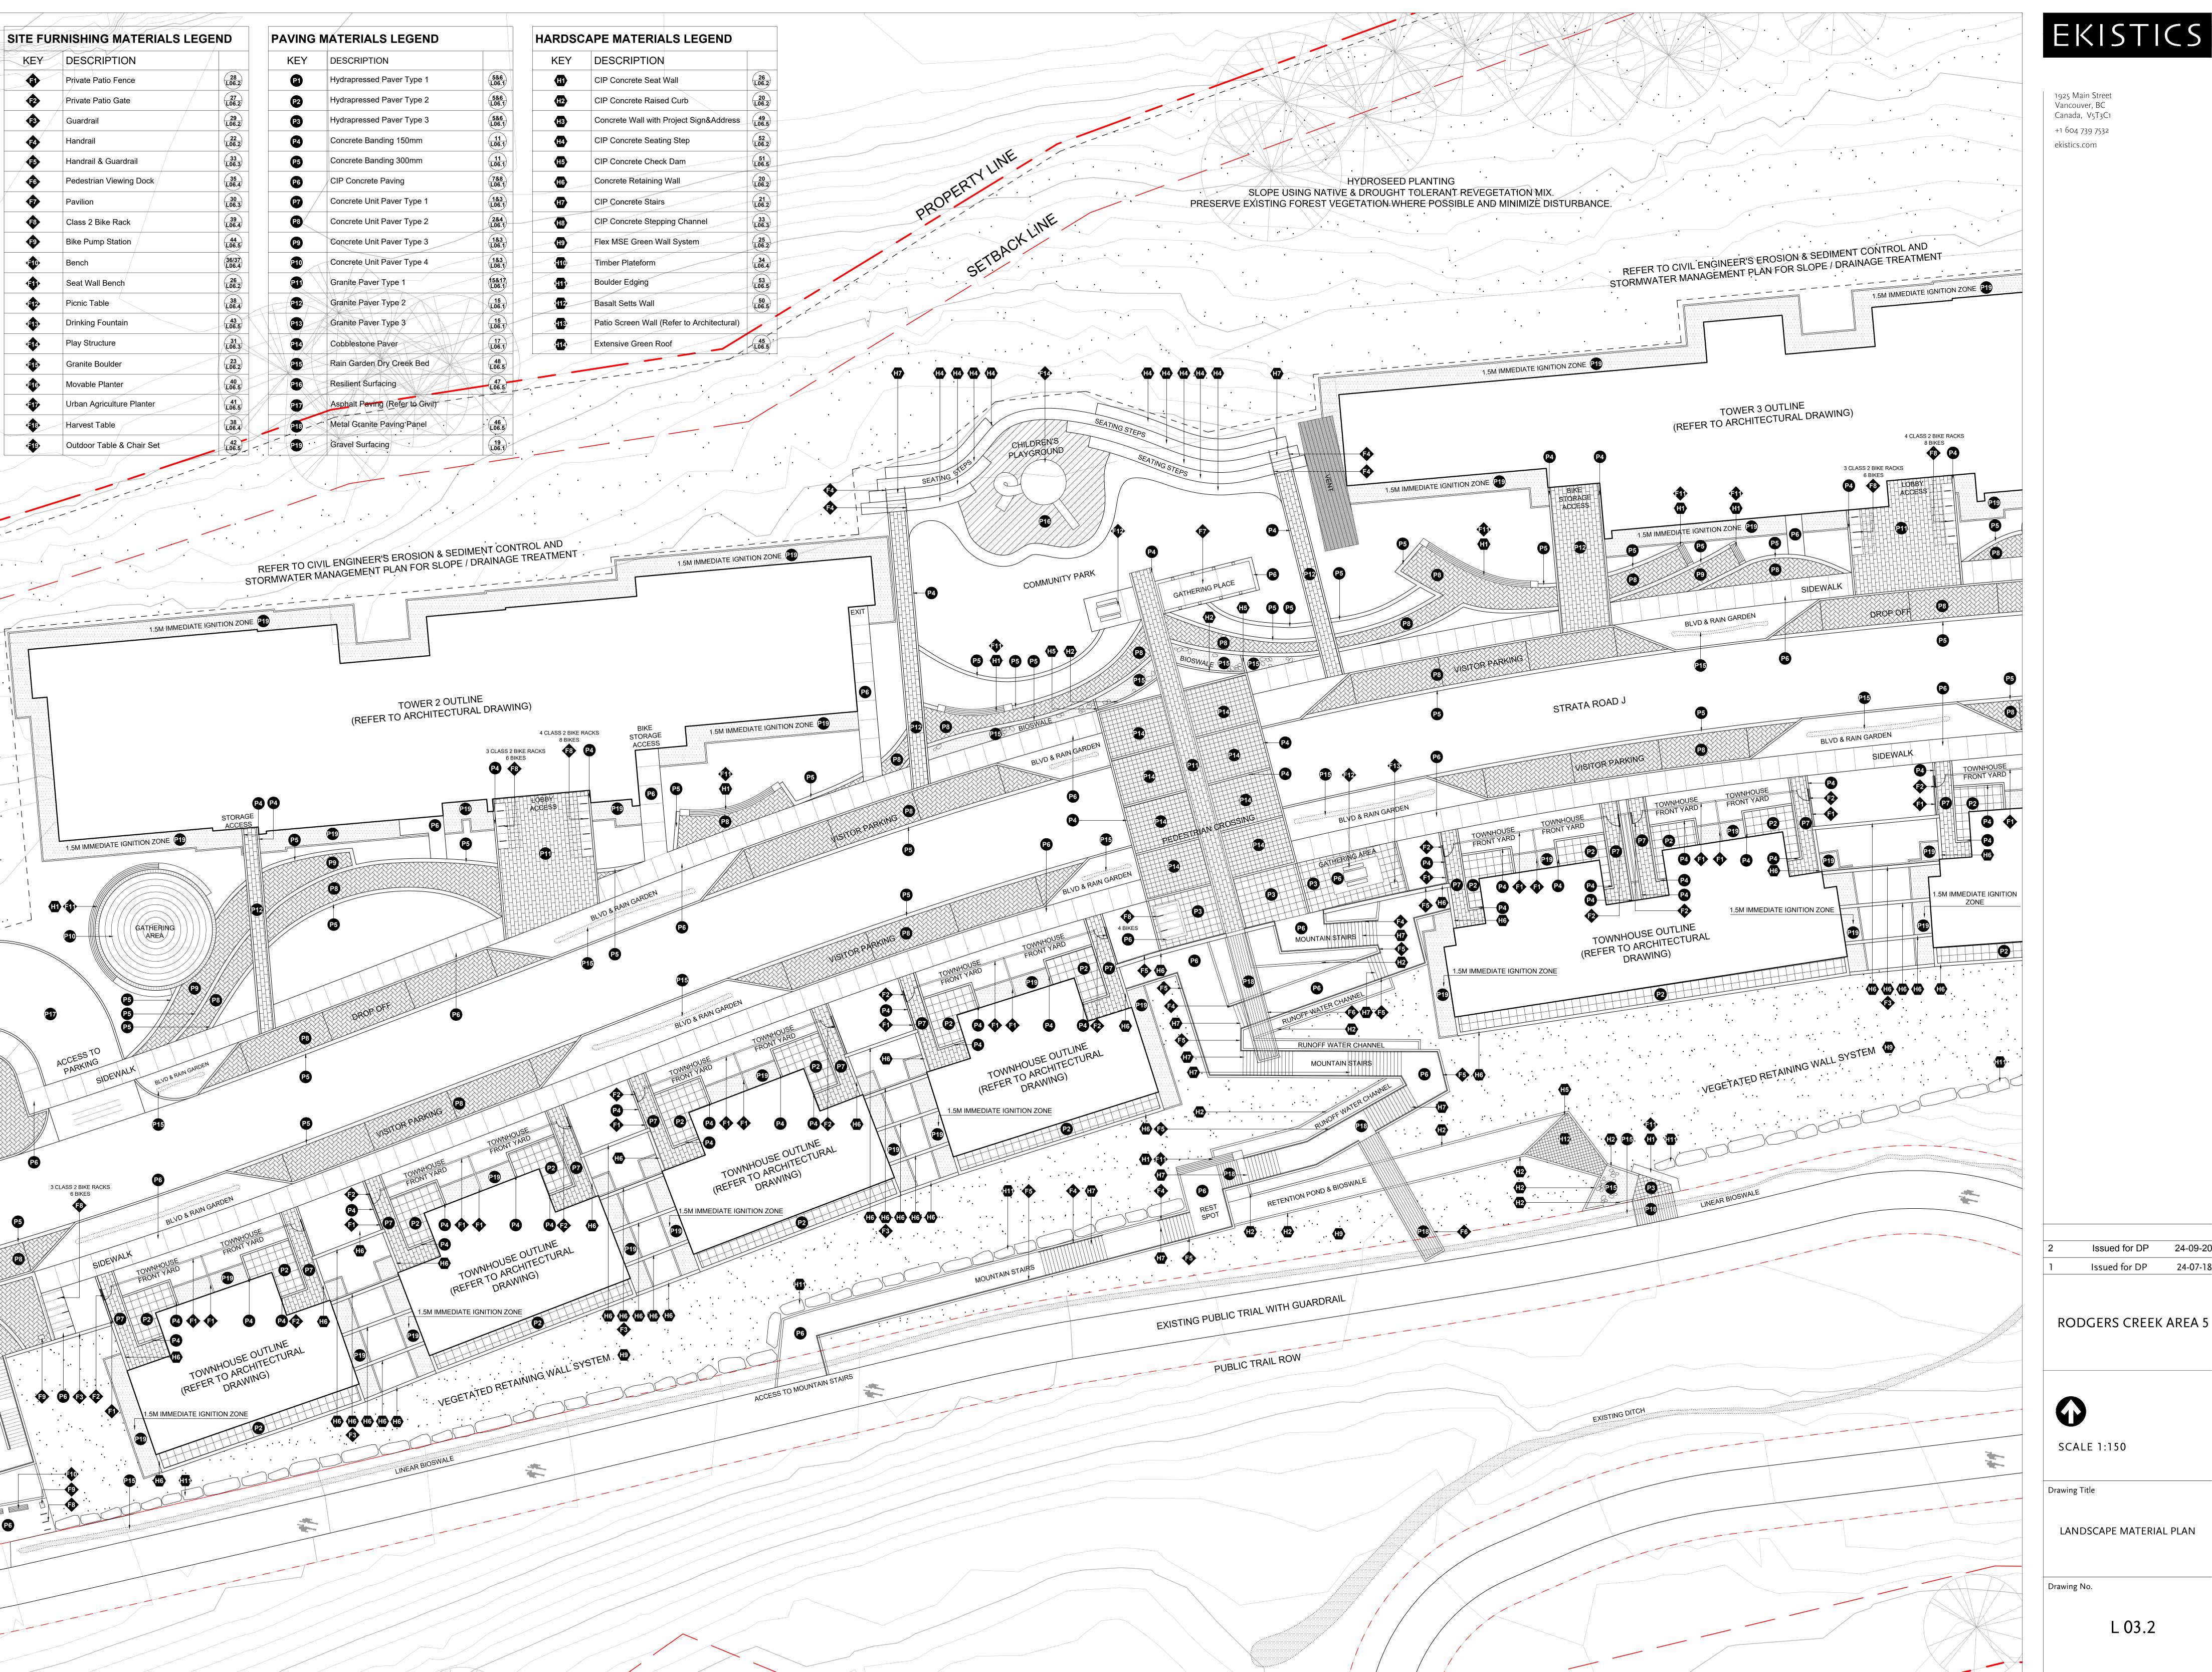


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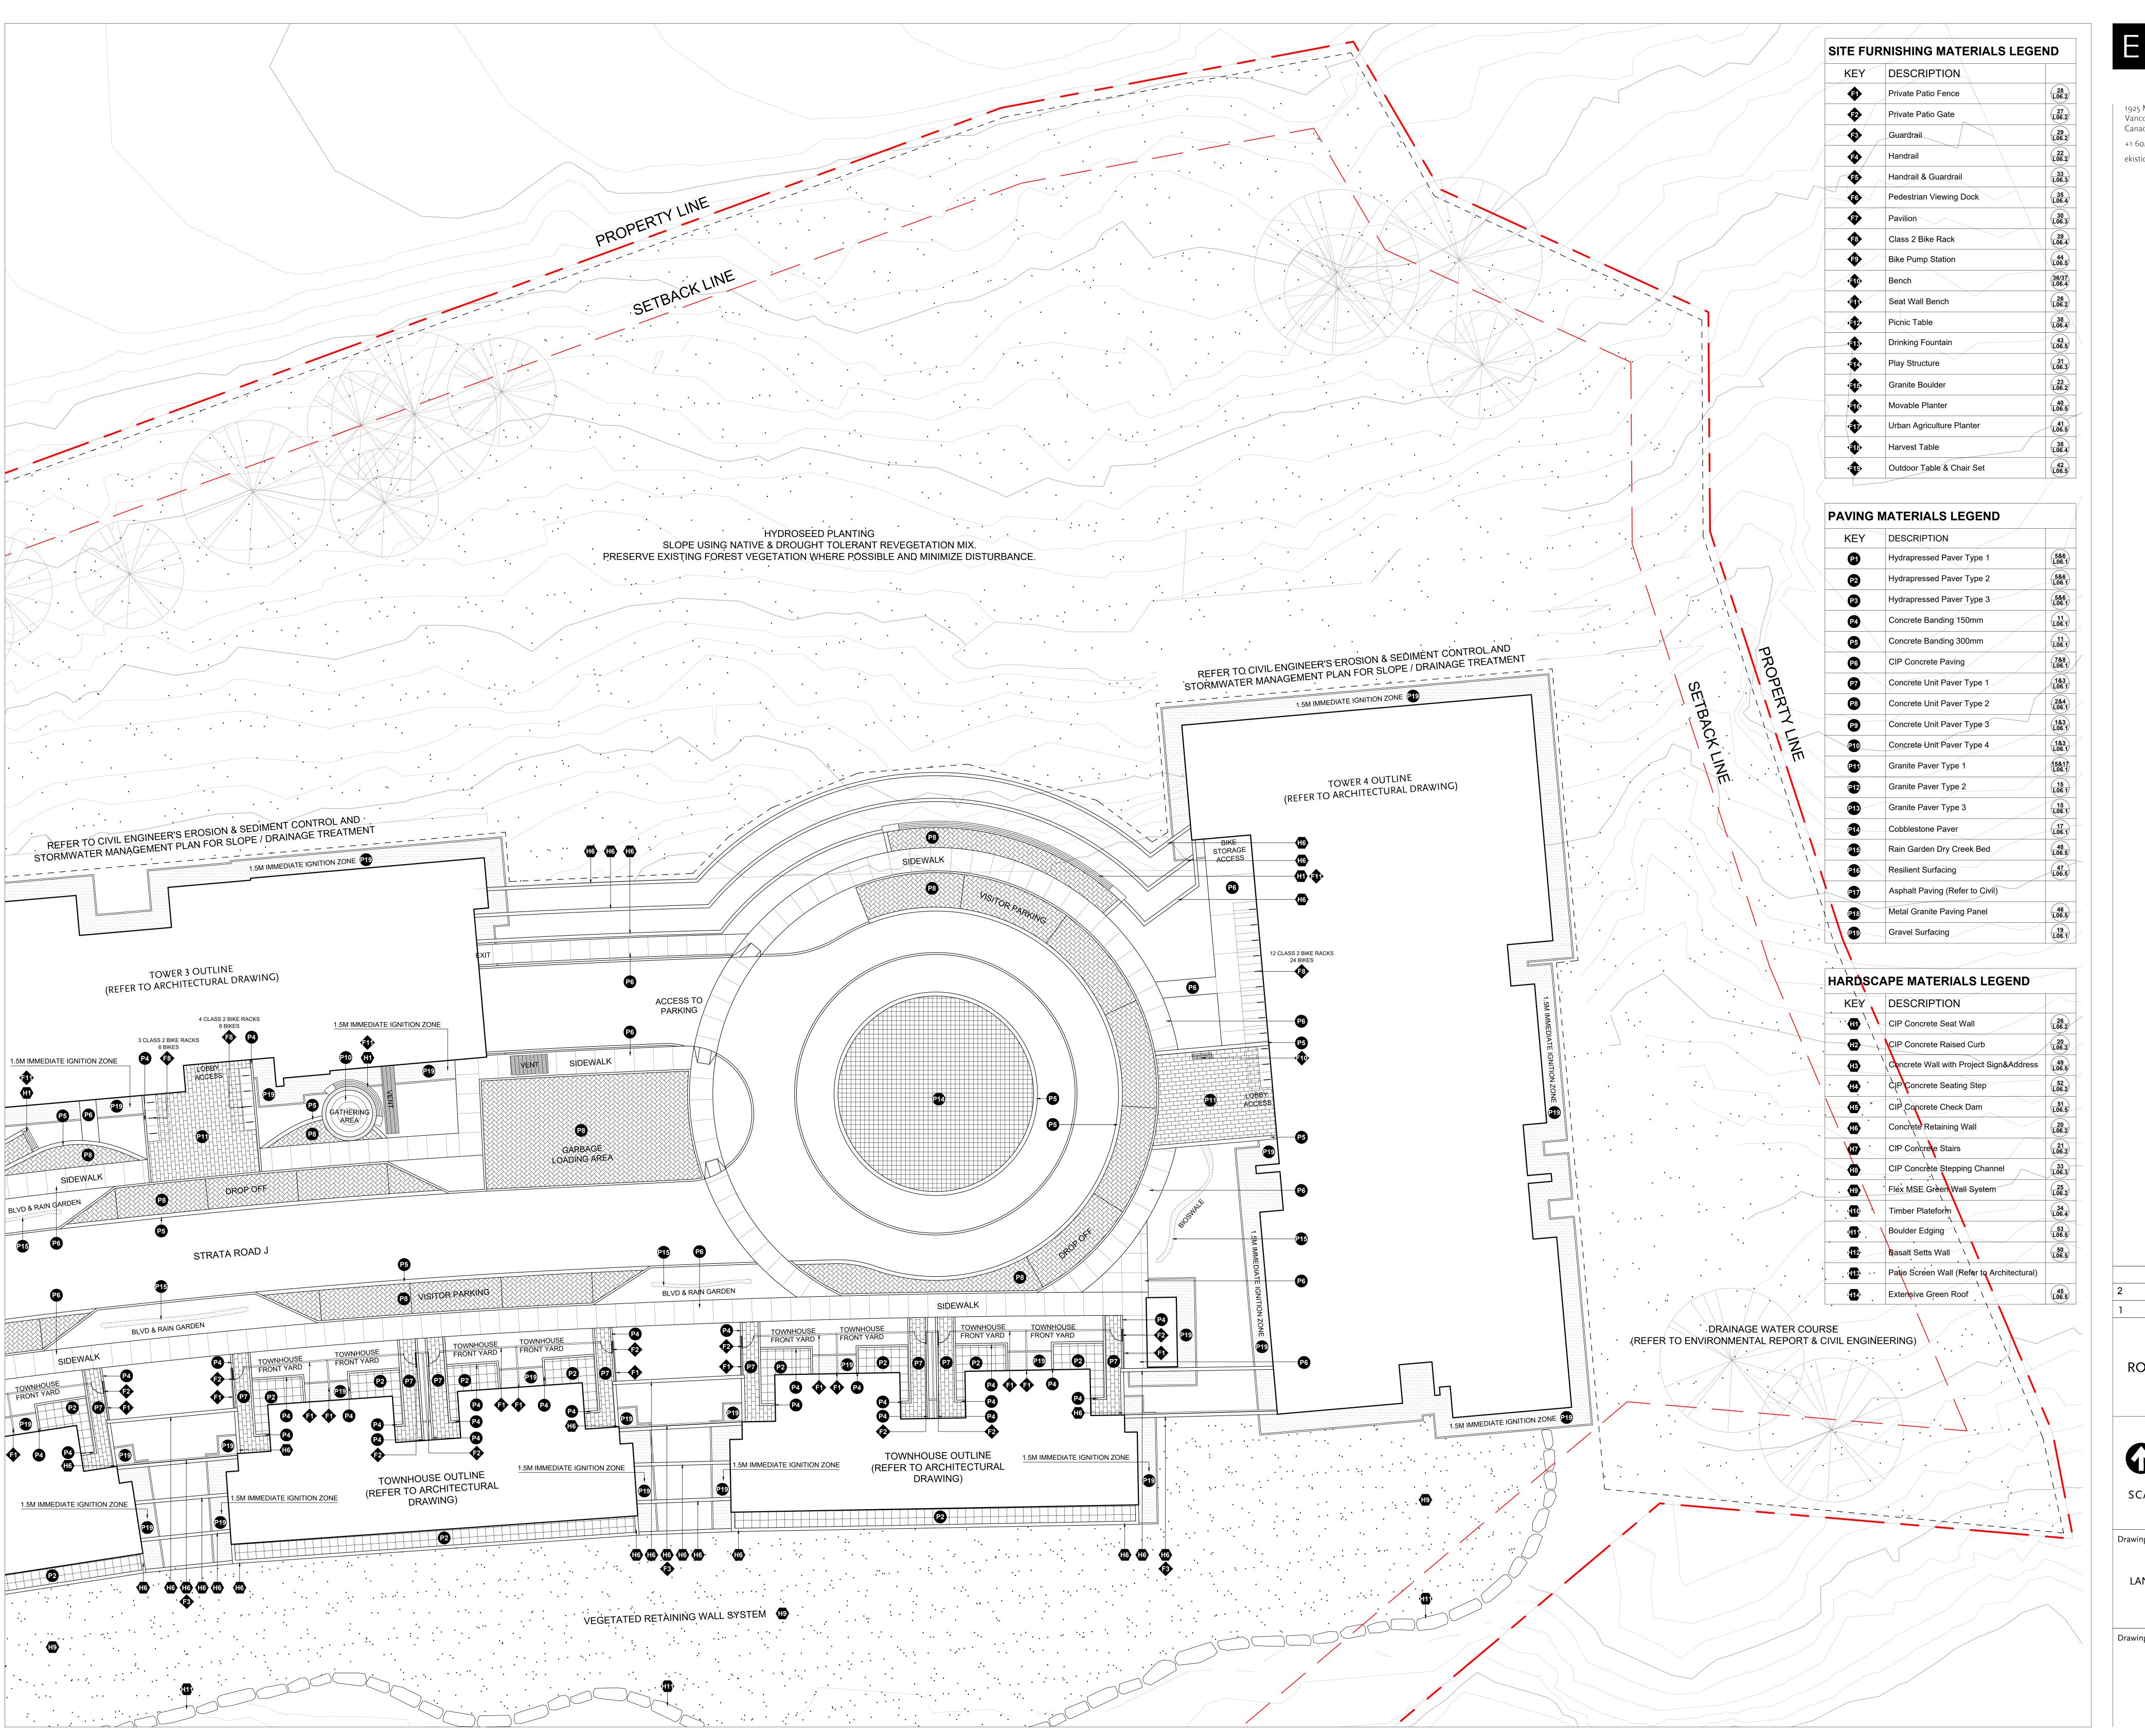
Drawing Title

LANDSCAPE MATERIAL PLAN

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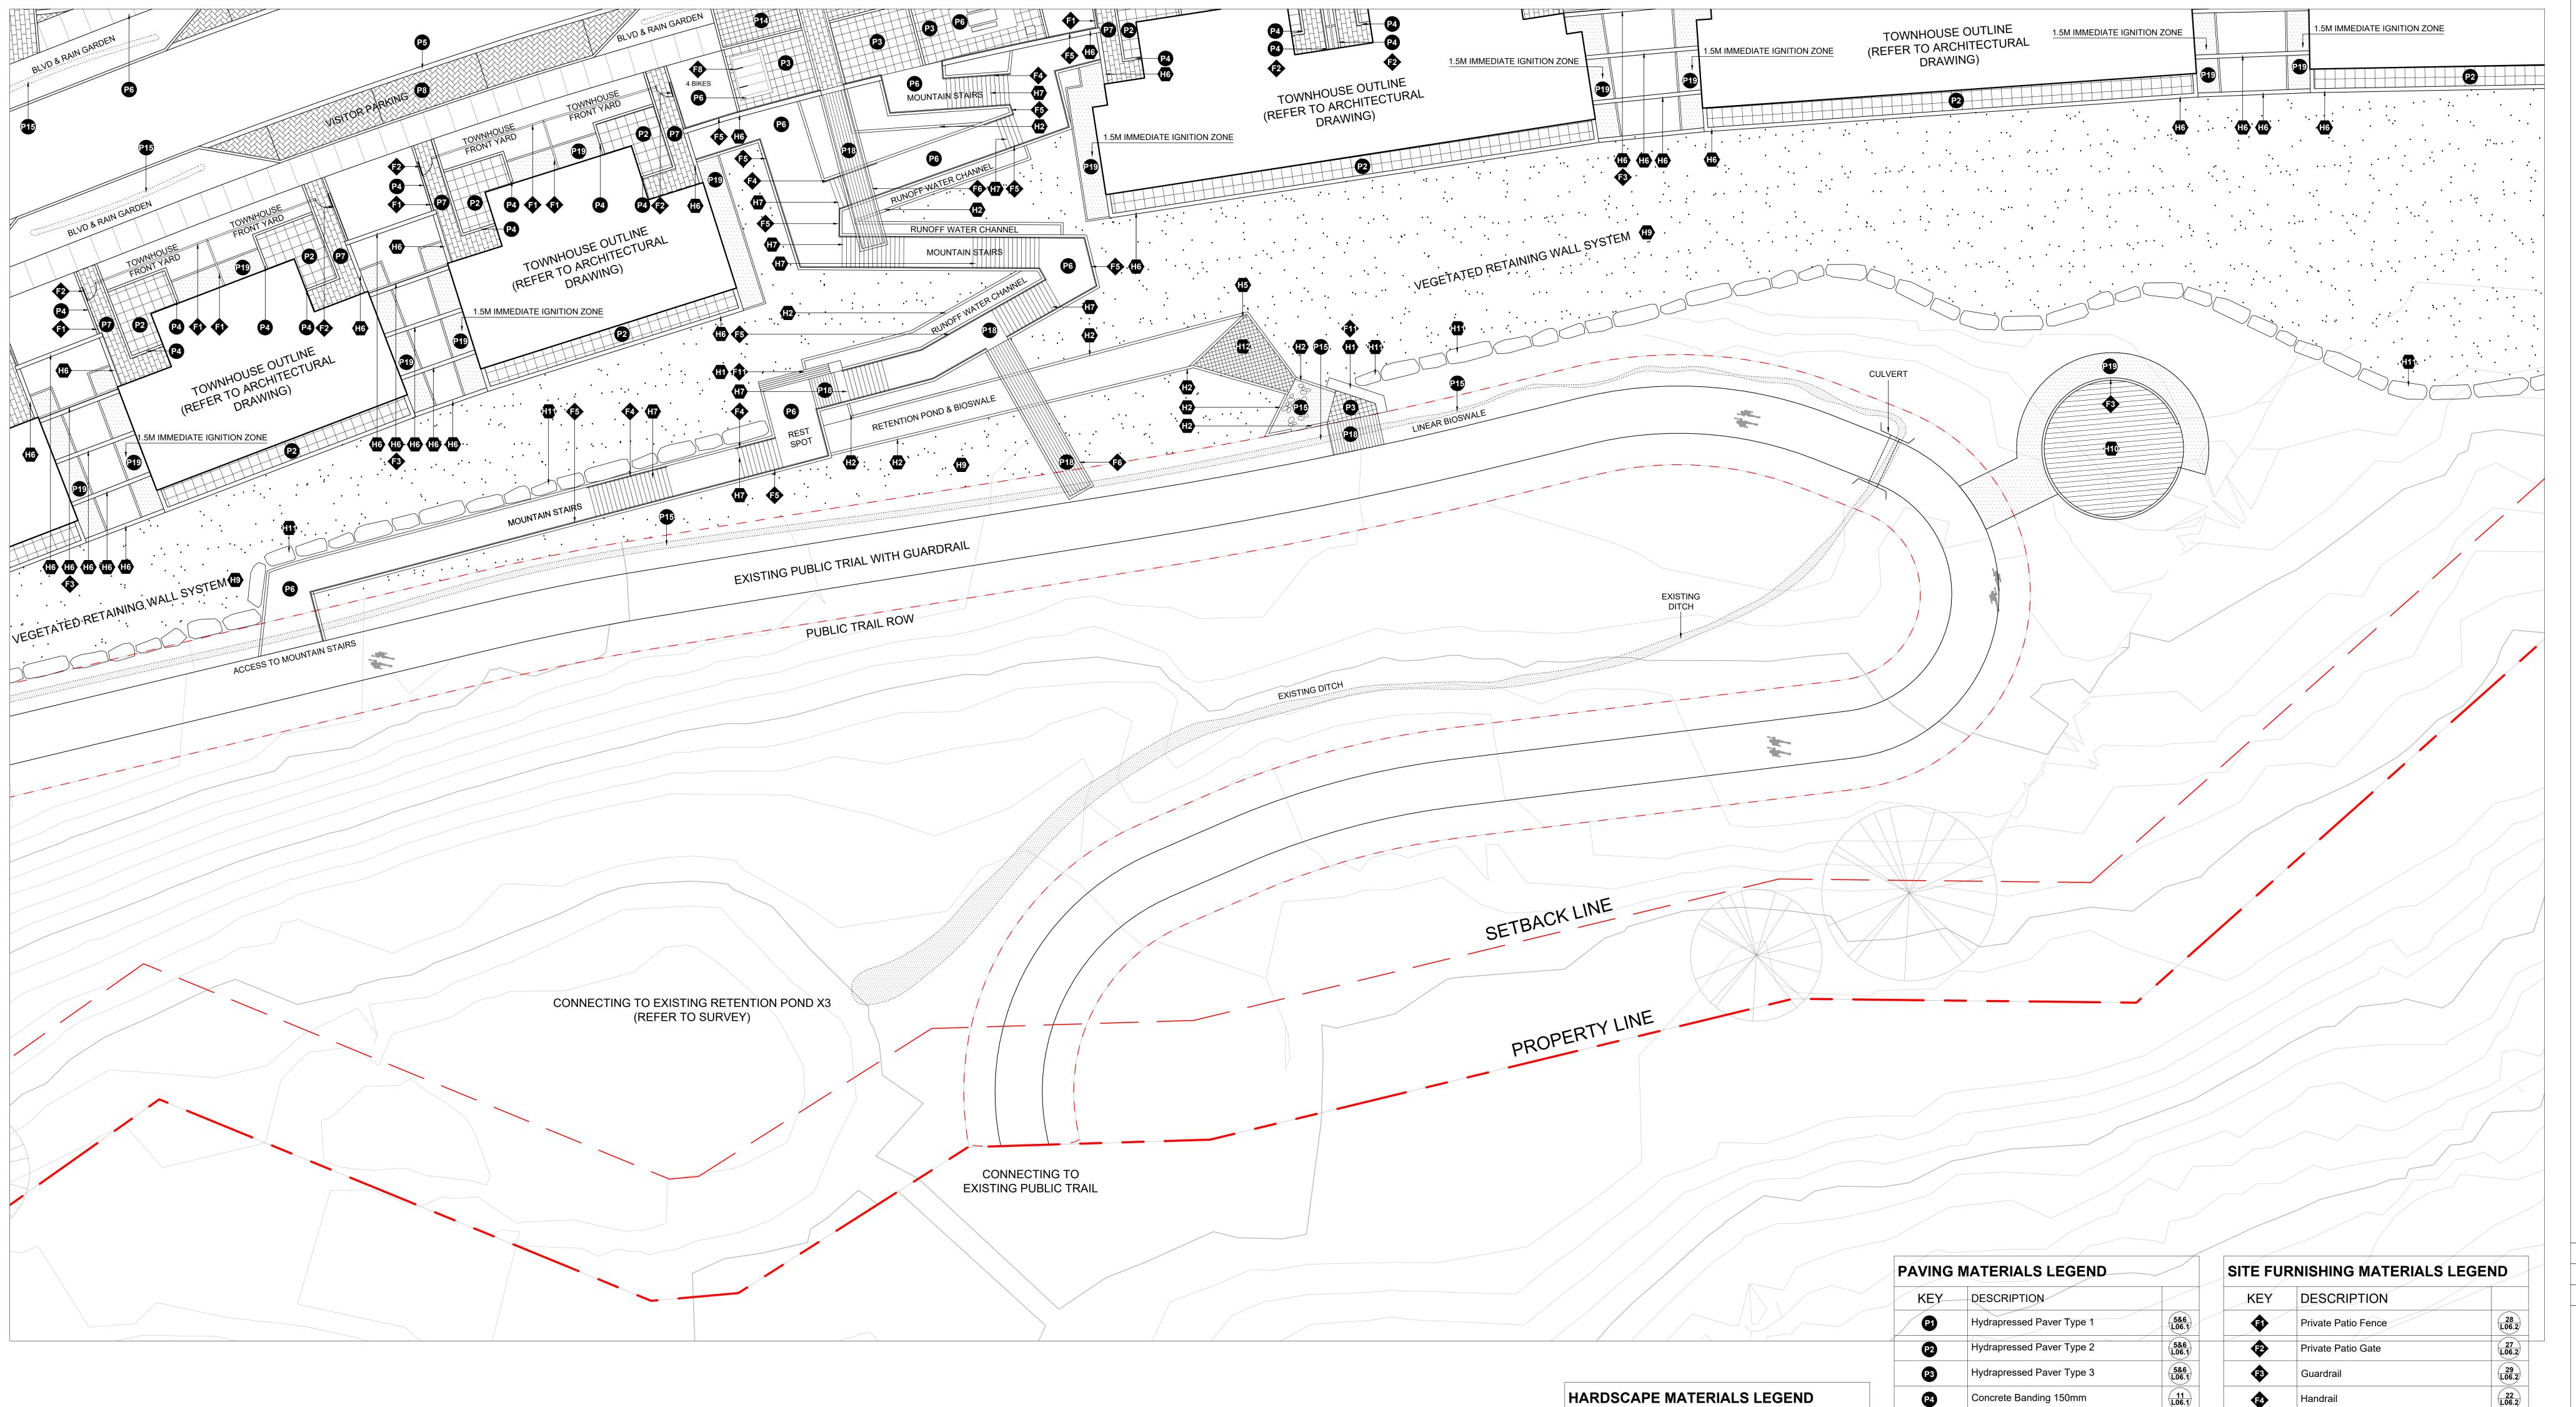
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Drawing Title

LANDSCAPE MATERIAL PLAN

Drawing No.





KEY DESCRIPTION

CIP Concrete Seat Wall

CIP Concrete Raised Curb

CIP Concrete Seating Step

CIP Concrete Check Dam

Concrete Retaining Wall

CIP Concrete Stepping Channel

Flex MSE Green Wall System

Patio Screen Wall (Refer to Architectural)

CIP Concrete Stairs

Timber Plateform

Boulder Edging

Basalt Setts Wall

Extensive Green Roof

Concrete Wall with Project Sign&Address

					/
AVING	MATERIALS LEGEND		SITE FU	RNISHING MATERIALS L	EGEND
KEY	DESCRIPTION		KEY	DESCRIPTION	
P1	Hydrapressed Paver Type 1	5&6 L06.1	13	Private Patio Fence	2 L00
P2	Hydrapressed Paver Type 2	5&6 L06.1	E2	Private Patio Gate	2 L00
P3	Hydrapressed Paver Type 3	5&6 L06.1	3	Guardrail	(2) (L00
P4	Concrete Banding 150mm	11 L06.1	2	Handrail	2 L00
P5	Concrete Banding 300mm	11 L06.1	4 5	Handrail & Guardrail	3 L00
P6	CIP Concrete Paving	788 L06.1	E 5	Pedestrian Viewing Dock	3 L00
P7	Concrete Unit Paver Type 1	183 L06.1	•	Pavilion	3 L00
P8	Concrete Unit Paver Type 2	284 L06.1	₹3	Class 2 Bike Rack	3 L00
P9	Concrete Unit Paver Type 3	1&3 L06.1	1	Bike Pump Station	4- L06
P10	Concrete Unit Paver Type 4	1&3 L06.1	1 0	Bench	36/ L00
P11	Granite Paver Type 1	15&17 L06.1	1	Seat Wall Bench	2 L00
P12	Granite Paver Type 2	15 L06.1	1 2	Picnic Table	3 L00
P13	Granite Paver Type 3	15 L06.1	1 3>	Drinking Fountain	4 L00
P14	Cobblestone Paver	17 L06.1	1 4	Play Structure	3 L00
P15	Rain Garden Dry Creek Bed	48 L06.5	(-1 5)	Granite Boulder	2 L00
P16	Resilient Surfacing	47 L06.5	₹1 6 >	Movable Planter	4 L00
P17	Asphalt Paving (Refer to Civil)			Urban Agriculture Planter	4 L00
P18	Metal Granite Paving Panel	46 L06.5	₹1 8≻	Harvest Table	3 L00
P19	Gravel Surfacing	19 L06.1	19	Outdoor Table & Chair Set	4 L00

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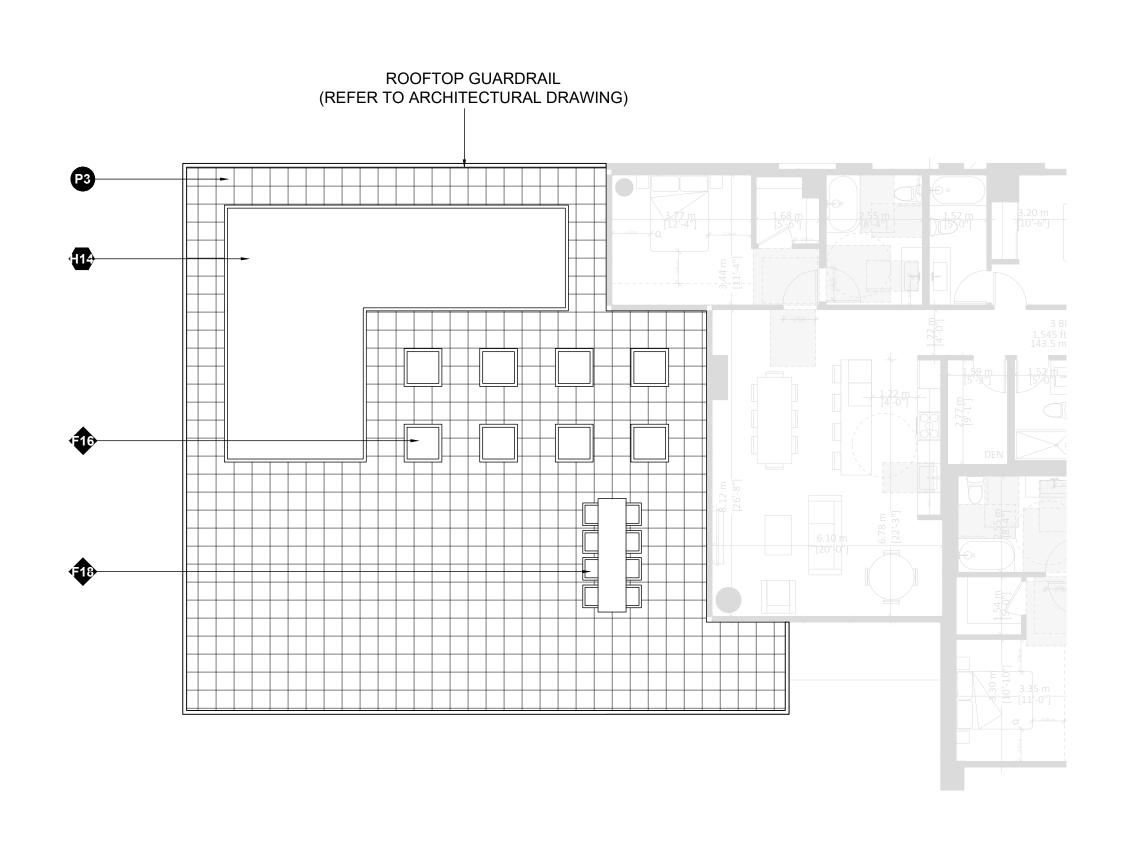


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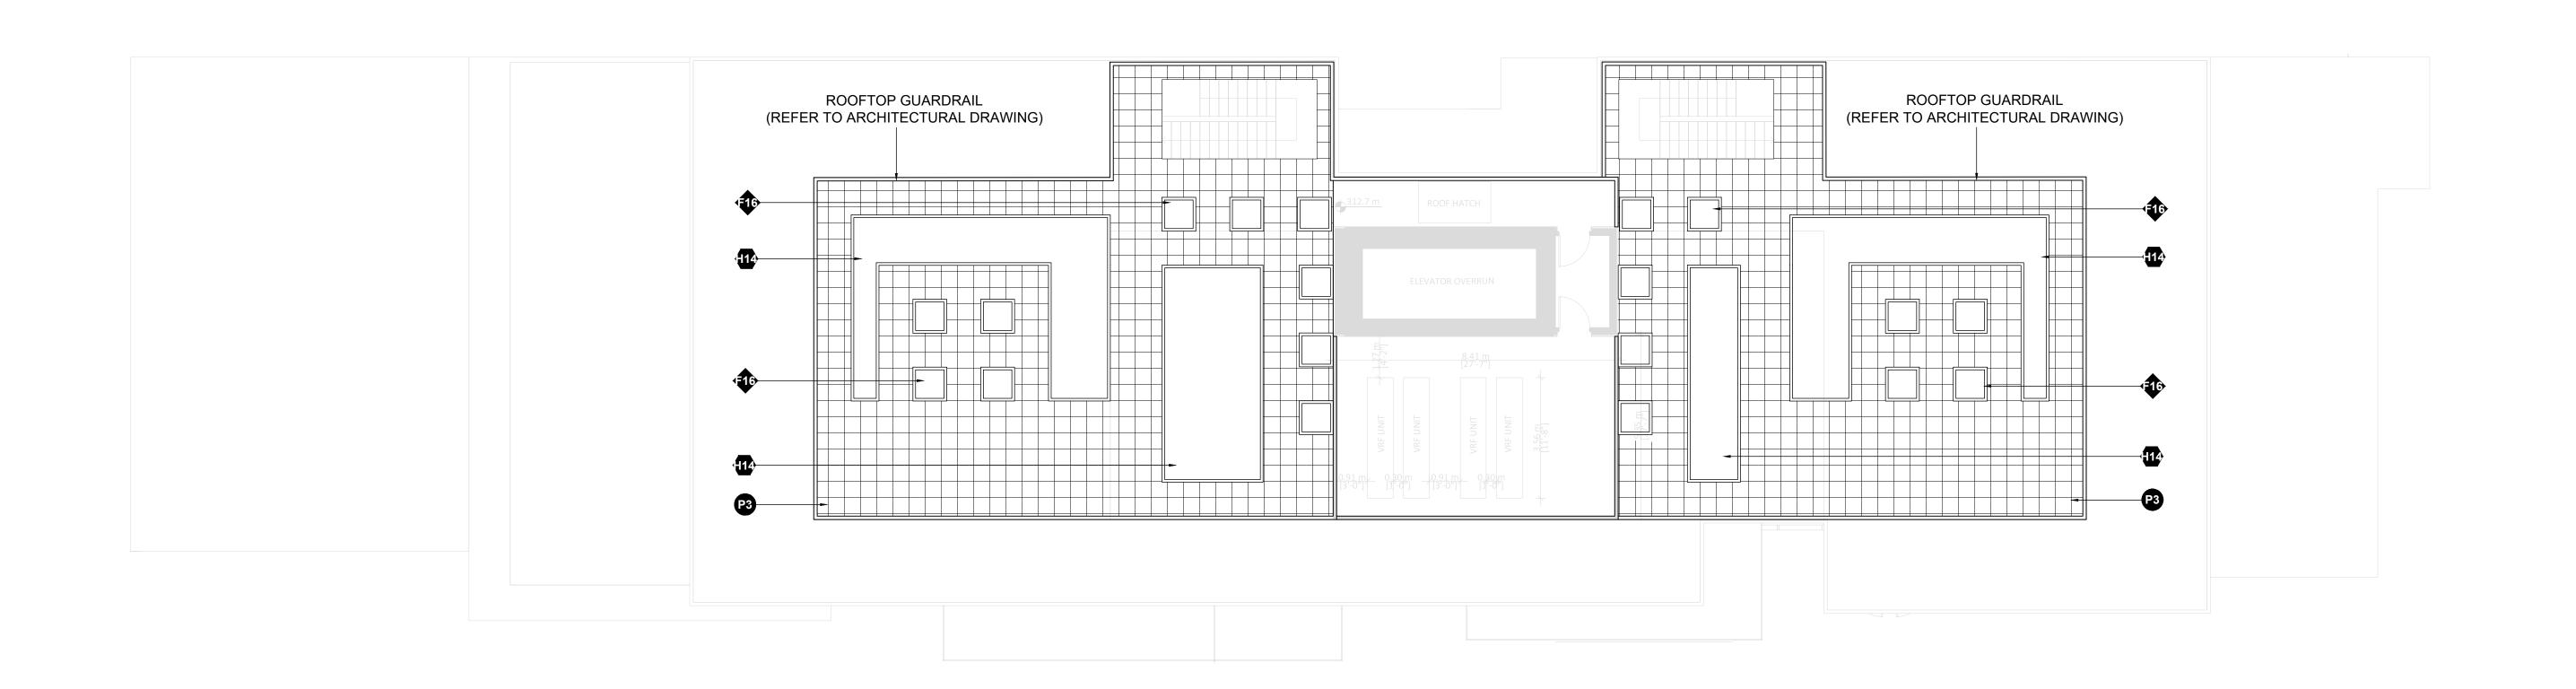
KEY	DESCRIPTION		KEY	DESCRIPTION	
(1)	Private Patio Fence	28 L06.2	P1	Hydrapressed Paver Type 1	5&6 L06.
P	Private Patio Gate	27 L06.2	P2	Hydrapressed Paver Type 2	5 <u>86</u> L06.
3	Guardrail	29 L06.2	P3	Hydrapressed Paver Type 3	5 <u>86</u> L06.
F 4	Handrail	22 L06.2	P4	Concrete Banding 150mm	11 L06.
(3)	Handrail & Guardrail	33 L06.3	P5	Concrete Banding 300mm	11 L06.
F6	Pedestrian Viewing Dock	35 L06.4	P6	CIP Concrete Paving	7&8 L06.1
*	Pavilion	30 L06.3	P 7	Concrete Unit Paver Type 1	1&3 L06.1
F8	Class 2 Bike Rack	39 L06.4	P8	Concrete Unit Paver Type 2	2&4 L06.1
P	Bike Pump Station	44 L06.5	P9	Concrete Unit Paver Type 3	1 <u>8</u> 3 L06.1
10	Bench	36/37 L06.4	P10	Concrete Unit Paver Type 4	1&3 L06.1
1	Seat Wall Bench	26 L06.2	P1	Granite Paver Type 1	15&1 L06.1
12	Picnic Table	38 L06.4	P12	Granite Paver Type 2	15 L06.1
1 3	Drinking Fountain	43 L06.5	P13	Granite Paver Type 3	15 L06.1
14	Play Structure	31 L06.3	P14	Cobblestone Paver	17 L06.1
1	Granite Boulder	23 L06.2	P15	Rain Garden Dry Creek Bed	48 L06.5
16	Movable Planter	40 L06.5	P16	Resilient Surfacing	47 L06.5
1	Urban Agriculture Planter	41 L06.5	91 7	Asphalt Paving (Refer to Civil)	
₹1 8 •	Harvest Table	38 L06.4	P18	Metal Granite Paving Panel	46 L06.5
1	Outdoor Table & Chair Set	42 L06.5	P19	Gravel Surfacing	19 L06.

HARDSC	CAPE MATERIALS LEGEND	
KEY	DESCRIPTION	
(II)	CIP Concrete Seat Wall	26 L06.2
H2	CIP Concrete Raised Curb	20 L06.2
H3	Concrete Wall with Project Sign&Address	49 L06.5
H4	CIP Concrete Seating Step	52 L06.2
H5	CIP Concrete Check Dam	51 L06.5
H6	Concrete Retaining Wall	20 L06.2
H7	CIP Concrete Stairs	21 L06.2
H 8	CIP Concrete Stepping Channel	33 L06.3
H9	Flex MSE Green Wall System	25 L06.2
410	Timber Plateform	34 L06.4
(11)	Boulder Edging	53 L06.5
112	Basalt Setts Wall	50 L06.5
H13	Patio Screen Wall (Refer to Architectural)	
	Extensive Green Roof	45 L06.5

TOWER 1. 2. 3. LEVEL 6 TYP.



TOWER 1. 2. 3. LEVEL 13 TYP.



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RODGERS CREEK AREA 5




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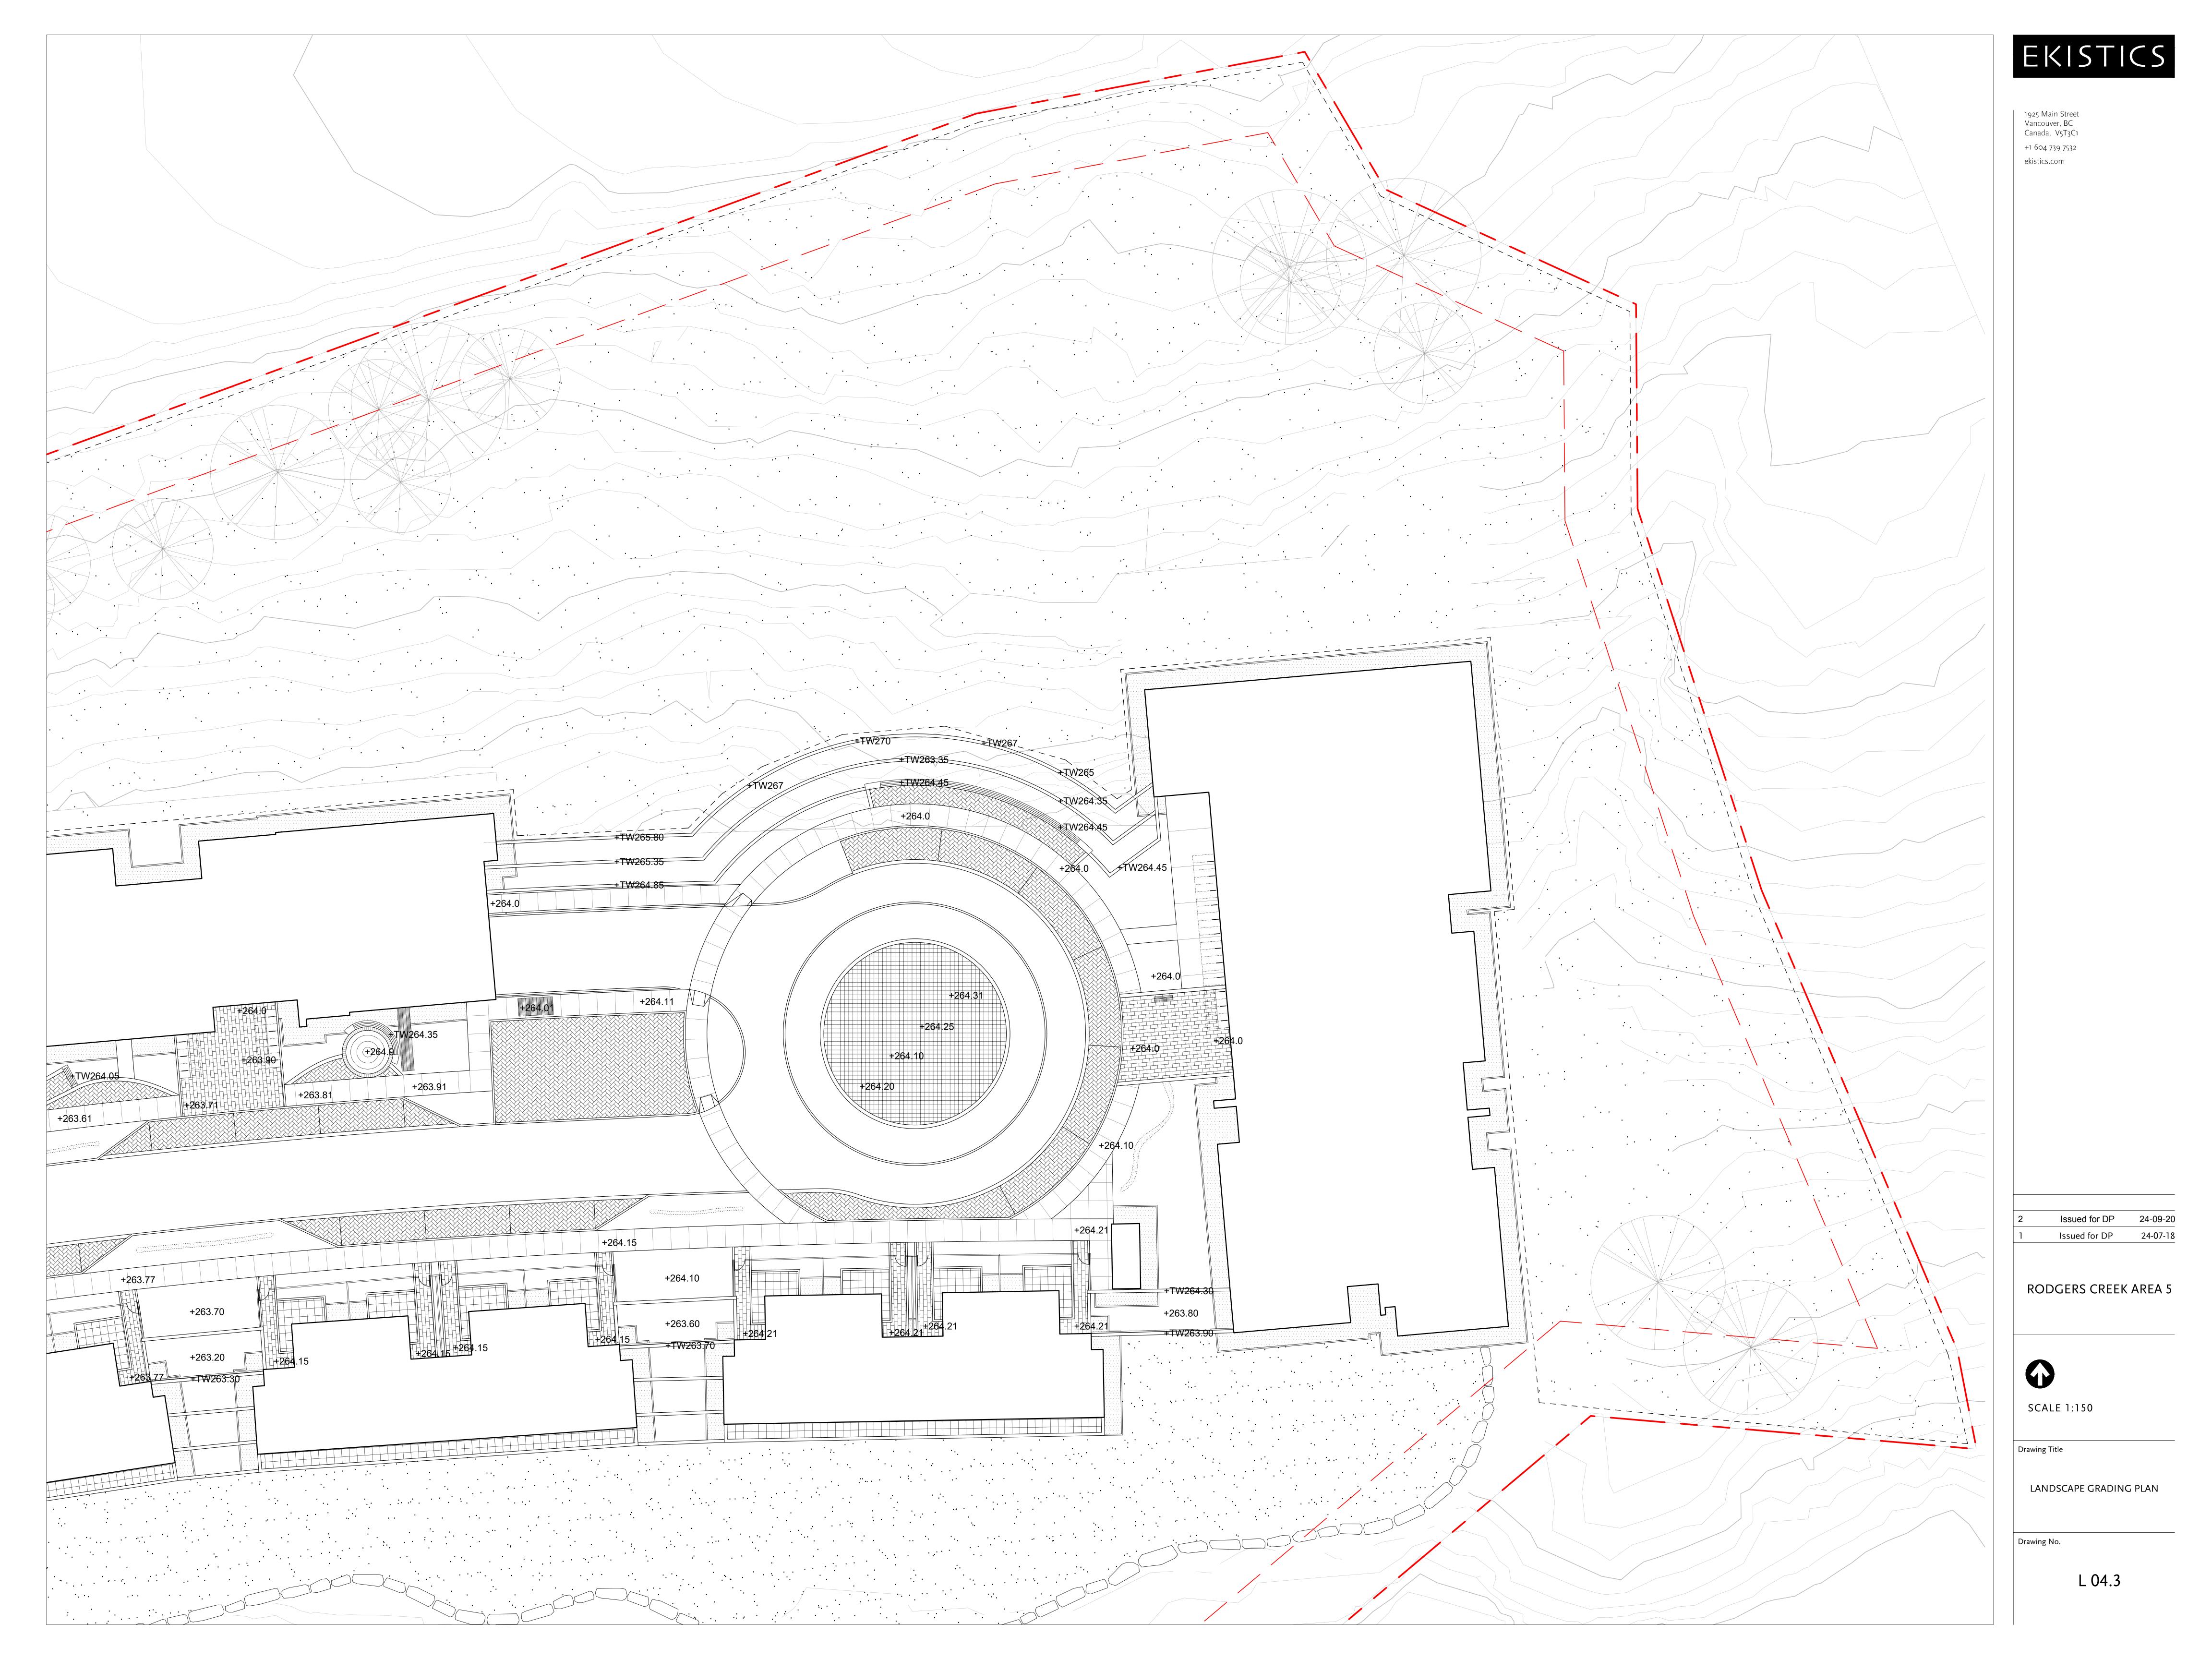
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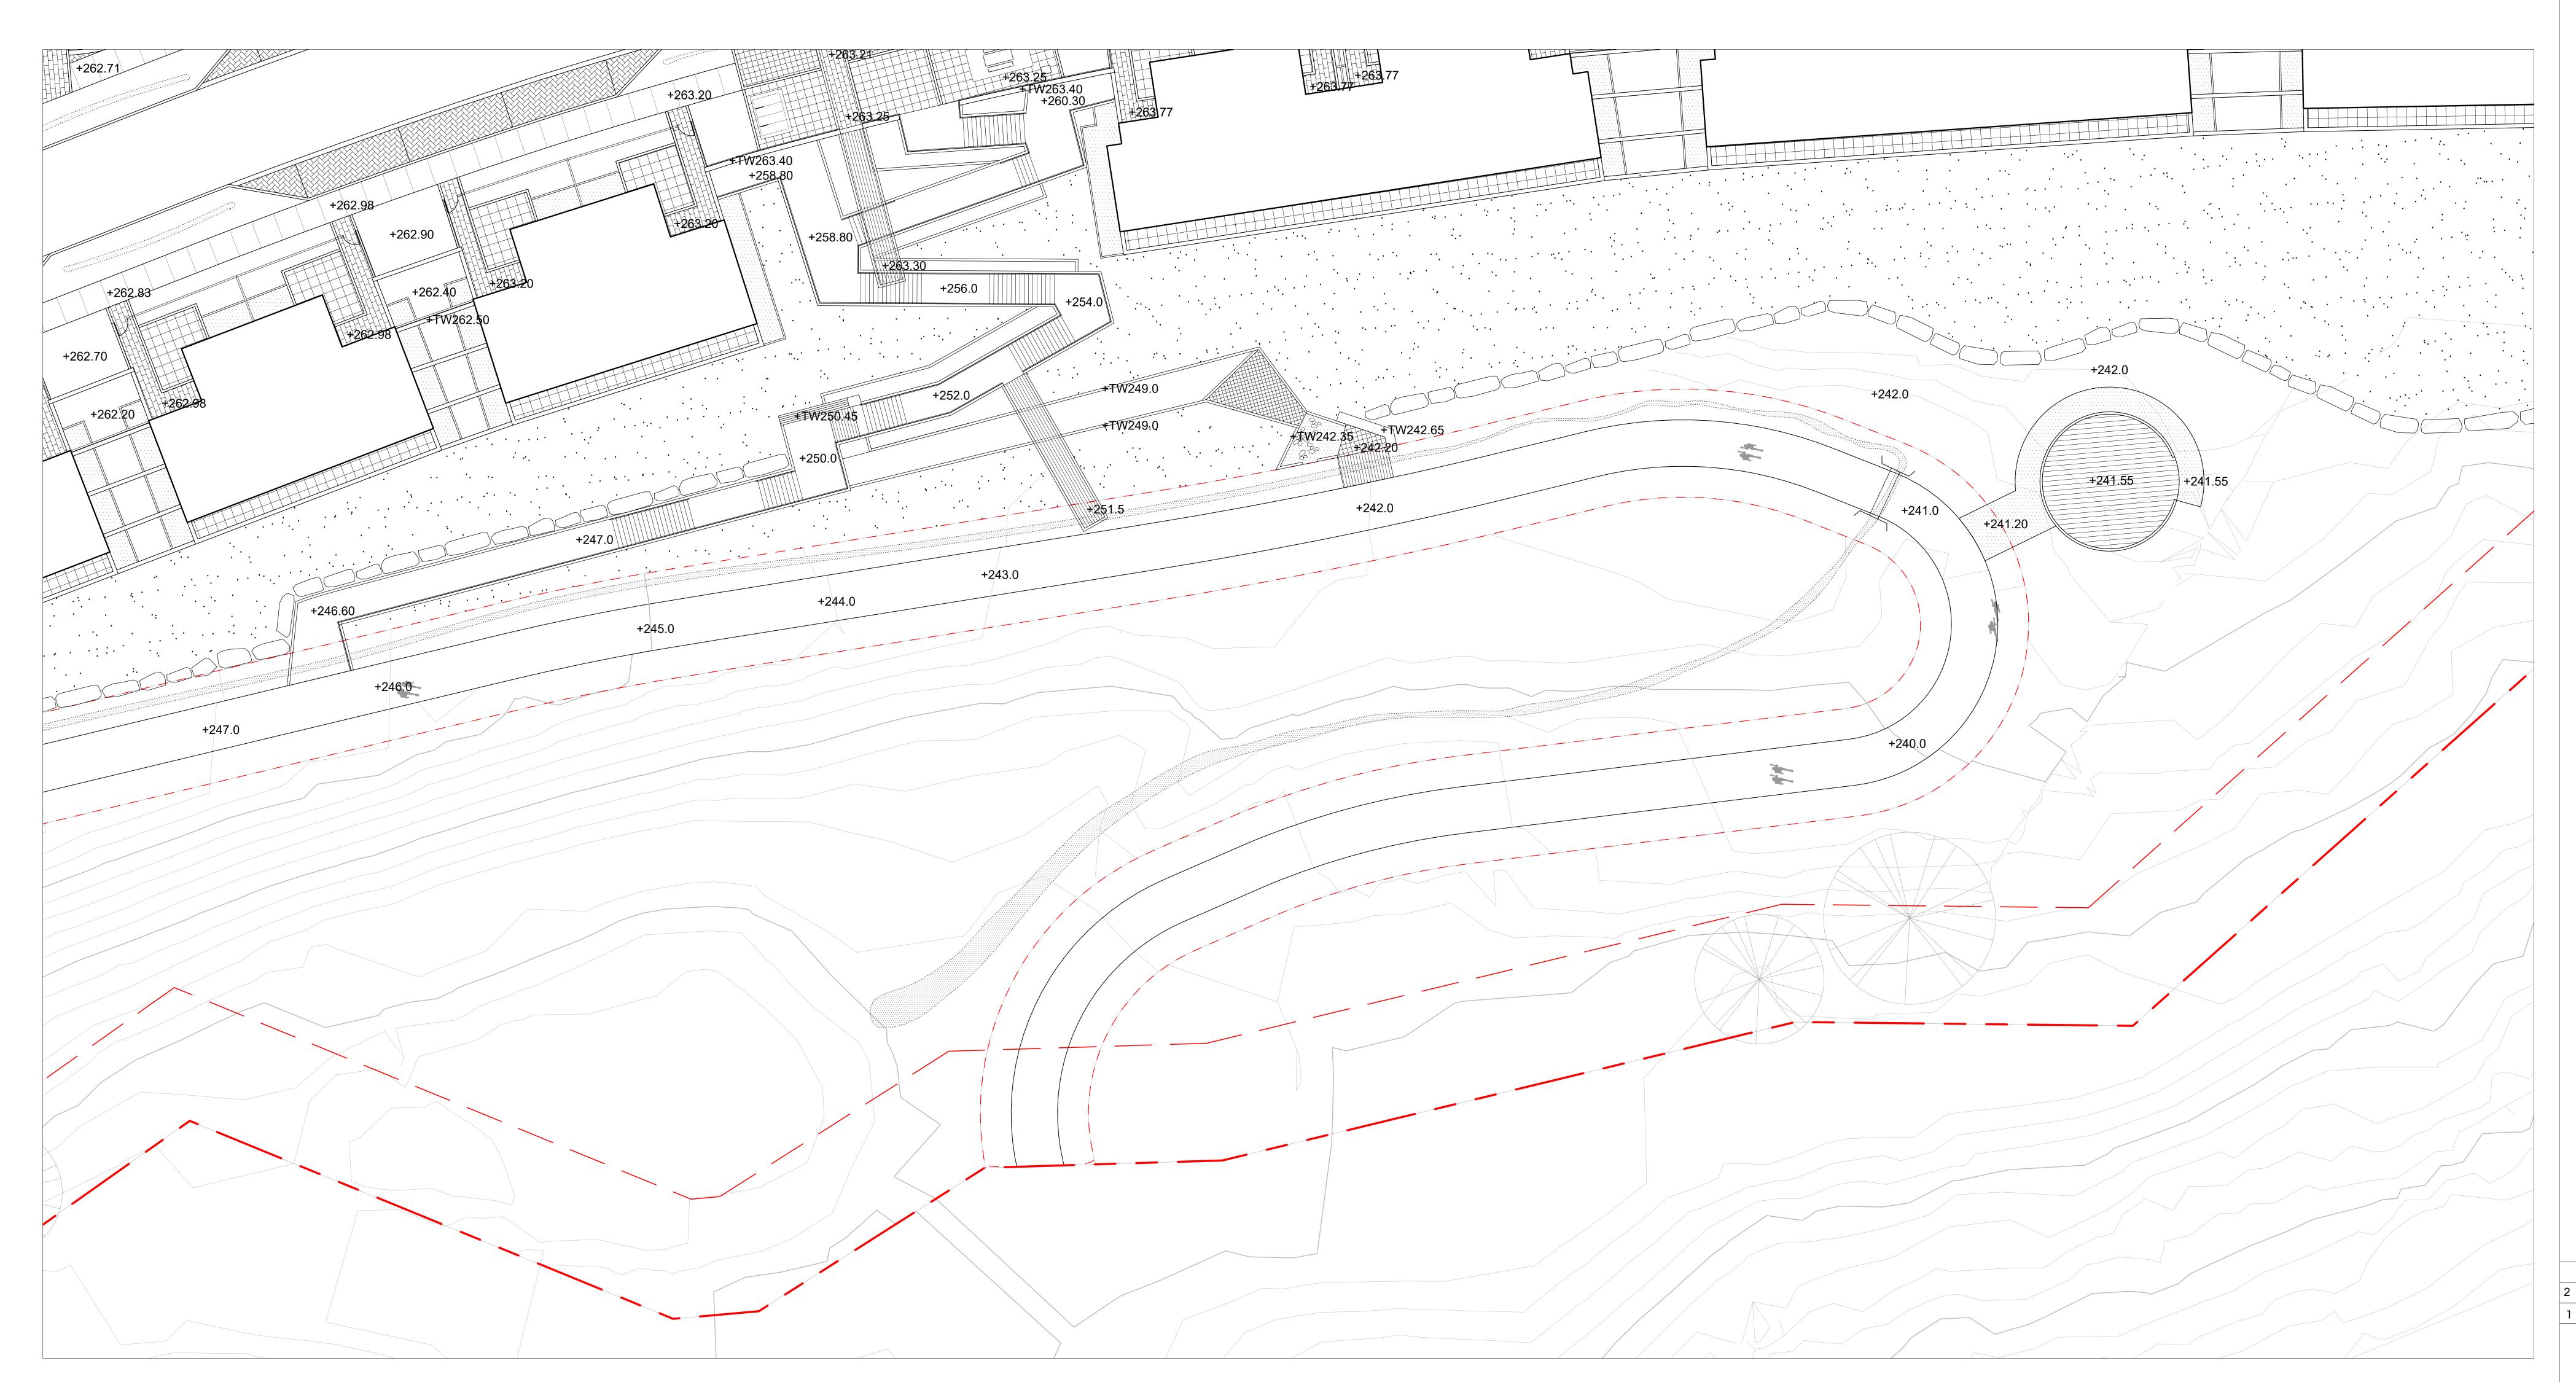
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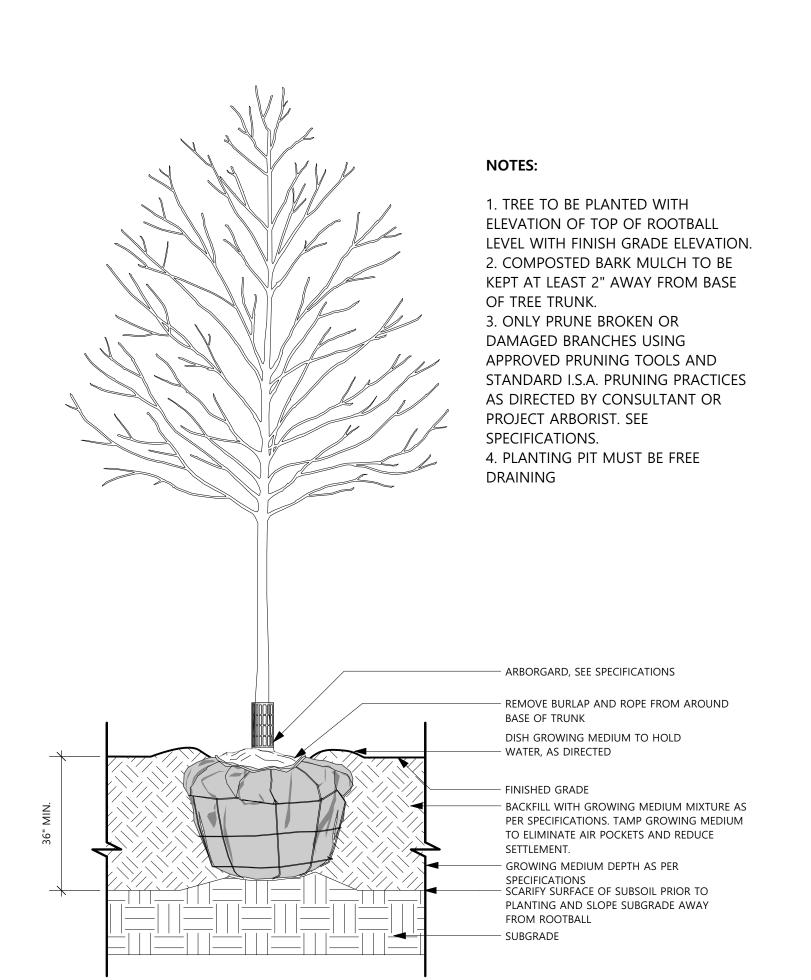
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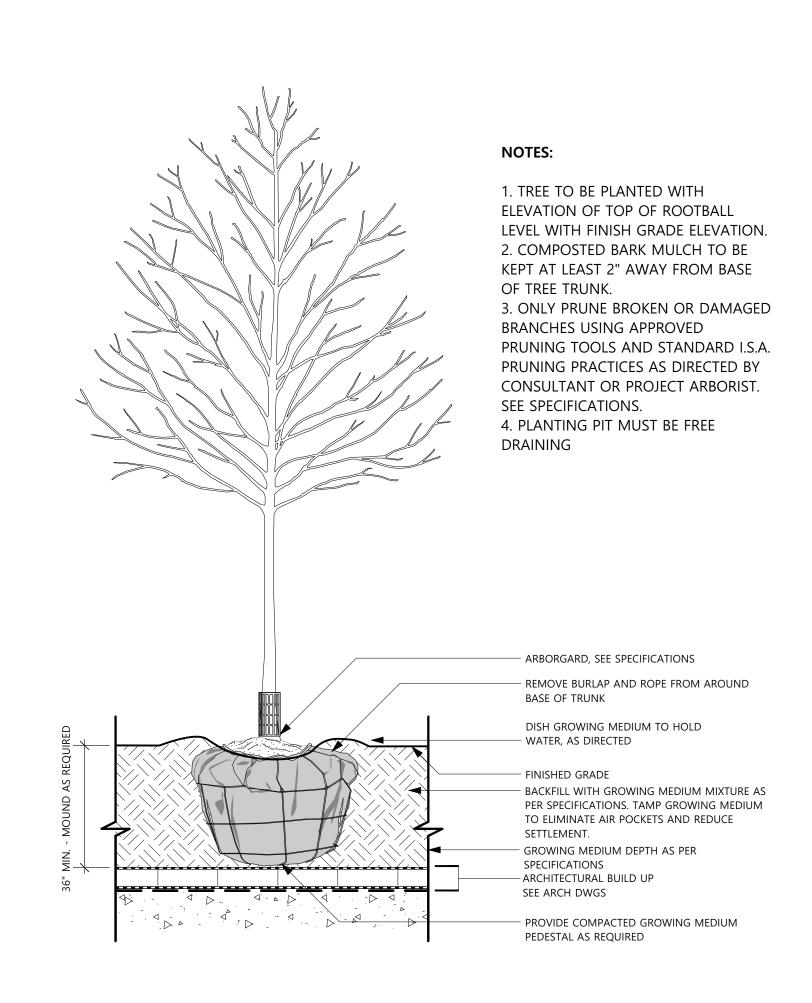
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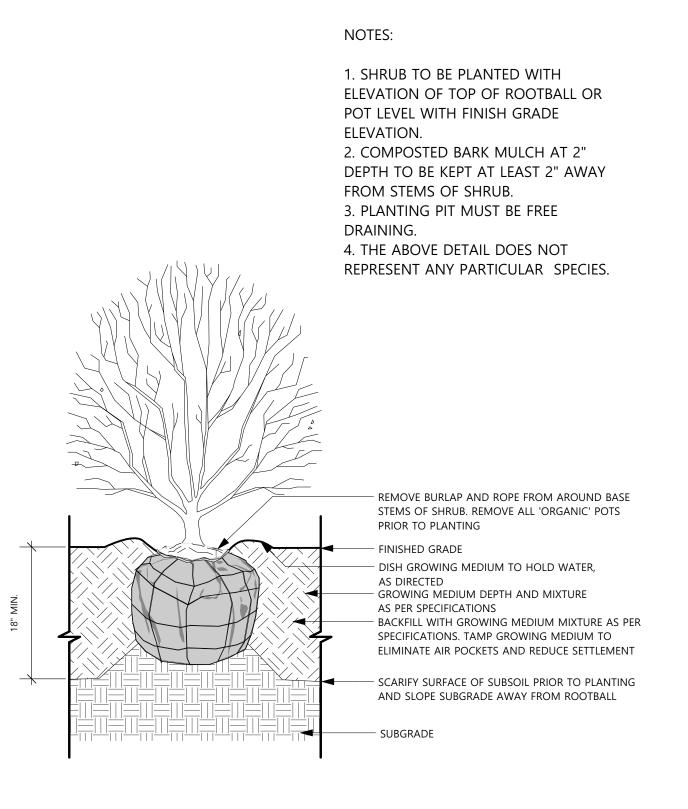
LANDSCAPE GRADING PLAN


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ENTIRE	SITE					
ID	Qty	Botanical Name Co	mmon Name	Scheduled Size	Spacing	Remarks
		Trees				
ACR	12	Acer circinatum Vine	e Maple	3.0 m ht. (10'-0" ht.)	As Shown	B&B, Nursery grown, minimum 3 stems
APL	8	Acer palmatum 'Green' Green'	en Japanese Maple	3.0 m ht. x 1.8 m w. (10'ht	. As Shown	B&B, Specimen and densely branched, no included ba
ABW	8	Acer rubrum 'Brandy Wine' Bran	ndy Wine Red Mapie	7 cm cal. (2 1/2" cal.)	As Shown	B&B, Uniform branching, dense tree, 7' (2.1 m) std.
ARU	15	Acer rubrum 'Somerset' Som	nerset Red Maple	8 cm cal. (3" cal.)	As Shown	B&B, Uniform branching, dense tree, 7' (2.1 m) std.
SD	14	Fagus syivatica 'Dawykir' Daw	vykii European Beech	8 cm cal. (3" cal.)	As Shown	B&B,Uniform branching,dense tree, 7'(2.1 m) std.
QG	24	3 ,	ry Oak	8 cm cal. (3" cal.)	As Shown	B&B, Uniform branching, dense tree, 7' (2.1 m) std.
PTR	21	·	aking Aspen	5 cm cal. (2" cal.)	As Shown	B&B, Well branched, dense tree, 5' (1 .5 m) std nurse
QPL	40	• 1	Oak	8 cm cal. (3" cal.)	As Shown	B&B, Uniform branching, dense tree, 7'(2.1 m) std.
SJC	33		anese Snowbell	5 cm cal. (2" cal.)	As Shown	B&B,Uniform branching, dense tree, o'(1.8rm) std.
CKS	16	Cornus kousa 'Satomi' Sato	omi Dogwood	5 cm cal. (2" cal)	As Shown	B&B, Uniform branching, dense tree, 6' (1.8m) std.
	F-7	Shrubs			(2.41)	
AEG	57 45		vard Goucher Abelia	#2	60cm (24")	Well established
AUC PAAAA	45 255	•	npact Strawberry Tree	#3 pot	90cm (36")	Well established
3MW	255	1 /	nter Gem Boxwood	#3 pot	38cm (15")	Well established
CTR	386 159	•	xican Orange Blossom	#3 pot	60 cm (24")	Well established pursory grown
CSK HGR	195	, and the second se	seyii Dogwood ak Leaf Hydrangea	#2 pot #3 pot	60 cm (24") 75 cm (30")	Well established, nursery grown Well established
KLM	173	, .	ah Mountain Laurel	#2 pot	107 cm (42")	Well established
.PL	820		ret Honeysuckle	#1 pot	45 cm (18")	30 cm(12") spread
EAC	45	•	ning Bush	"		Well established
RSA	294	·	wering Currant	#3 pot	75 cm (30")	Well established, nursery grown
SBA	69	•	hony Waterer Spiraea	#2 pot	75 cm (30")	Well established
SBG	180	·	aname Spiraea	#2 pot	60 cm (24")	Well established
CA	146	•	oneaster	#3 pot	,	Well established
CO	426	Ceanothus ovatus Sma	aller Red-Root	12m-	40 cm (16")	Well established, denso hedging plant / B &, B
VOT	653	Vaccinium ovatum 'Thunderbird' Thu	inderbird Evergreen Huckleberry	#3 pot	60 cm (24")	Well established, nursery grown
VDV	374	Viburnum davidii Dav	vid Viburnum	#2 pot	60 cm (24")	Well established
		Ground Cover				
CCN	1486	Cornus canadensis Bun	nchberry	#1 pot		8cm (3") height. Well established, nursery grown
EFE	209	Euonymus fortunei 'Emerald Gaiety' Eme	eral Gaiety Wintercreeper	#1 pot	38 cm (15")	25cm (10") spread. Minimum 3 leads
_S	974	Liriope spicatum Lily-	-turf	#1 pot	30 cm (12")	Well established
ИRP	532	Mahonia nervosa Dwa	arf Oregon Grape	#1 pot	45 cm (18")	Well established, nursery grown
PTM	726	Pachysandra terminalis Japa	anese Spurge	#1 pot	38 cm (15")	10cm (4") height
		Perennials				
PR	982	Echinecea purpurea Purp	ple Cone Flower	#1 pot	45 cm (18")	Well established
MAH	291	Hosta 'August Moon' Aug	gust Moon Hosta	#1 pot	60 cm (24")	Well established
.HI	1039	Lavandula angustifolia "Hidcote' Hide	cote Lavender	#1 pot	60 cm (24")	Well established
_SB	493	Leucanthemum superbum 'Becky' Bec	ky Shasta Daisy	#1 pot	38 cm (15")	Well established
NFD	1273	Nepeta x faassenii 'Dropmore Blue' Dro	pmore Blue Catmint	#1 pot	38 cm (15")	Well established
PAF	1185	Perovskia atriplicifolia Rus	sian Sage	#1 pot	38 cm (15")	Well established
Н	640	'	Hybrids	#1 pot	38 cm (15")	Well established
GAGF	769		nket flower	#1 pot	38 cm (15")	Well established
_PS	986		ge-leaf Lupine	#1 pot	38 cm (15")	Well established
ALC	400		dding Onion	#1 pot	30 cm (13)	vven established
-	- 3 5	FERN	<u> </u>	<u> </u>		
 SC	303		y Lavender / Lavender Cotton / Santolina	#1 pot	38 cm (15")	Well established
EN	640	•	bitbrush / Rabbitbush	#1 pot	38 cm (15")	Well established
CP	189		hid Rockrose	#1 pot	38 cm (15")	Well established
- 1	100	Cistas parparcas OIC	THE RUCKIUSE	" I POL		TYCH COMMINICA


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Issued for DP	24-09-20


RODGERS CREEK AREA 5

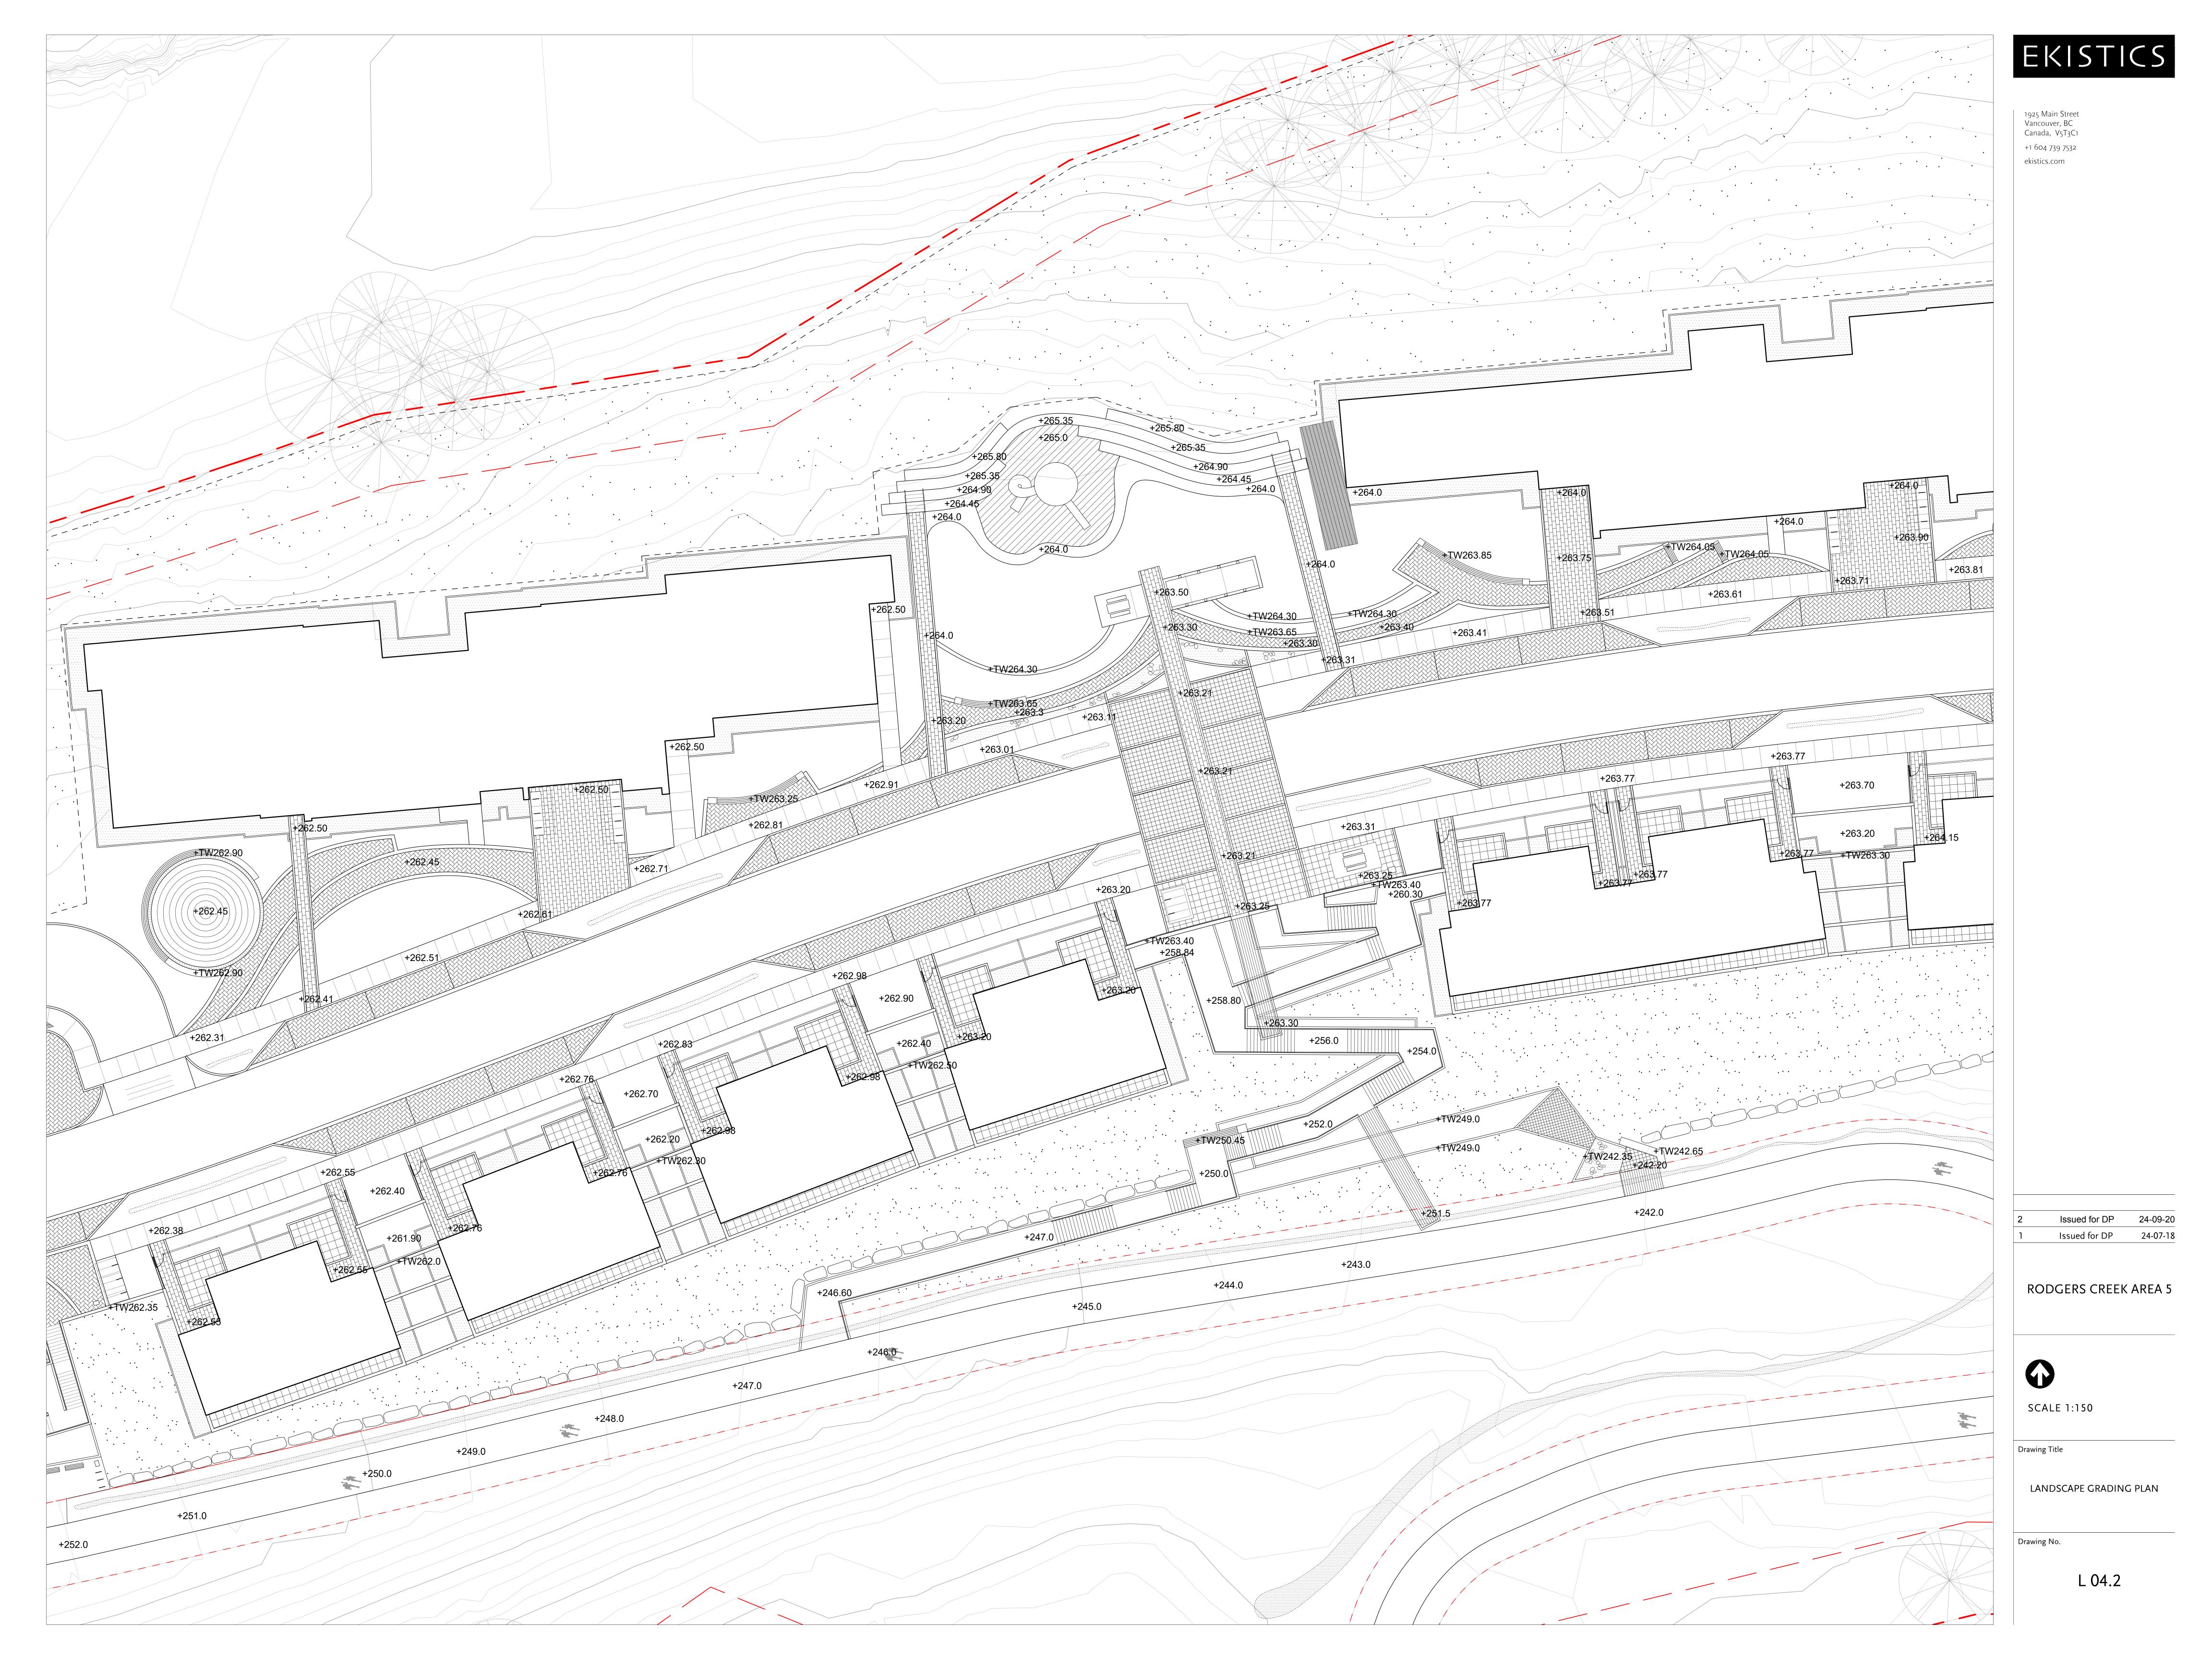



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LANDSCAPE PLANTING PLAN

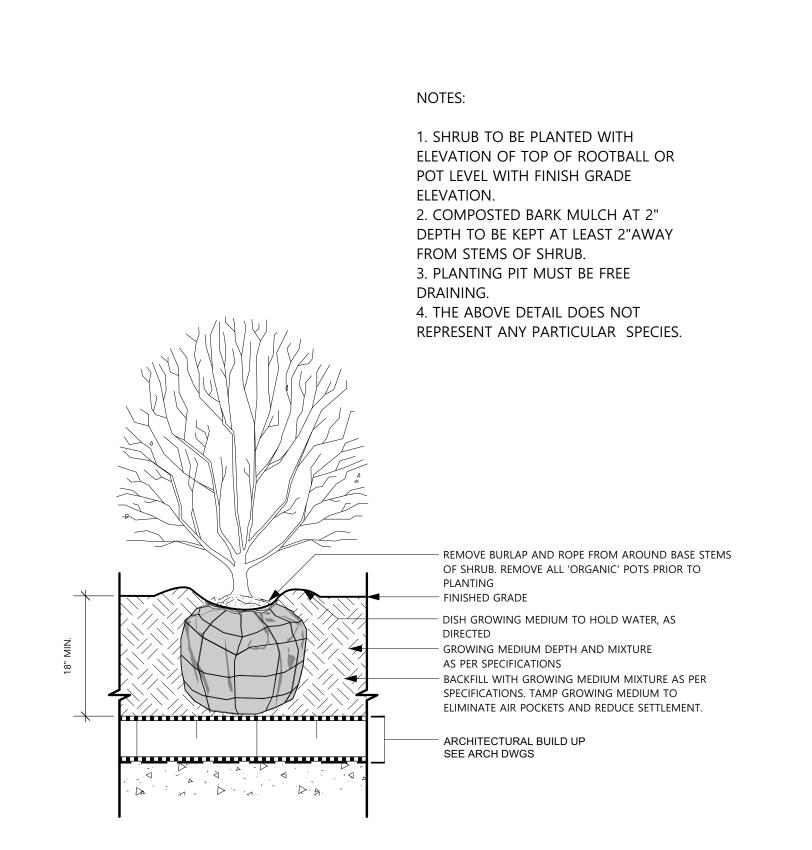

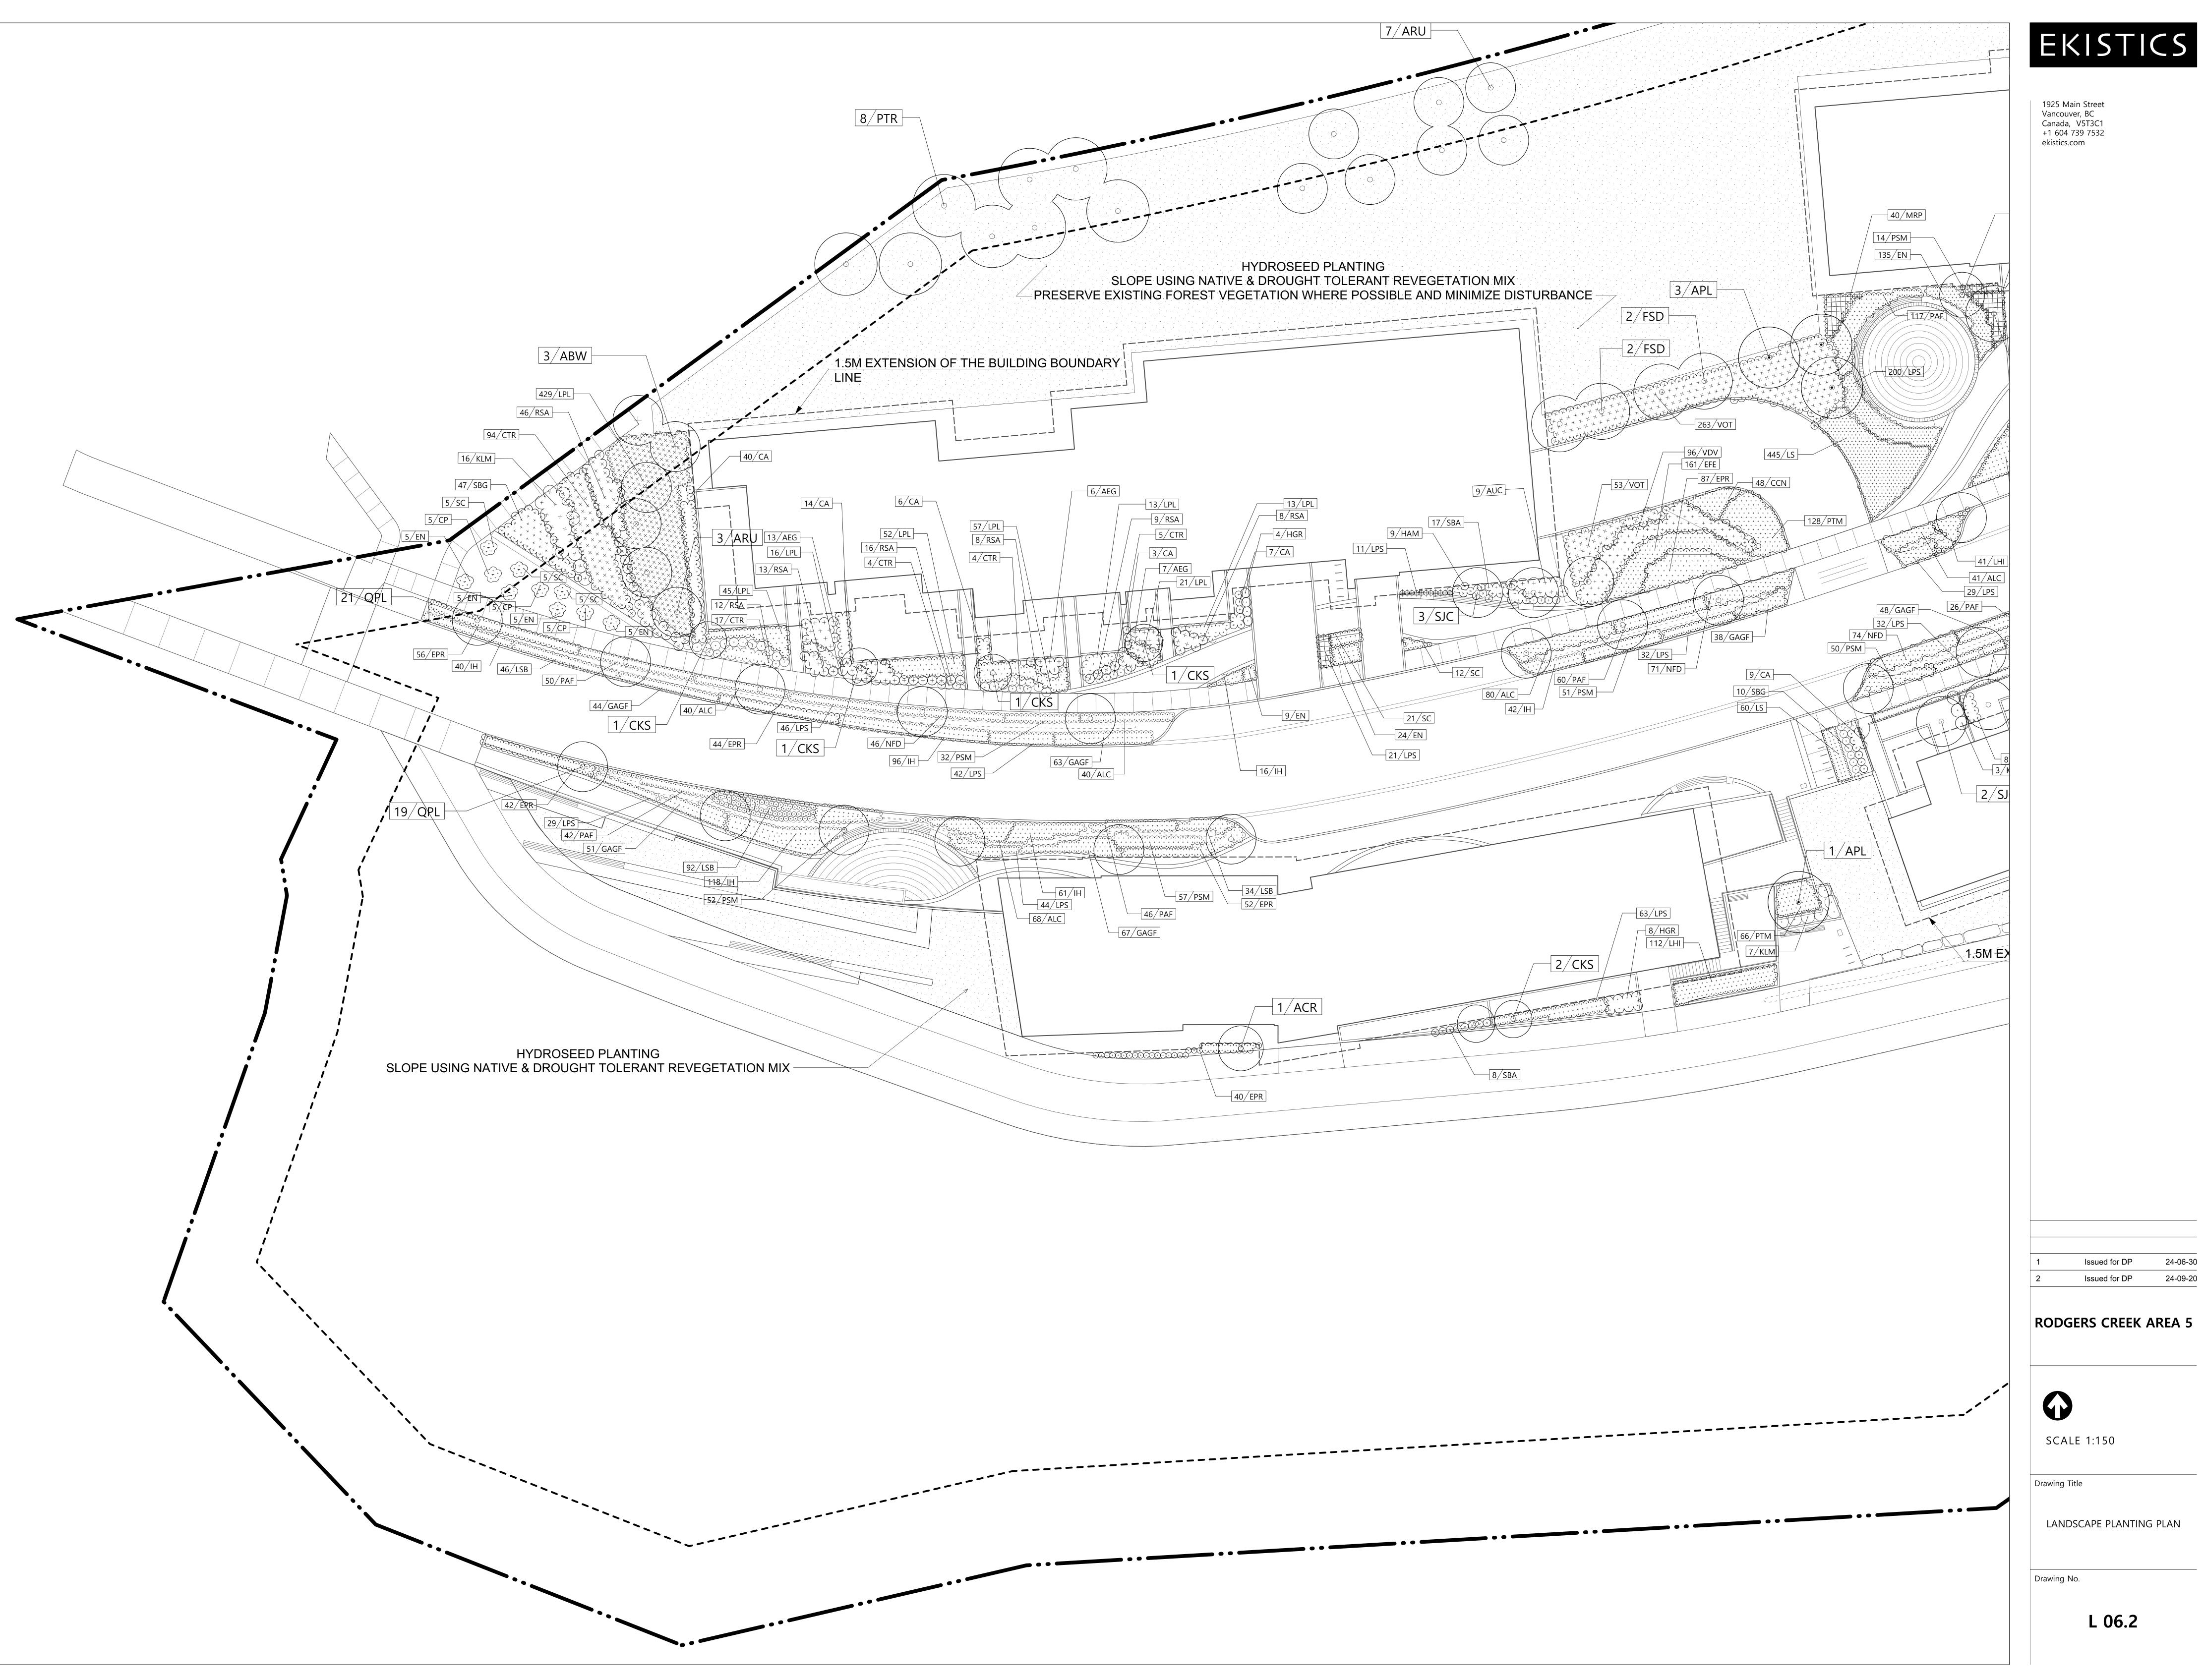

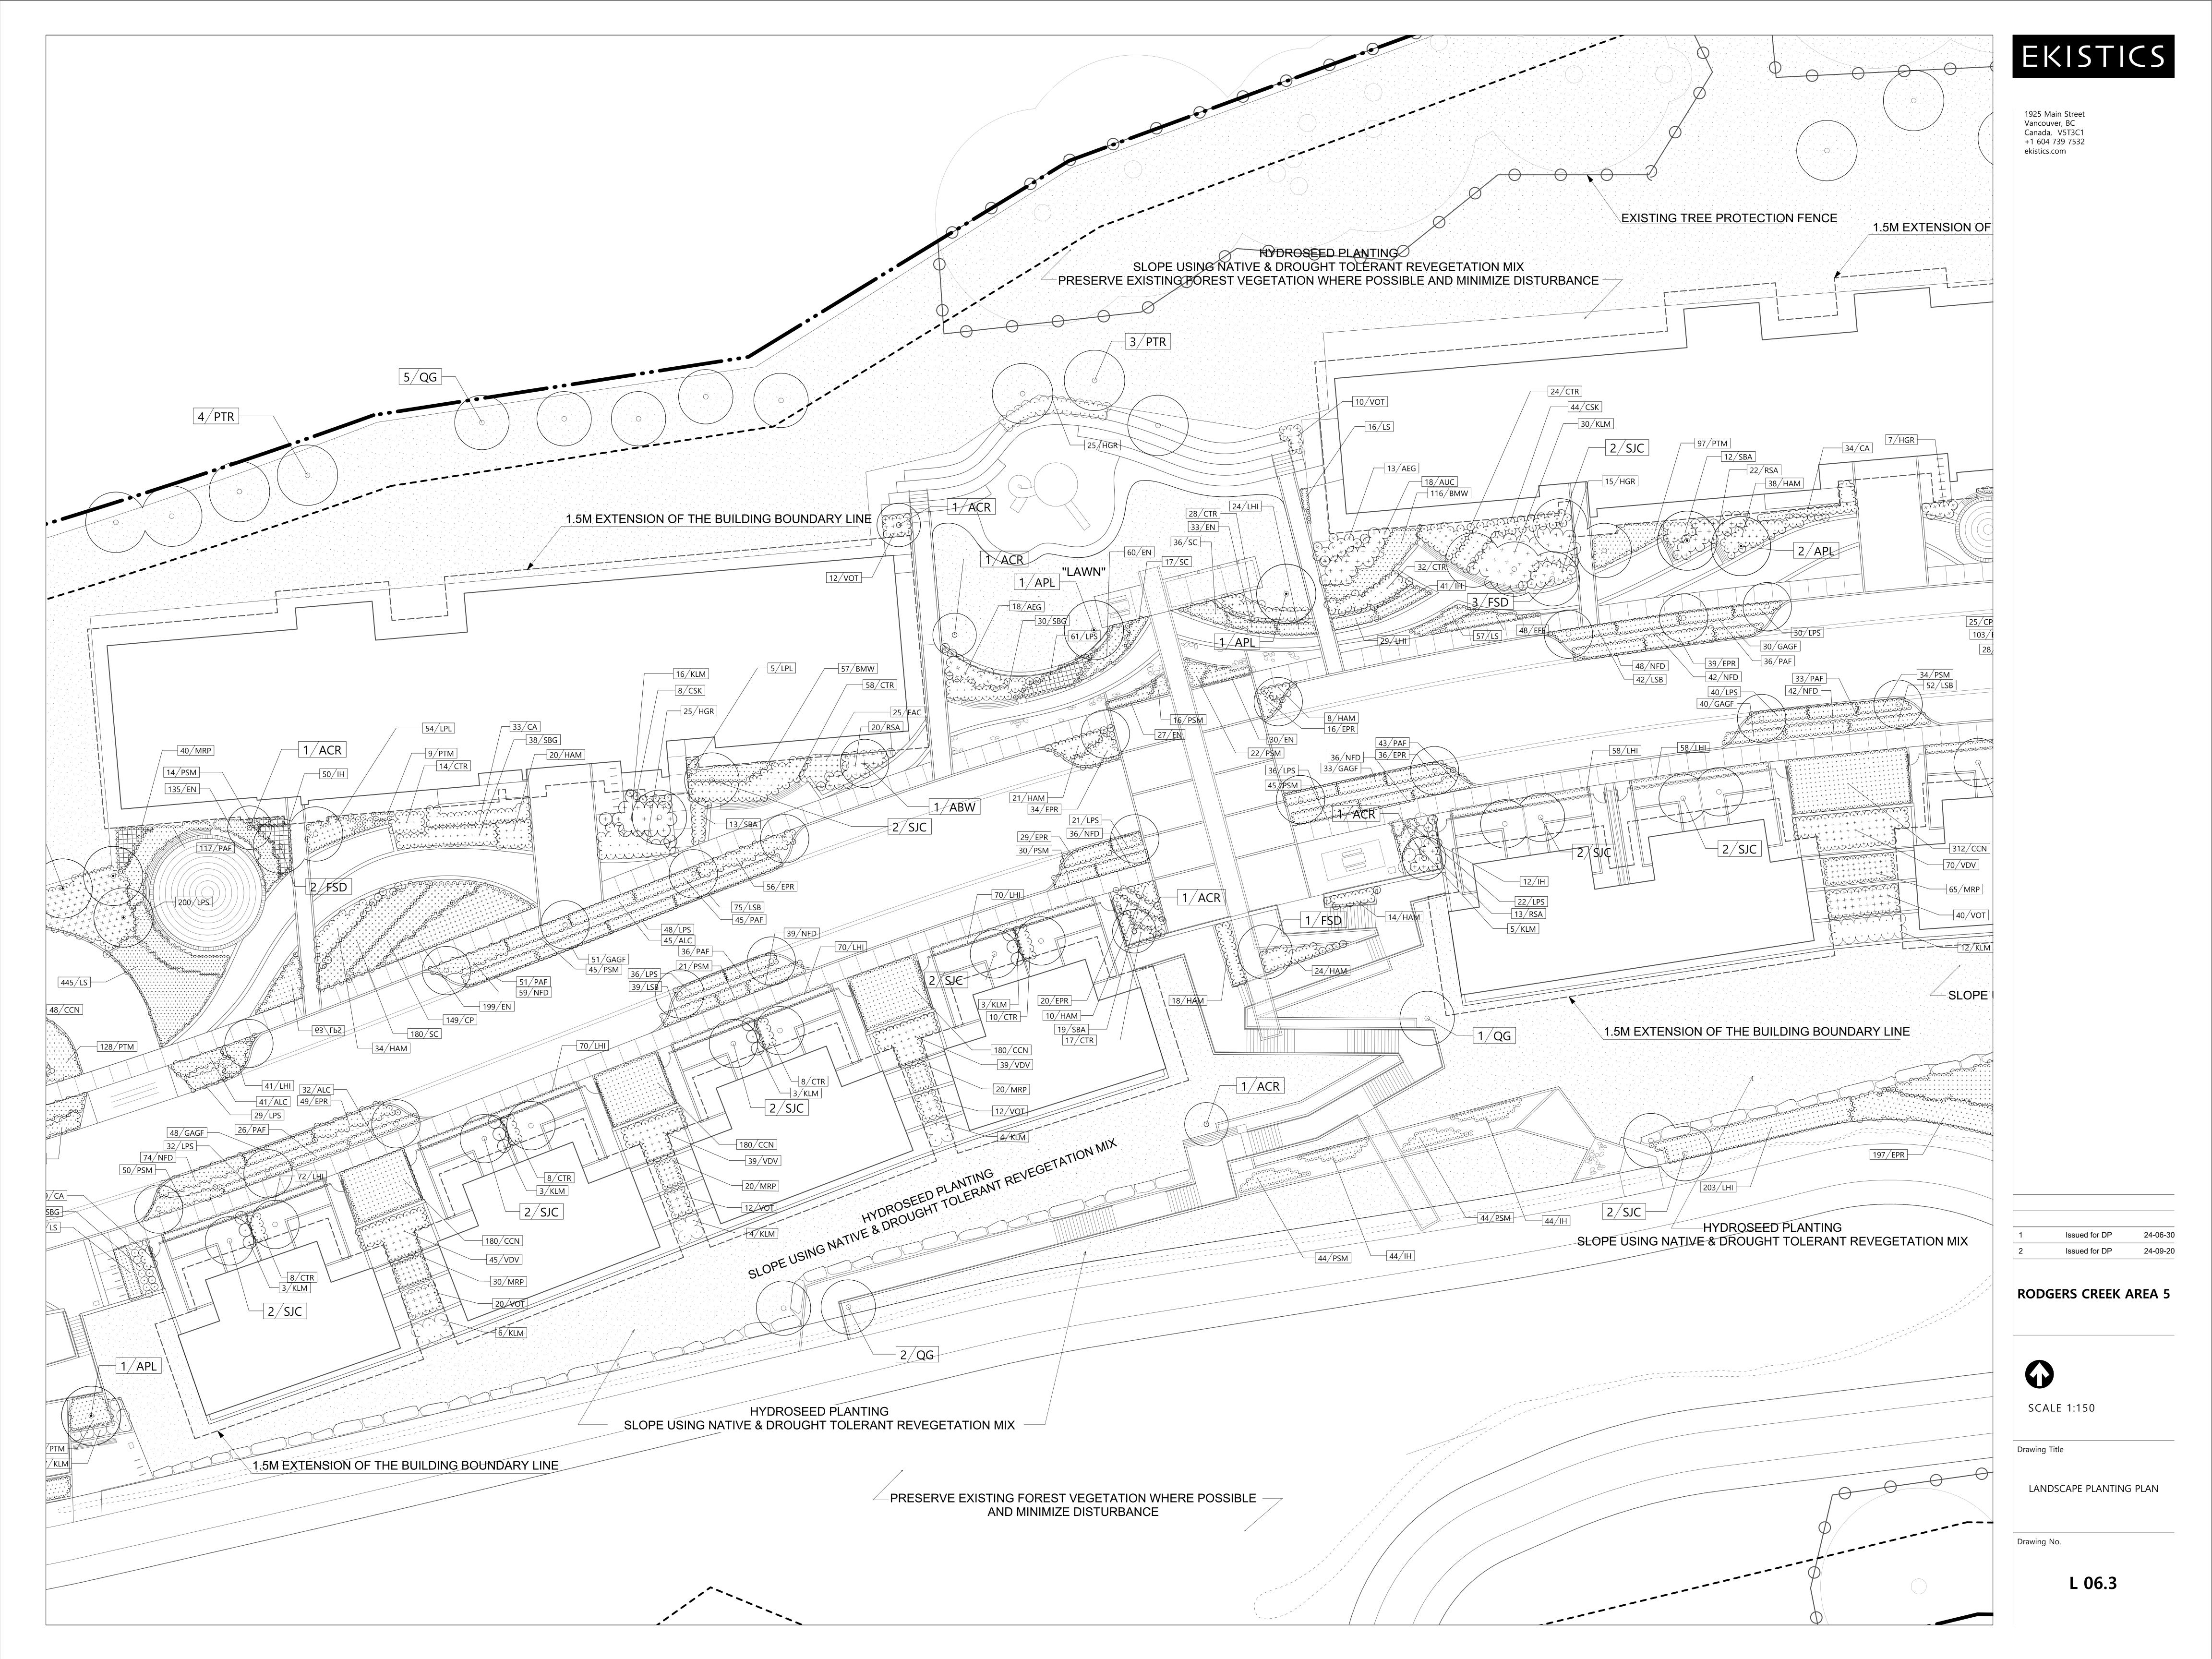

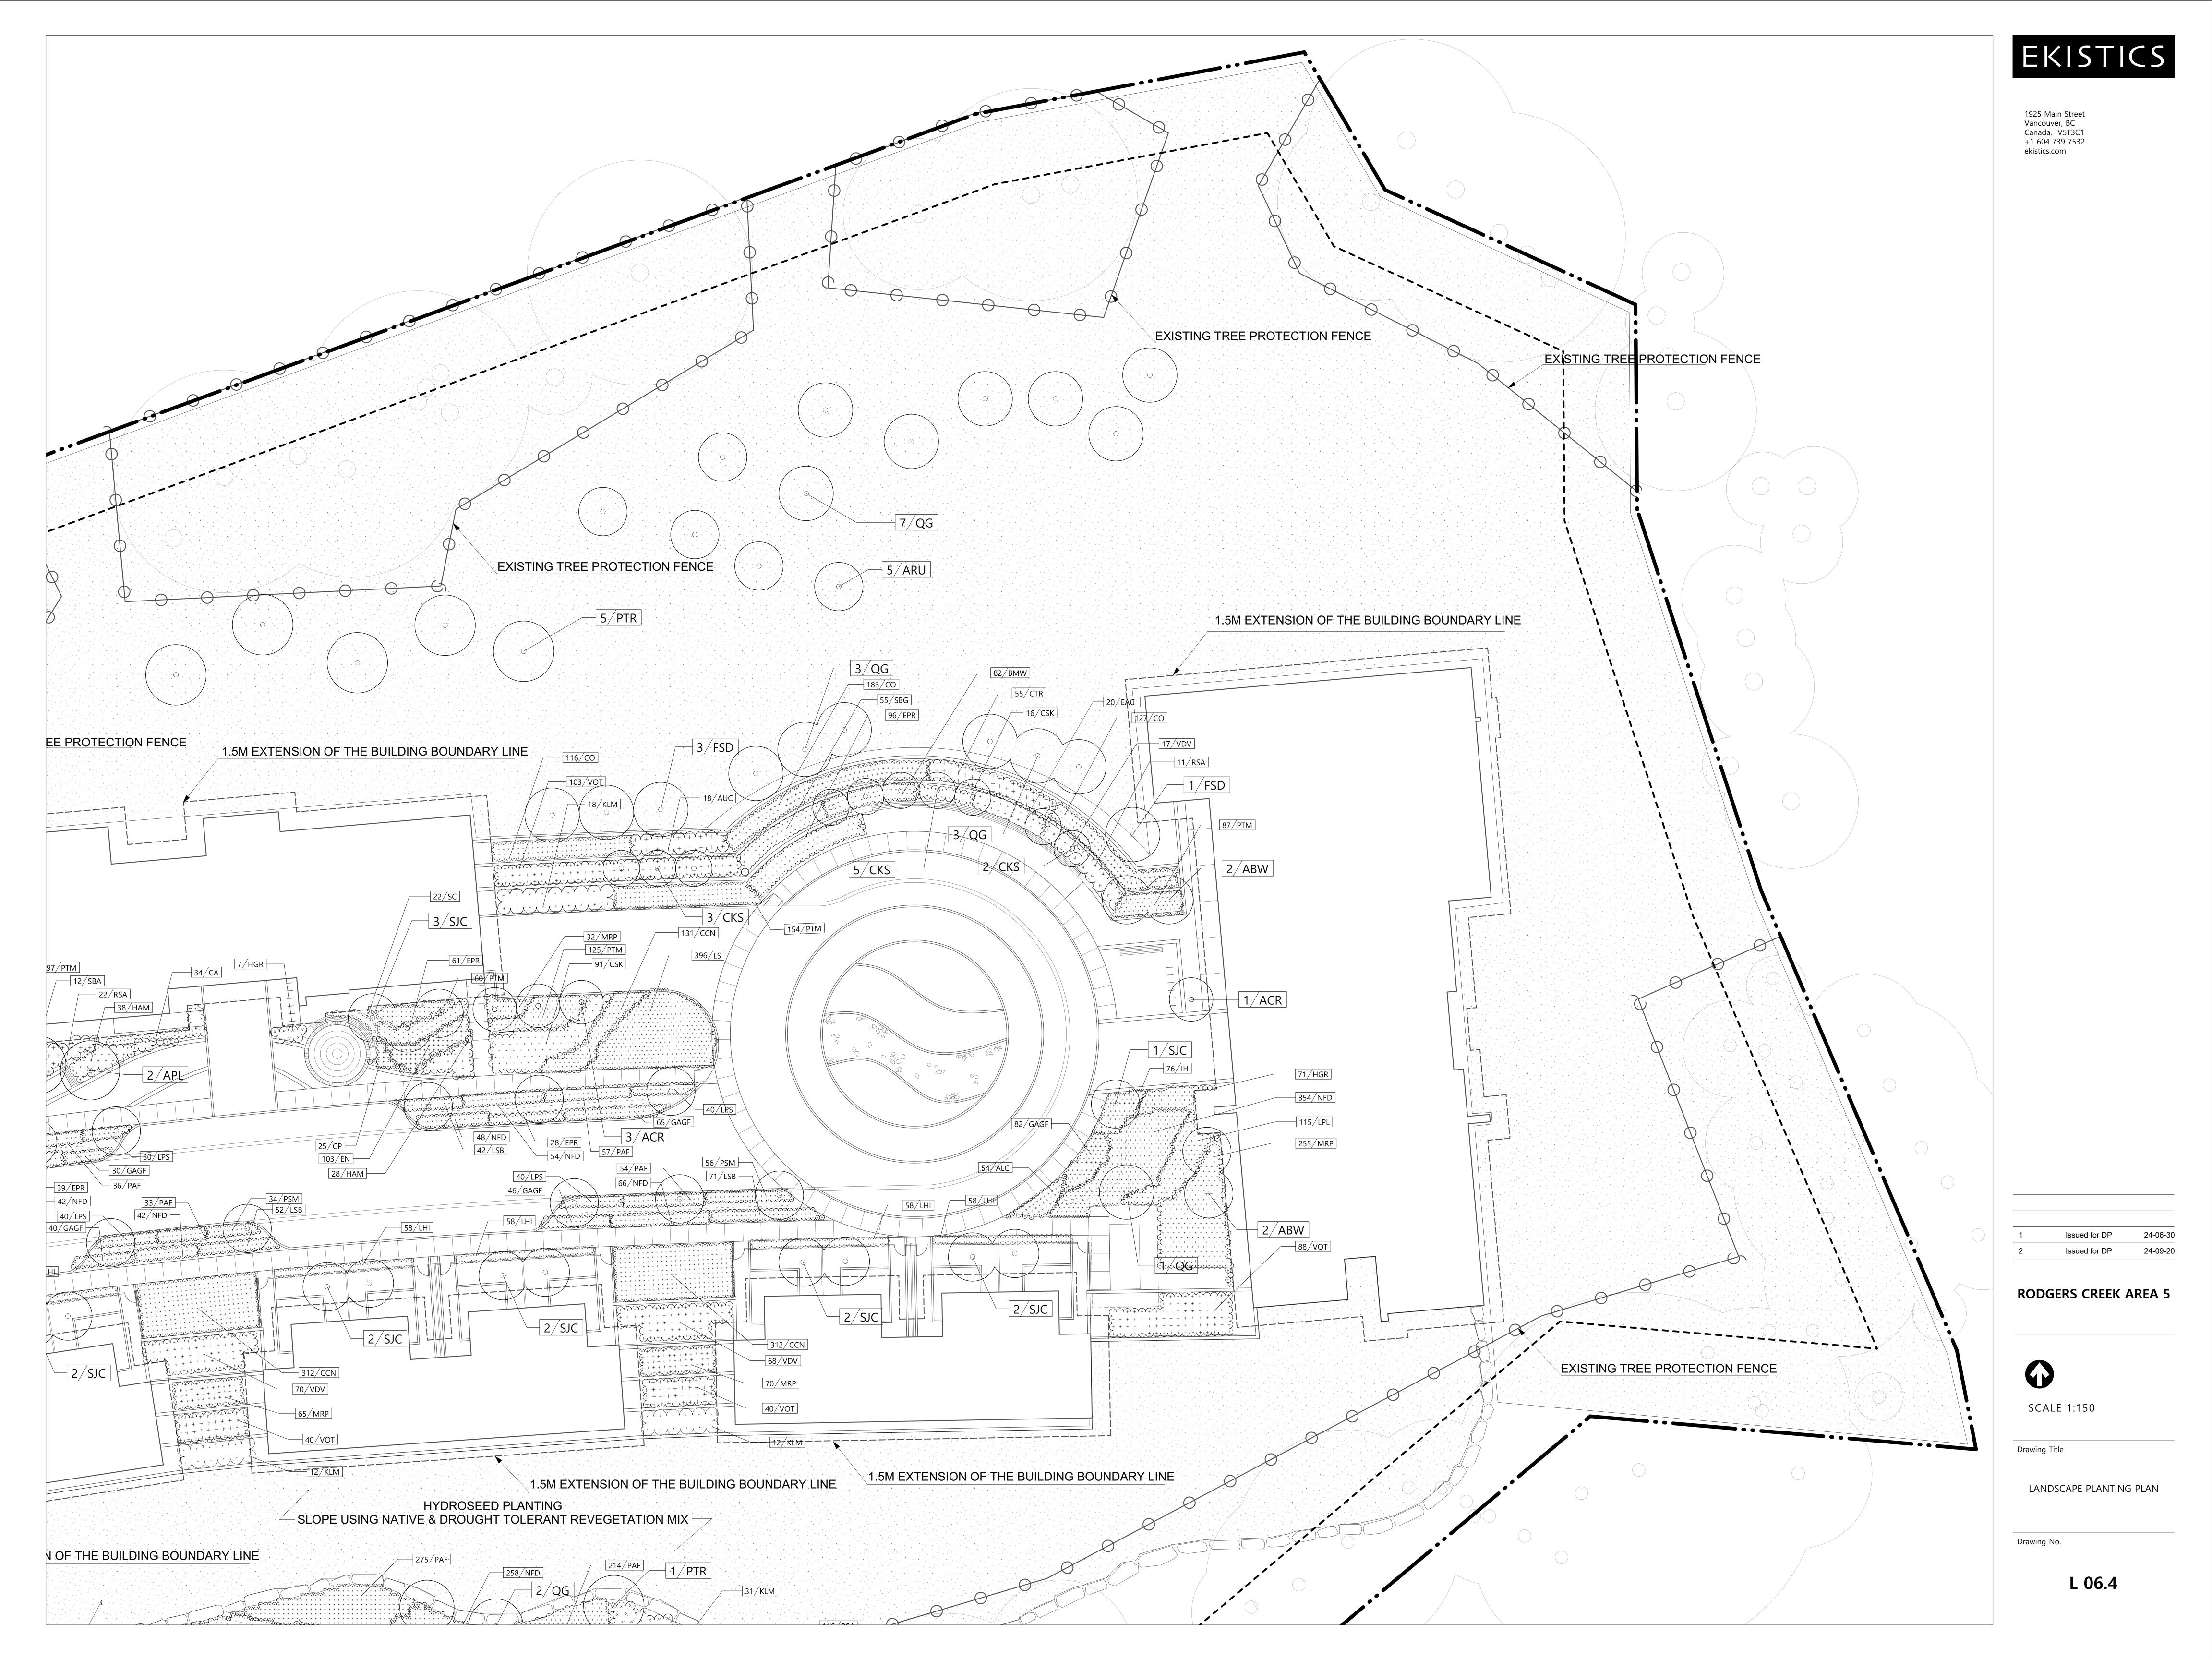

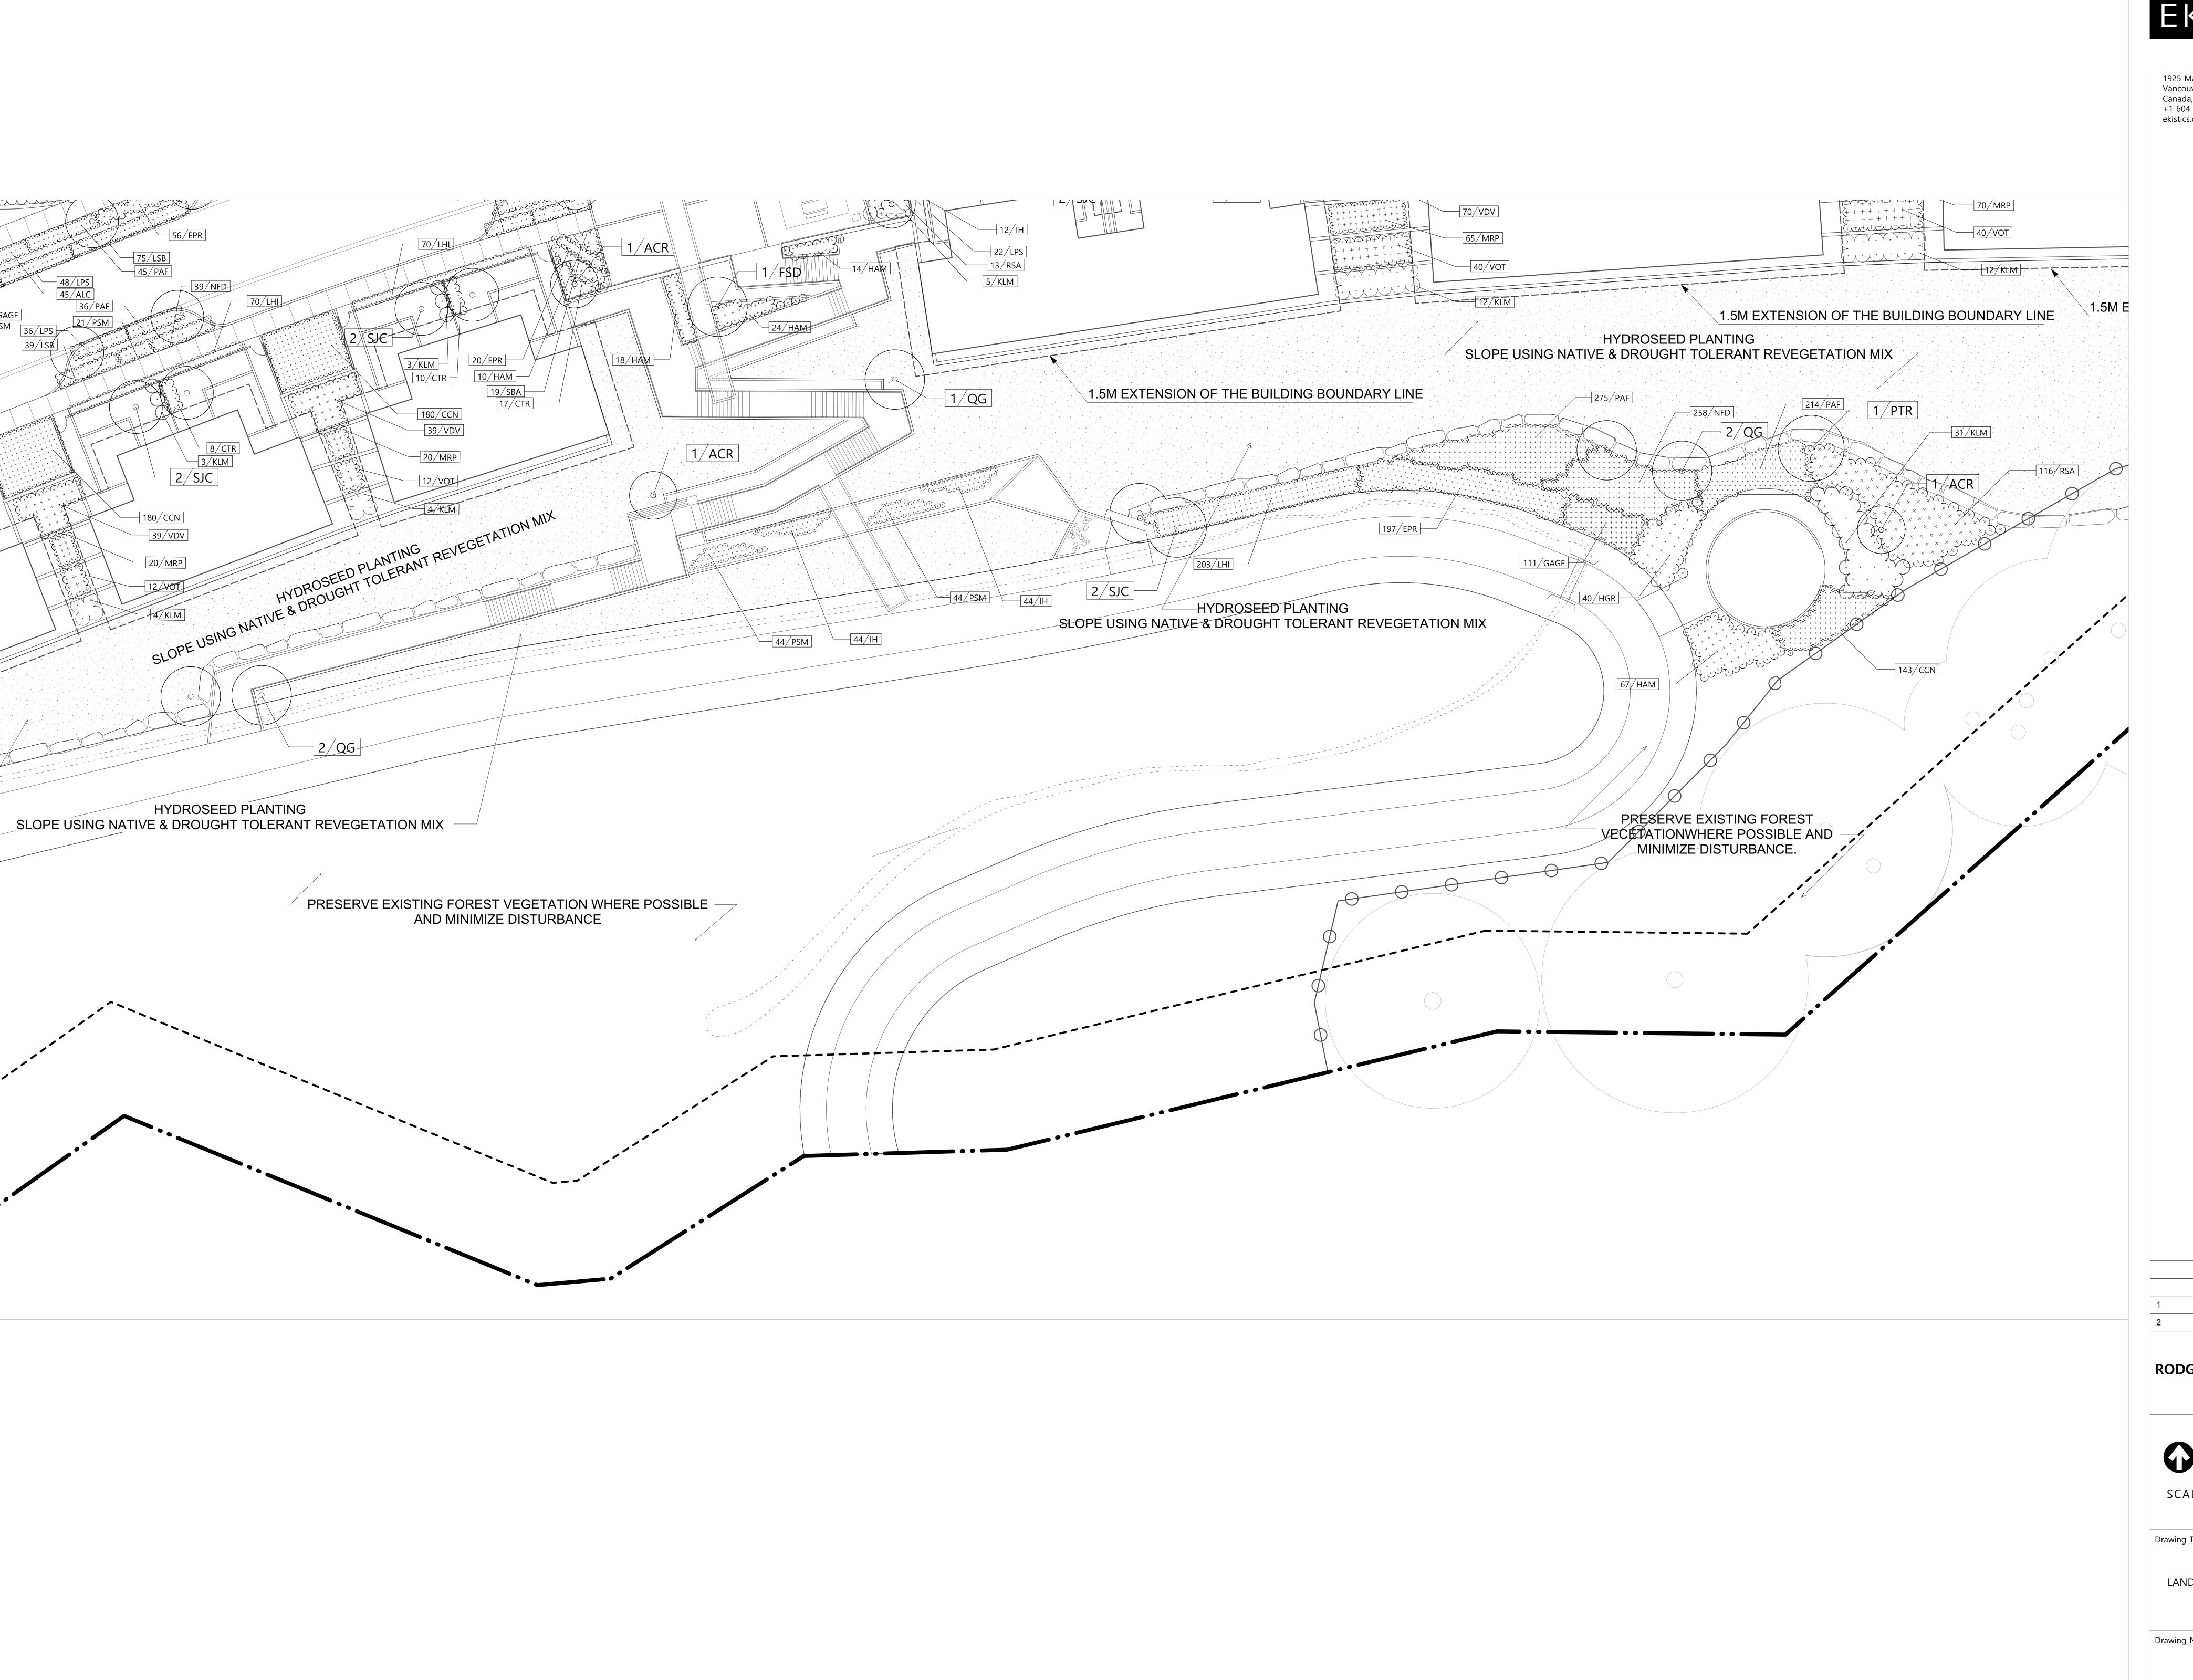
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SCALE 1:150

LANDSCAPE PLANTING PLAN



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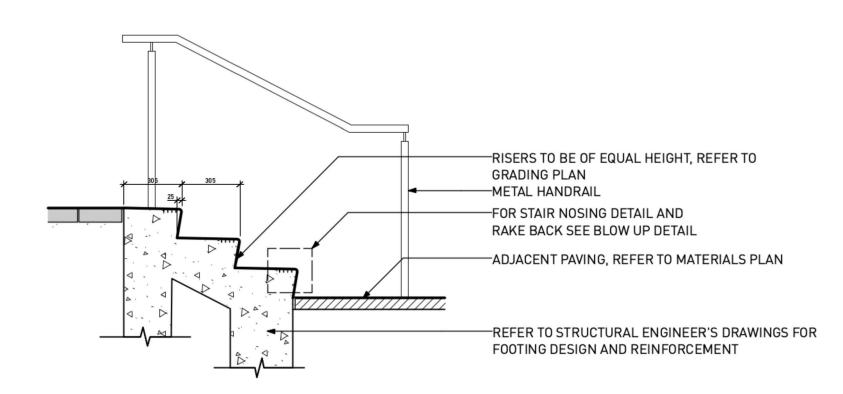
Drawing Title

LANDSCAPE DETAILS

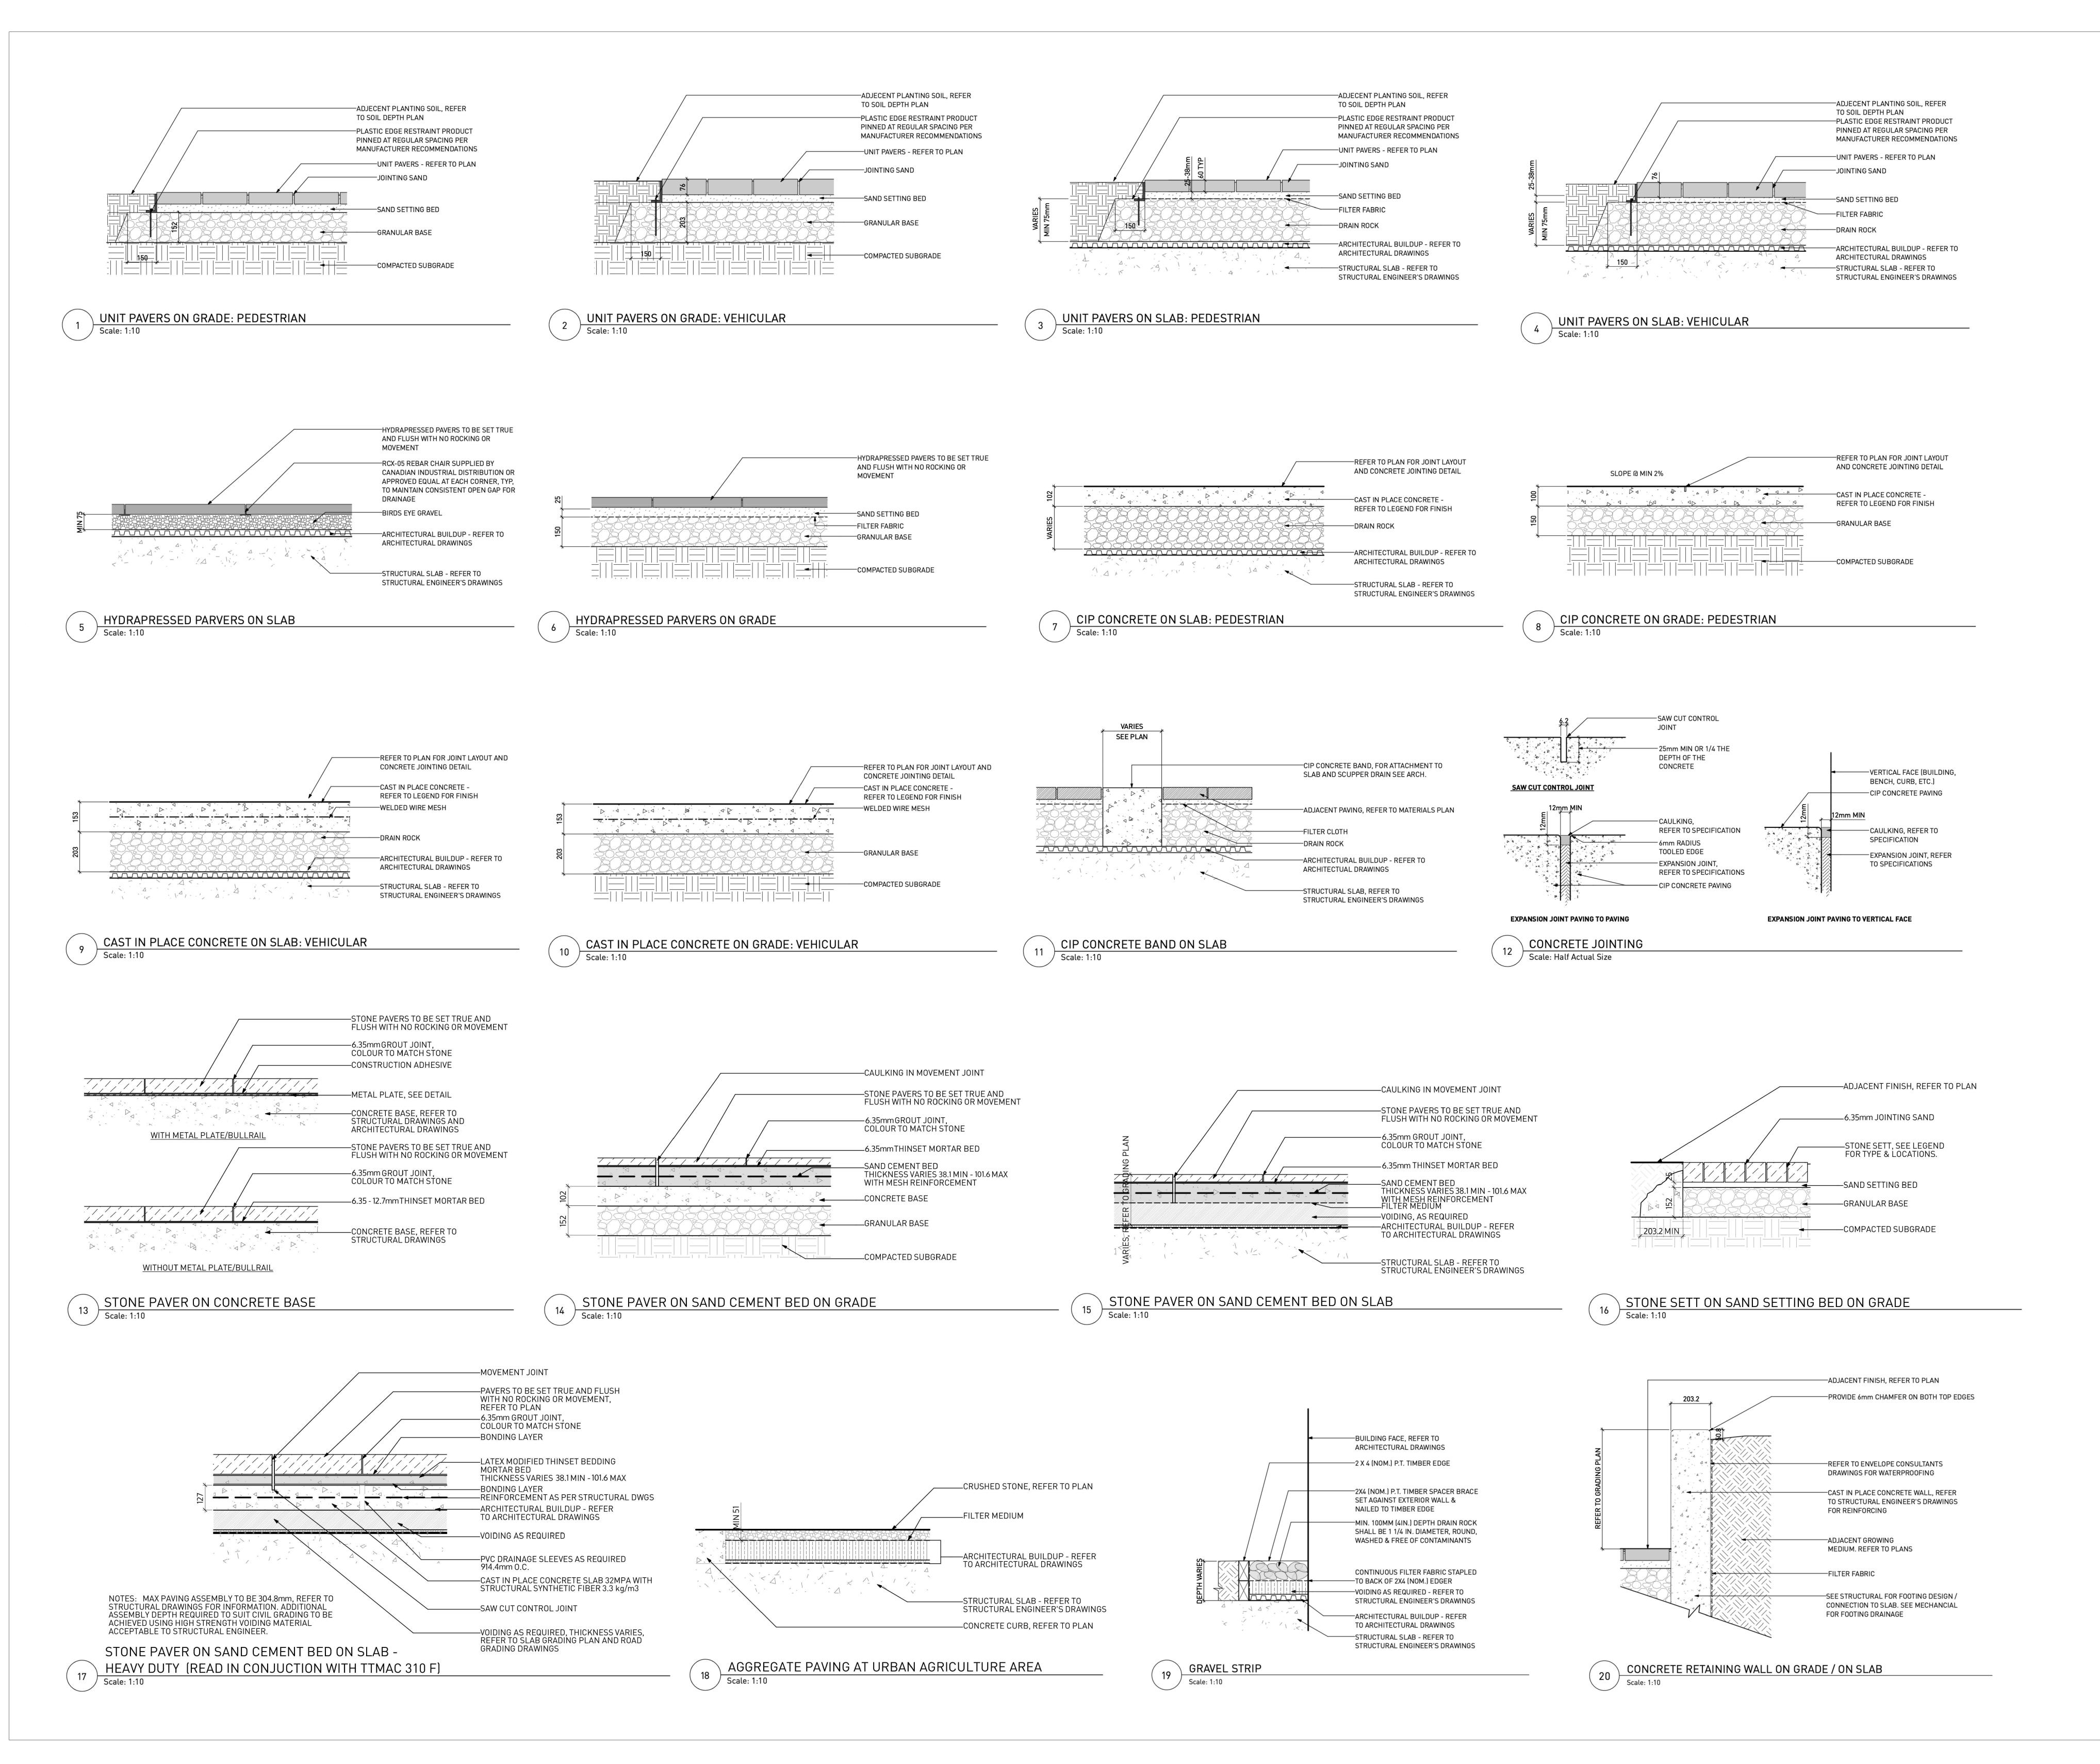Drawing No.

- BALCO INC: SINGLE COMPONENT, MODEL P-300 OR PRE-APPROVED EQUAL
- INSTALL AS PER MANUFACTURER'S INSTRUCTIONS
- ENSURE LAYOUT OF TACTILE TREAD IS SQUARE AND FLUSH TO SURFACE
3. DETAIL MAY SHOW DIFFERENT NUMBER OF RISERS THAN IS REQUIRED, REFER TO PLANS FOR INFORMATION. ALL RISERS COMPRISING A SET OF STAIRS ARE TO BE EQUAL HEIGHT ACROSS FULL WIDTH OF STAIR, REFER TO GRADING

3. DETAIL MAY SHOW DIFFERENT NUMBER OF RISERS THAN IS REQUIRED, REFER TO PLANS FOR INFORMATION. ALL RISERS COMPRISING A SET OF STAIRS ARE TO BE EQUAL HEIGHT ACROSS FULL WIDTH OF STAIR, REFER TO GRADING PLAN FOR RISER HEIGHT AND NUMBER OF RISERS.
4. A FLOOD TEST IS TO BE PERFORMED FOLLOWING STAIR CONSTRUCTION. ANY STAIRS WITH PONDING WATER WILL BE REJECTED AND WILL REQUIRE REPLACEMENT BY CONTRACTOR AT NO EXPENSE TO THE OWNER.




CIP CONCRETE STAIR


Scale: 1:20

HANDRAIL NOTES:


HANDRAILS ARE TO BE DESIGNED BY STRUCTURAL ENGINEER IN ACCORDANCE WITH CURRENT BCBC.
 PROVIDE ENGINEEERED STAMPED SHOP DRAWINGS AND SCHEDULES FOR HANDRAILS.
 DETAIL MAY SHOW DIFFERENT NUMBER OF RISERS THAN IS REQUIRED, REFER TO PLANS FOR INFORMATION.
 ALL RISERS COMPRISING A SET OF STAIRS ARE TO BE EQUAL HEIGHT ACROSS FULL WIDTH OF STAIR, REFER TO
 GRADING PLAN FOR RISER HEIGHT AND NUMBER OF RISERS.

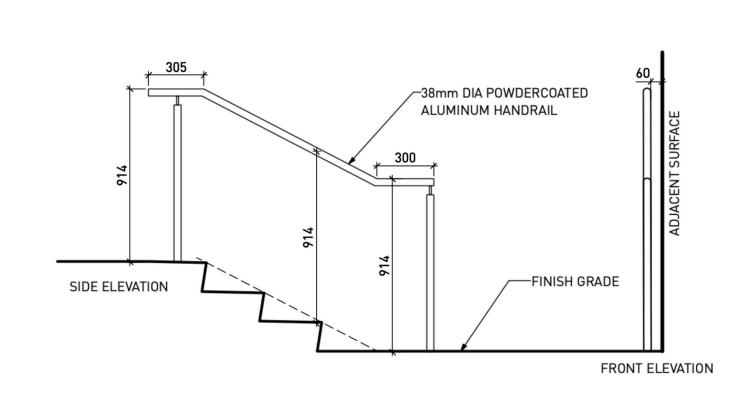



METAL HANDRAIL
Scale: 1:20

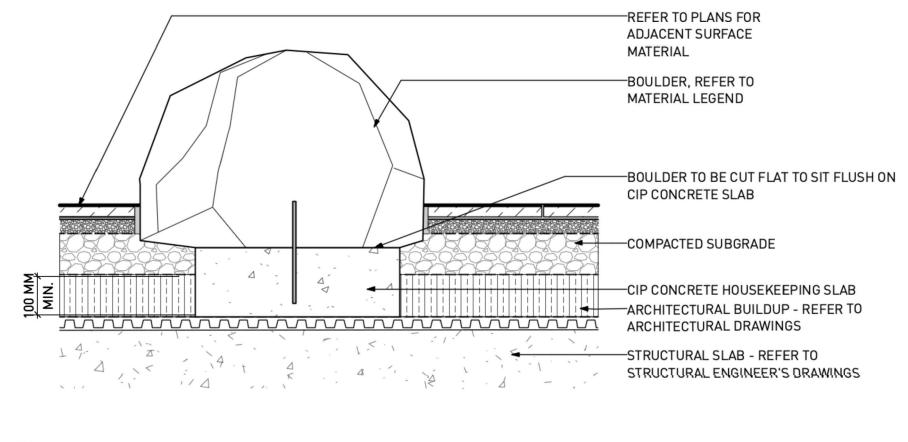


23 LANDSCAPE BOULDER
Scale: 1:10

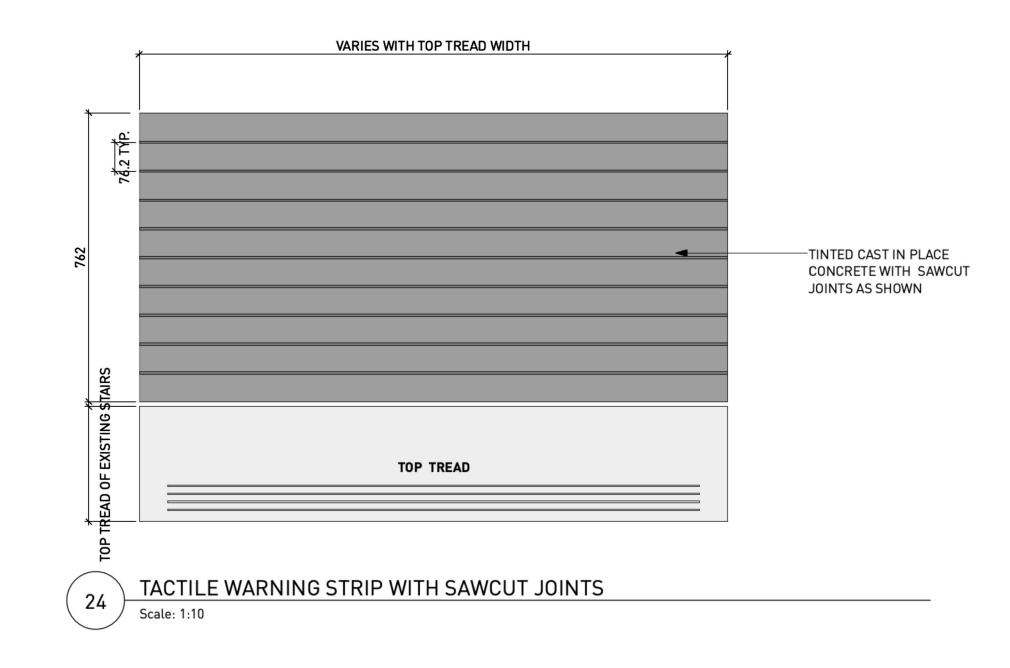

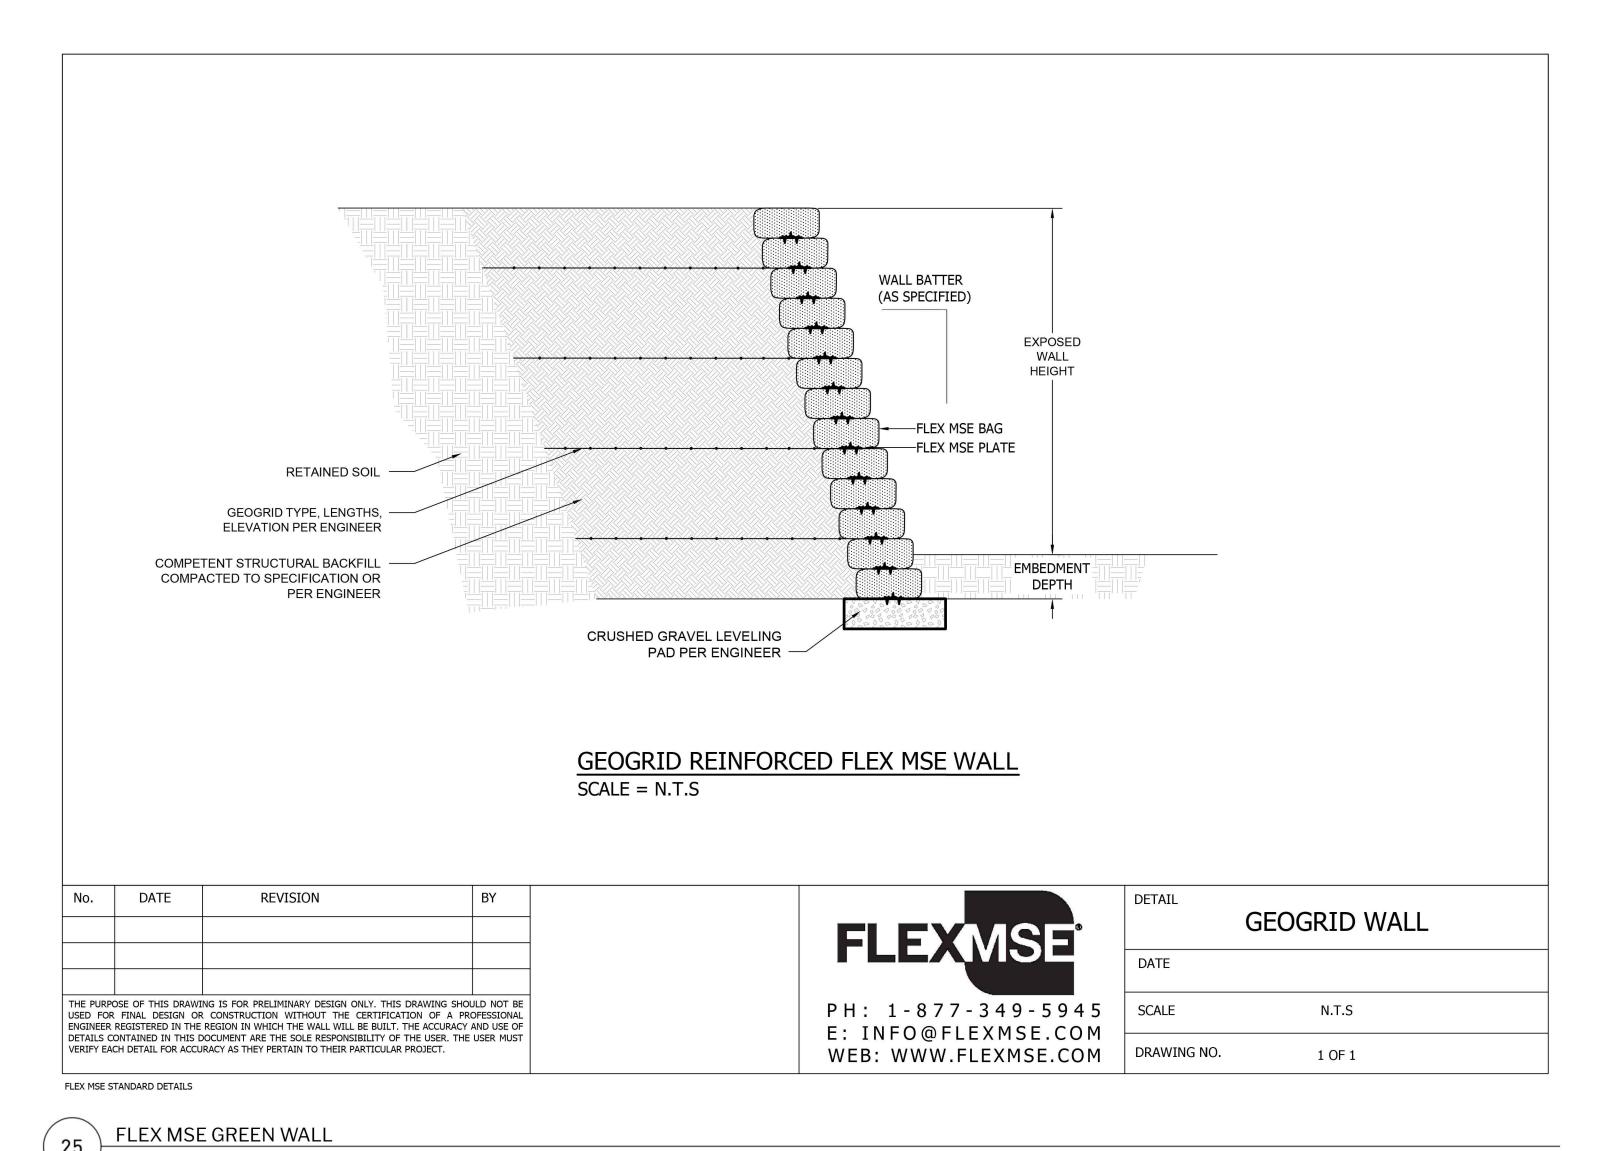

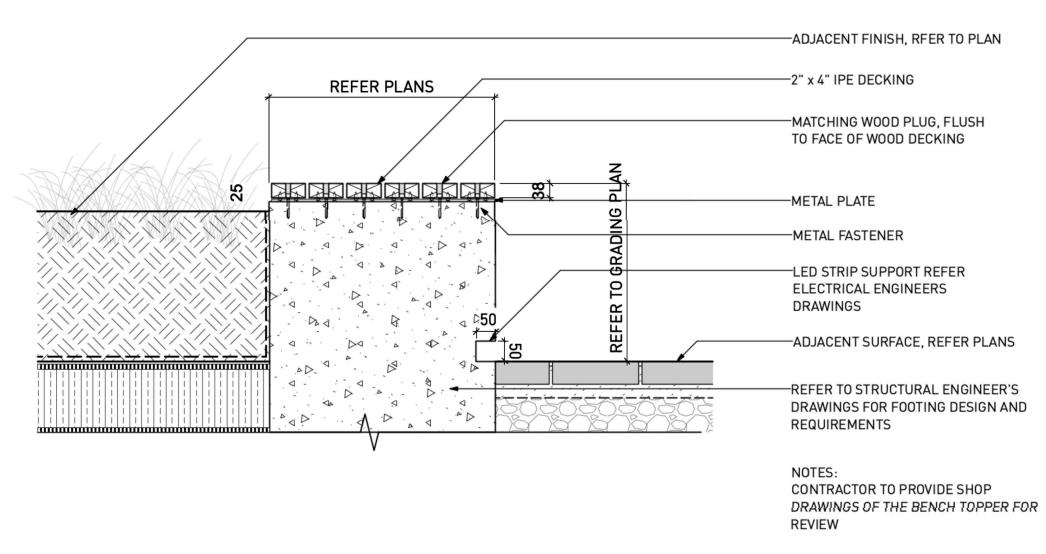

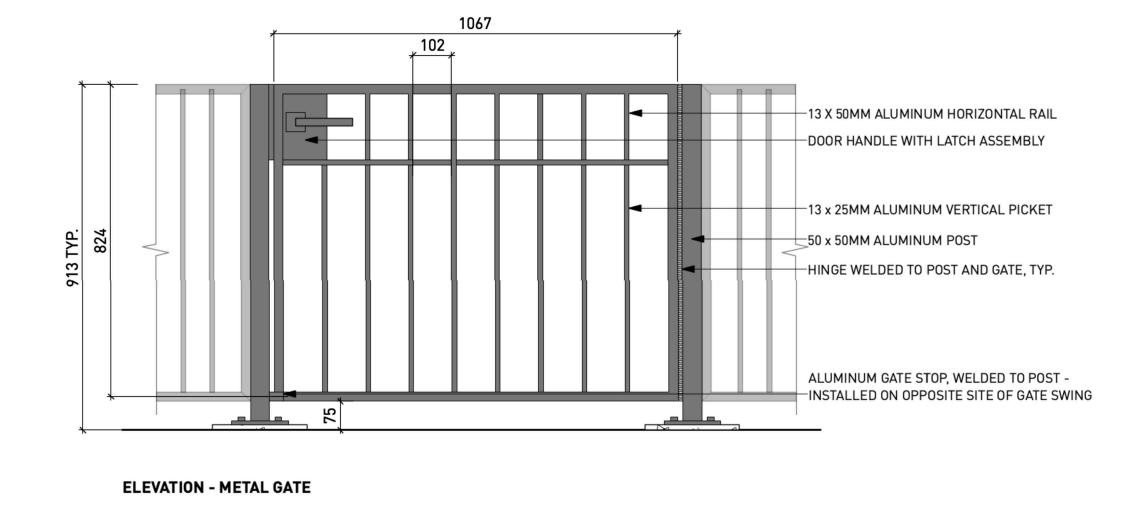

NOTE:


1. ALL METAL COMPONENTS, FASTENERS AND HARDWARE TO BE PRIMED AND PAINTED. COLOUR.


2. ALL WELDS TO BE CONTINUOUS AND GROUND SMOOTH; NO SPOT WELDING.


3. PROVIDE SHOP DRAWINGS FOR APPROVAL BY CONSULTANT PRIOR TO FABRICATION.

3. PROVIDE SHOP DRAWINGS FOR APPROVAL BY CONSULTANT PRIOR TO FABRICATION.
4. PLANS AND DETAILS TO BE READ IN CONJUNCTION WITH STRUCTURAL DRAWINGS AND SPECIFICATIONS. REPORT ERRORS OR DISCREPANCIES TO CONSULTANT.



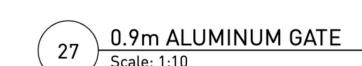

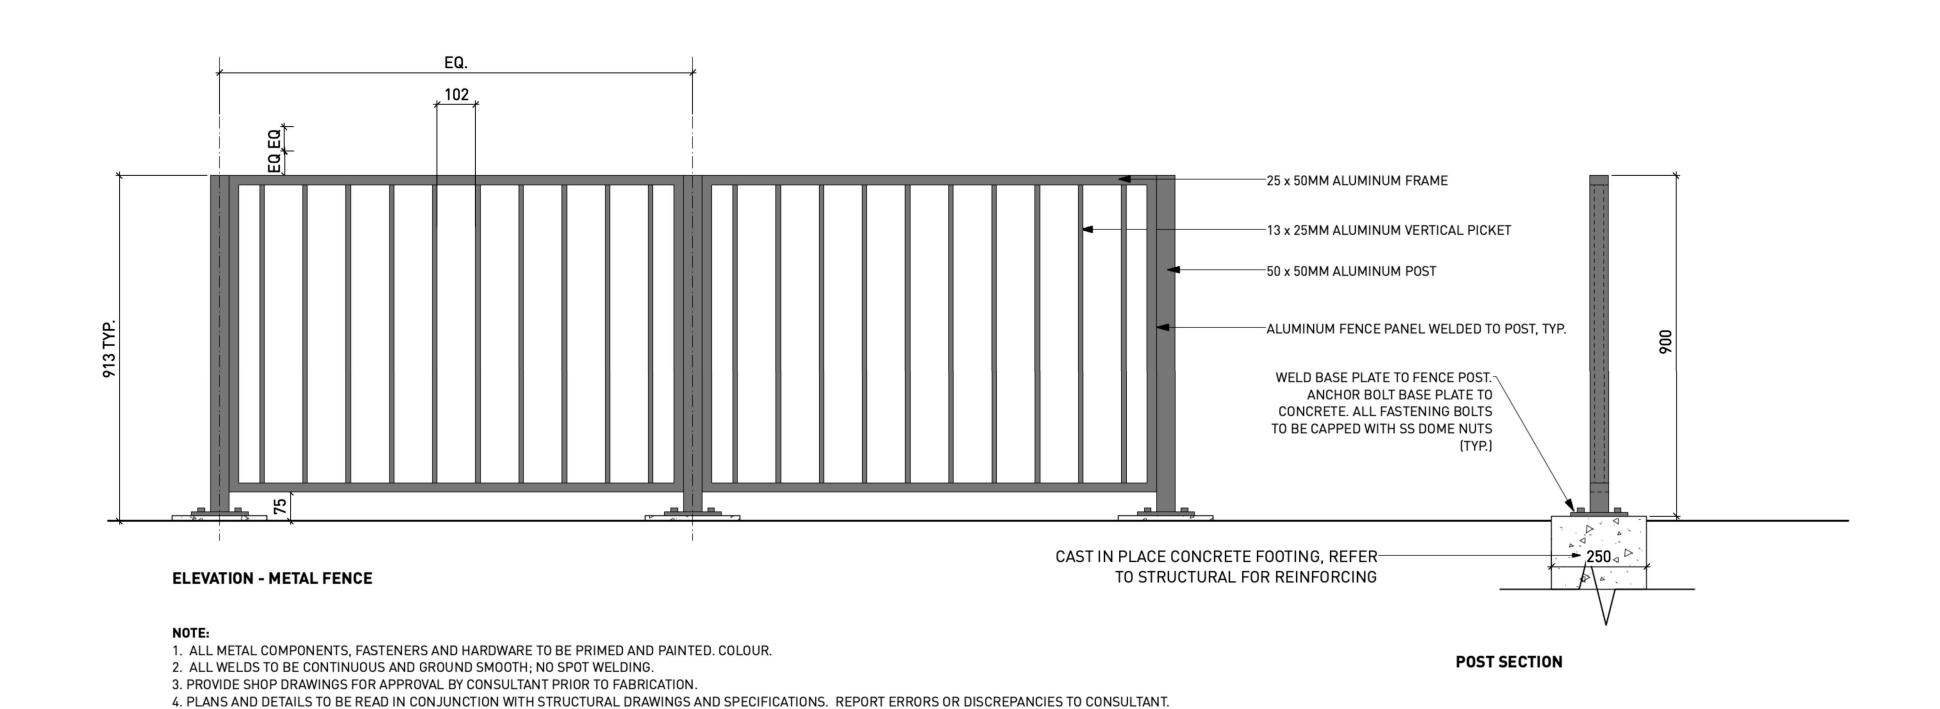

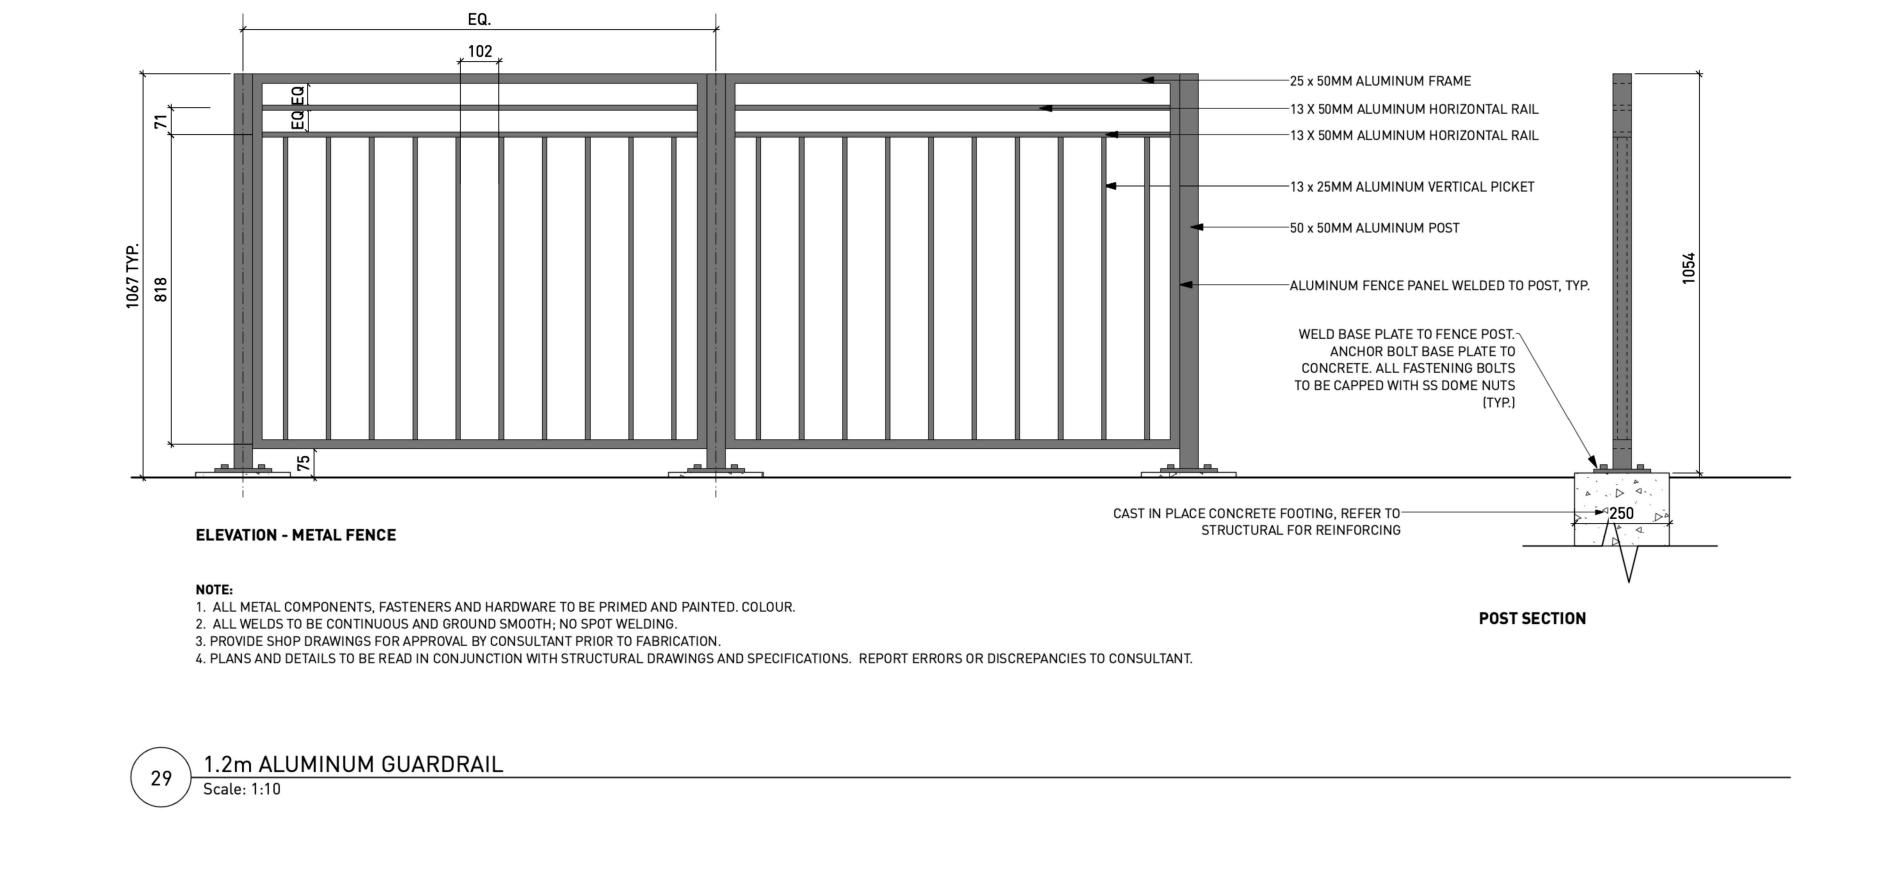

0.9m ALUMINUM FENCE

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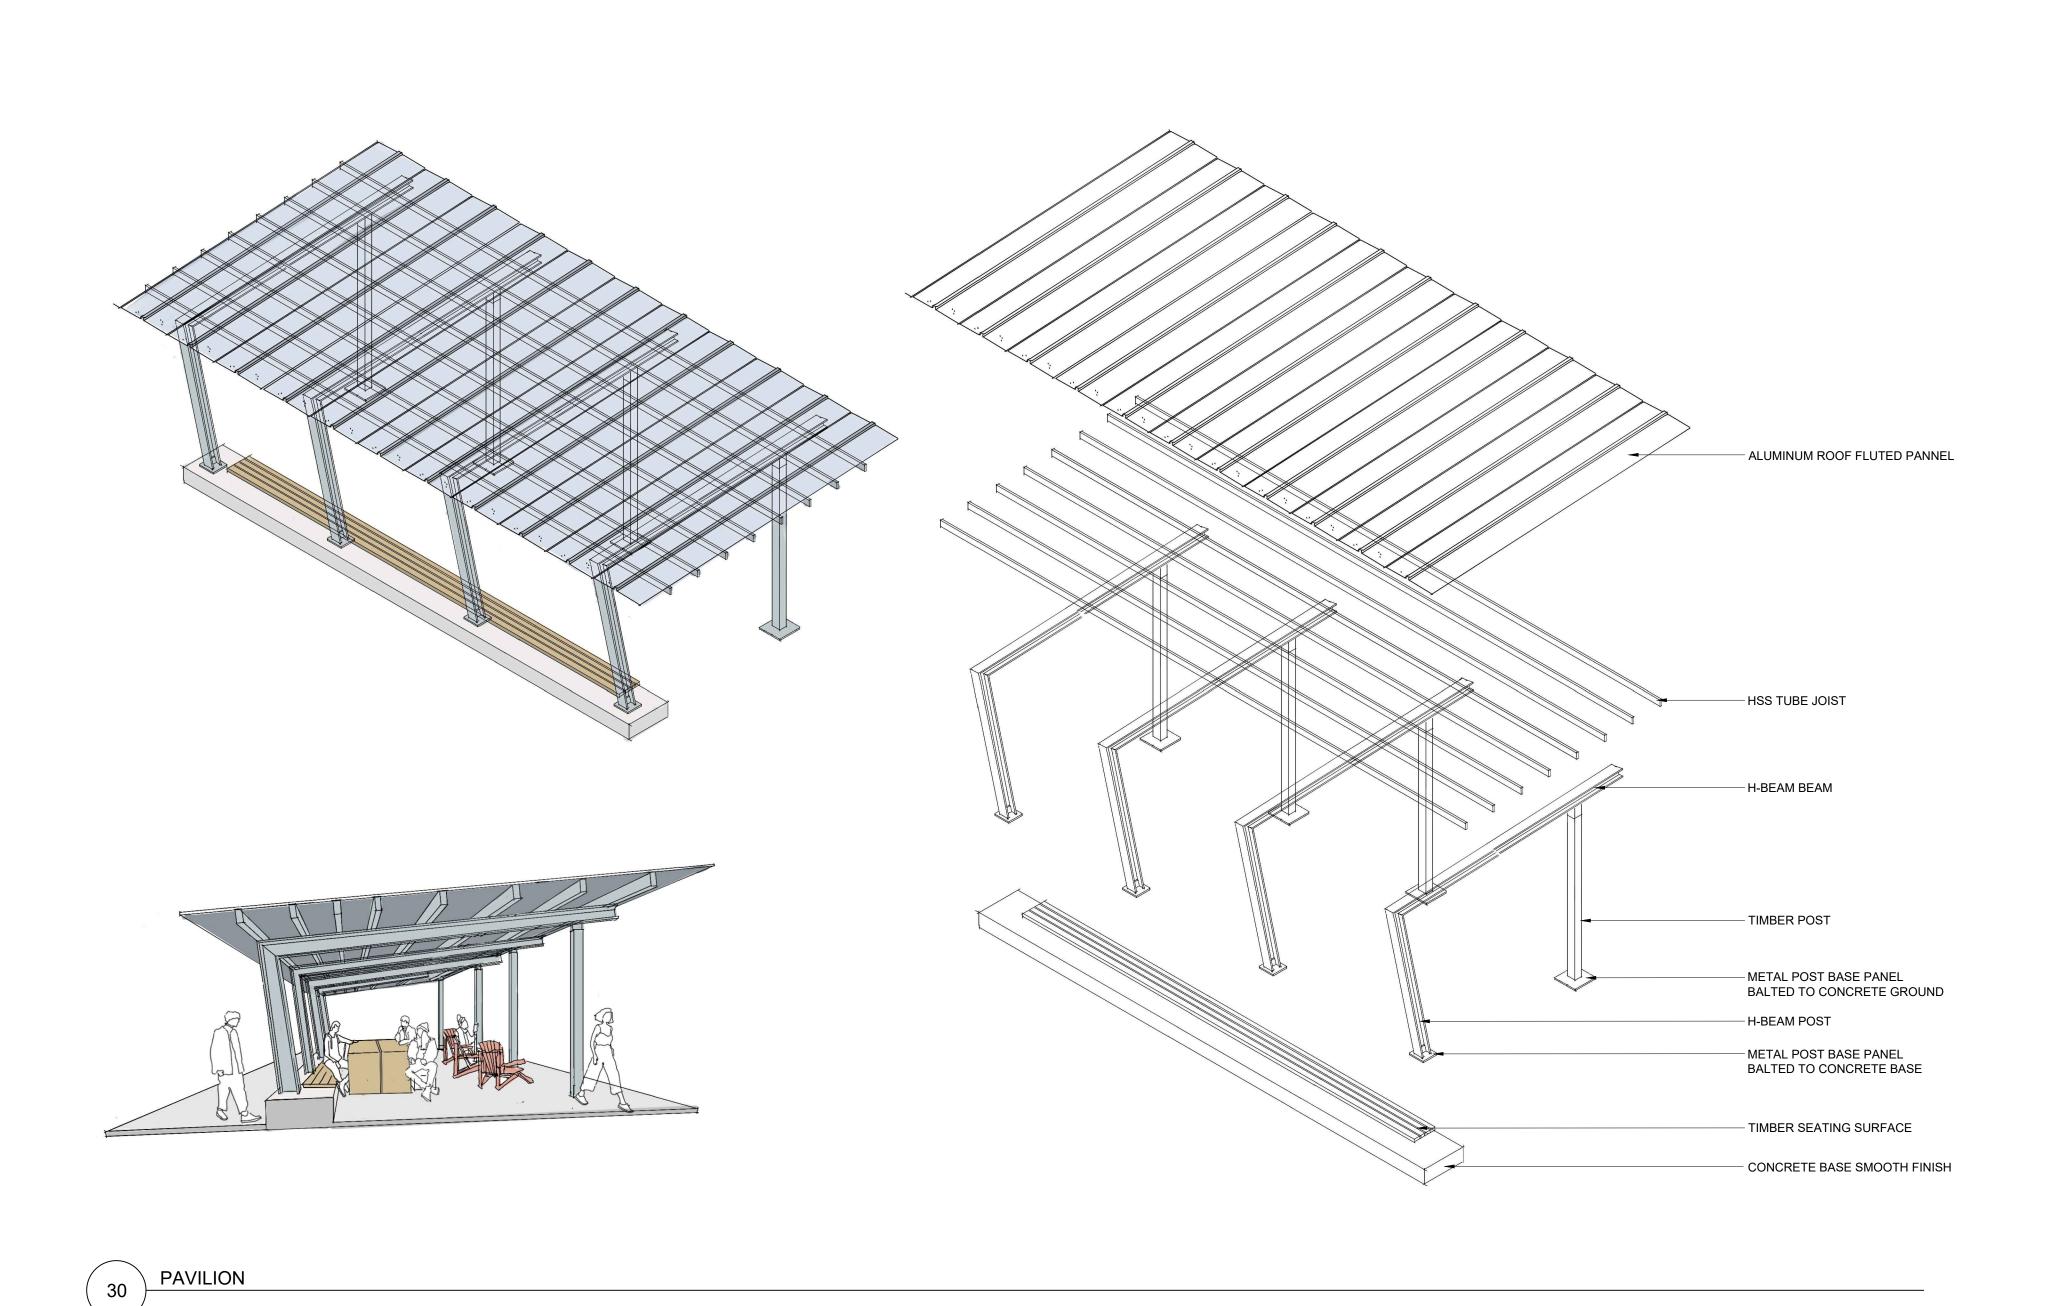
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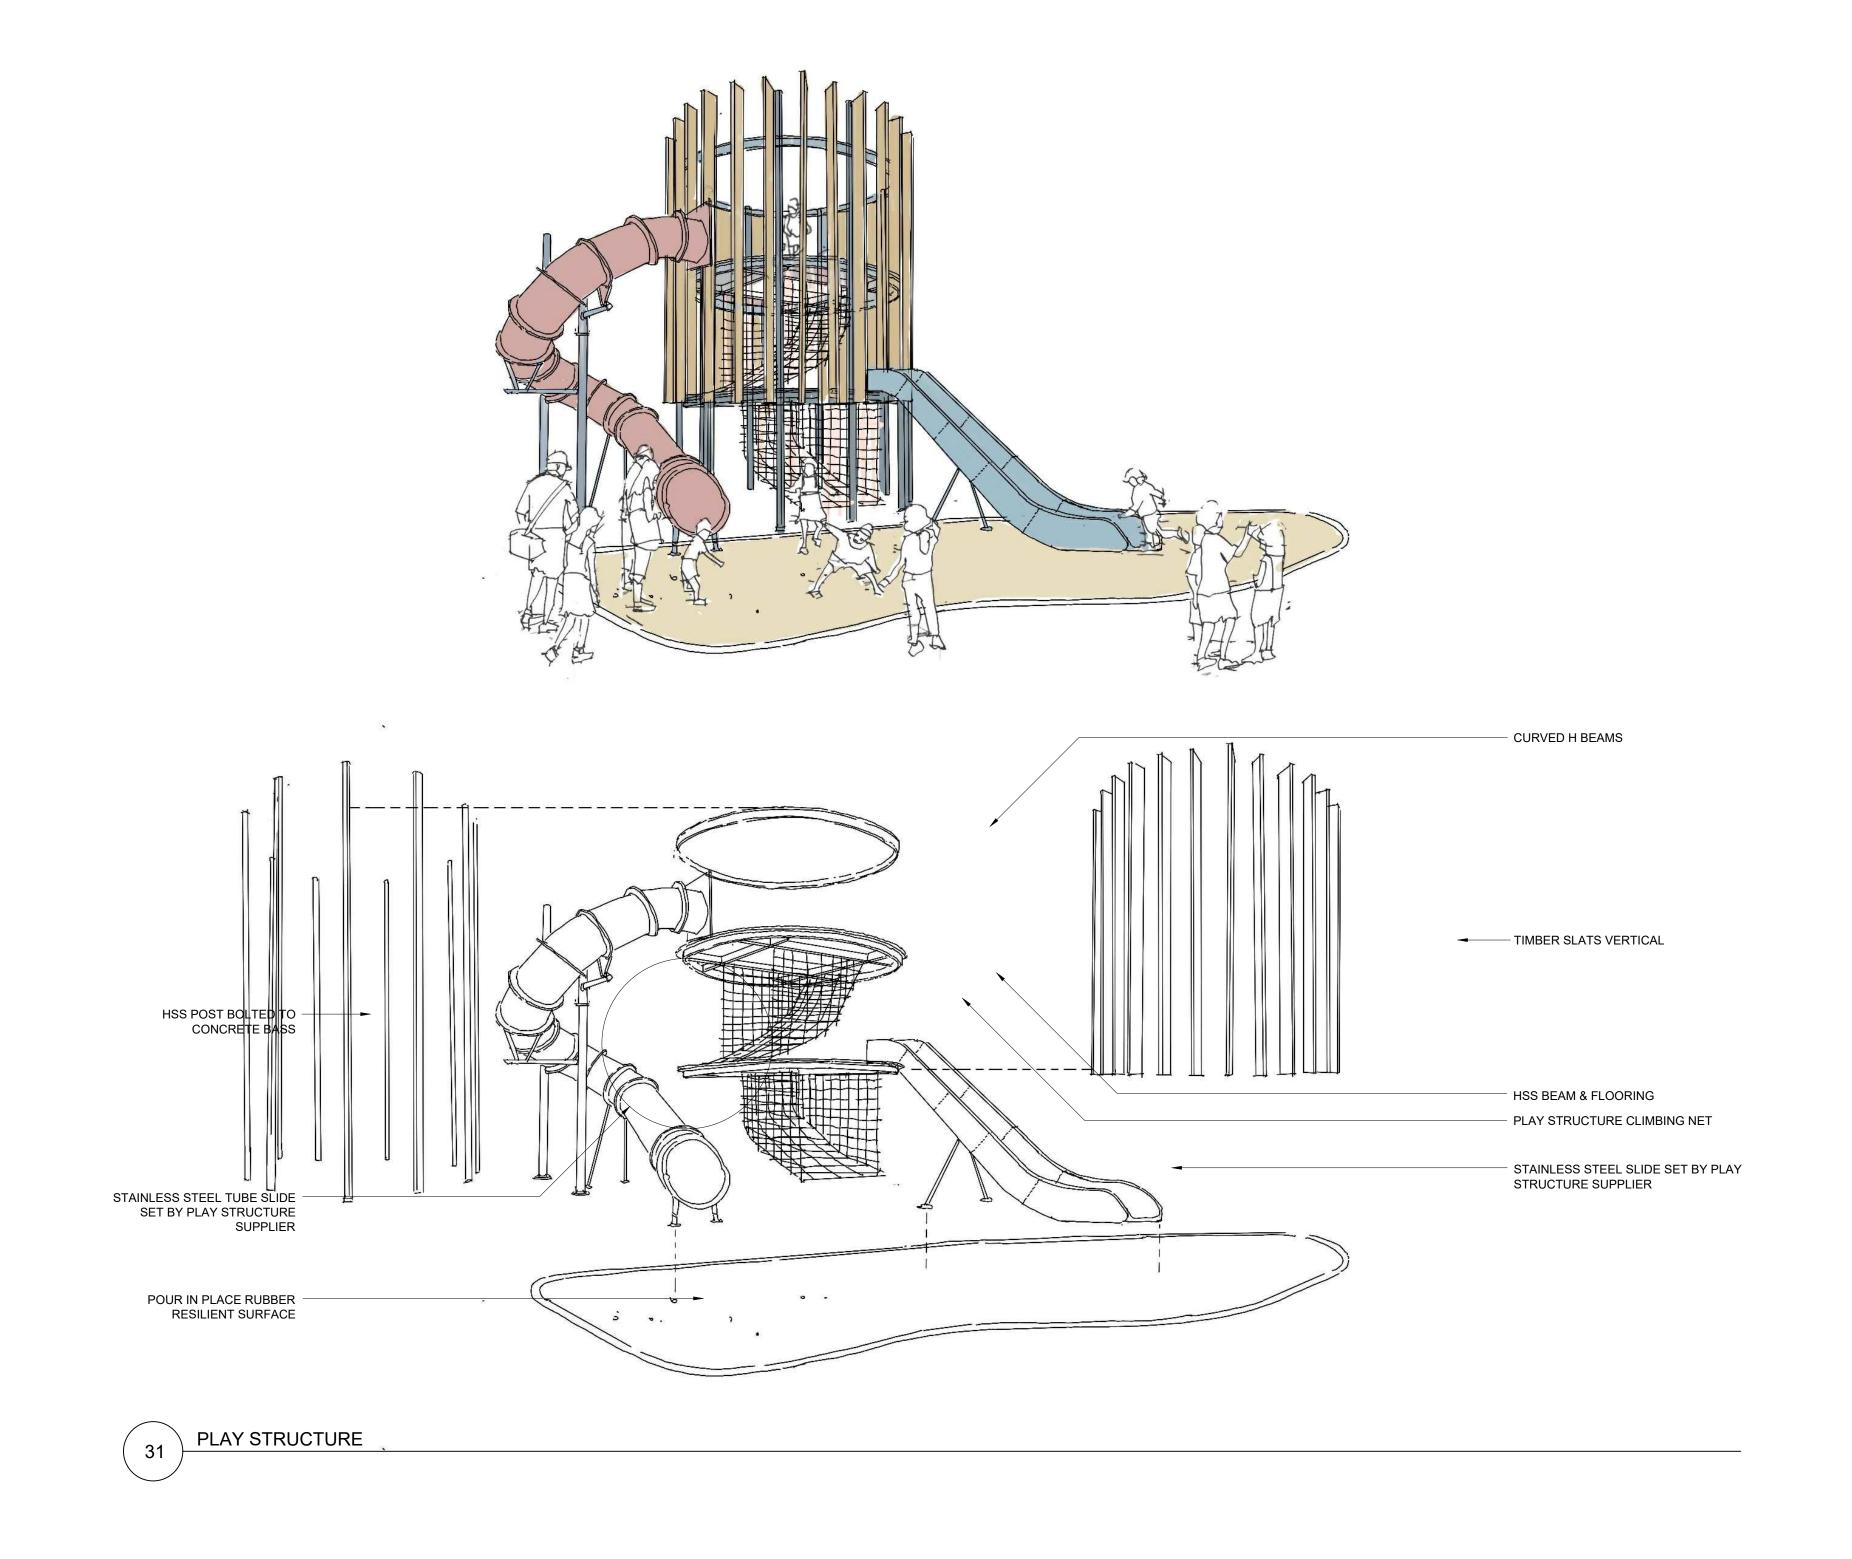
LANDSCAPE DETAILS


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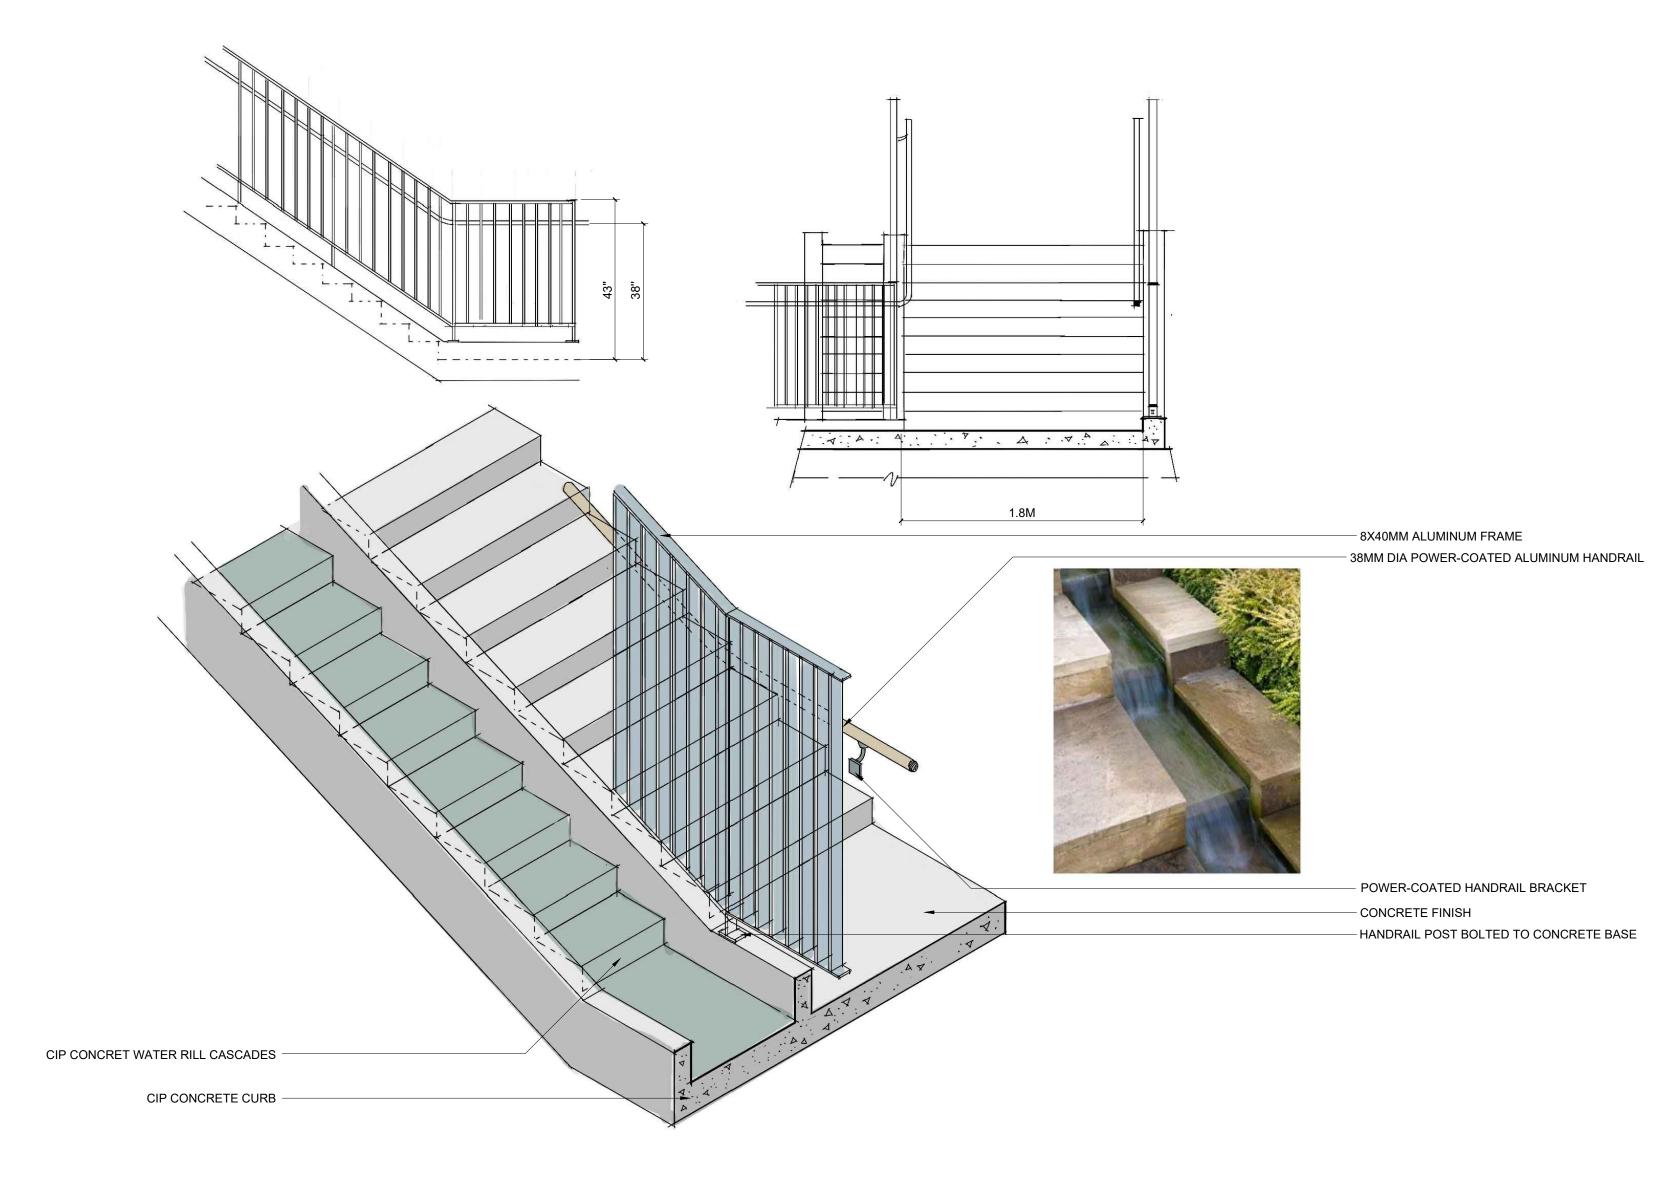
L 06

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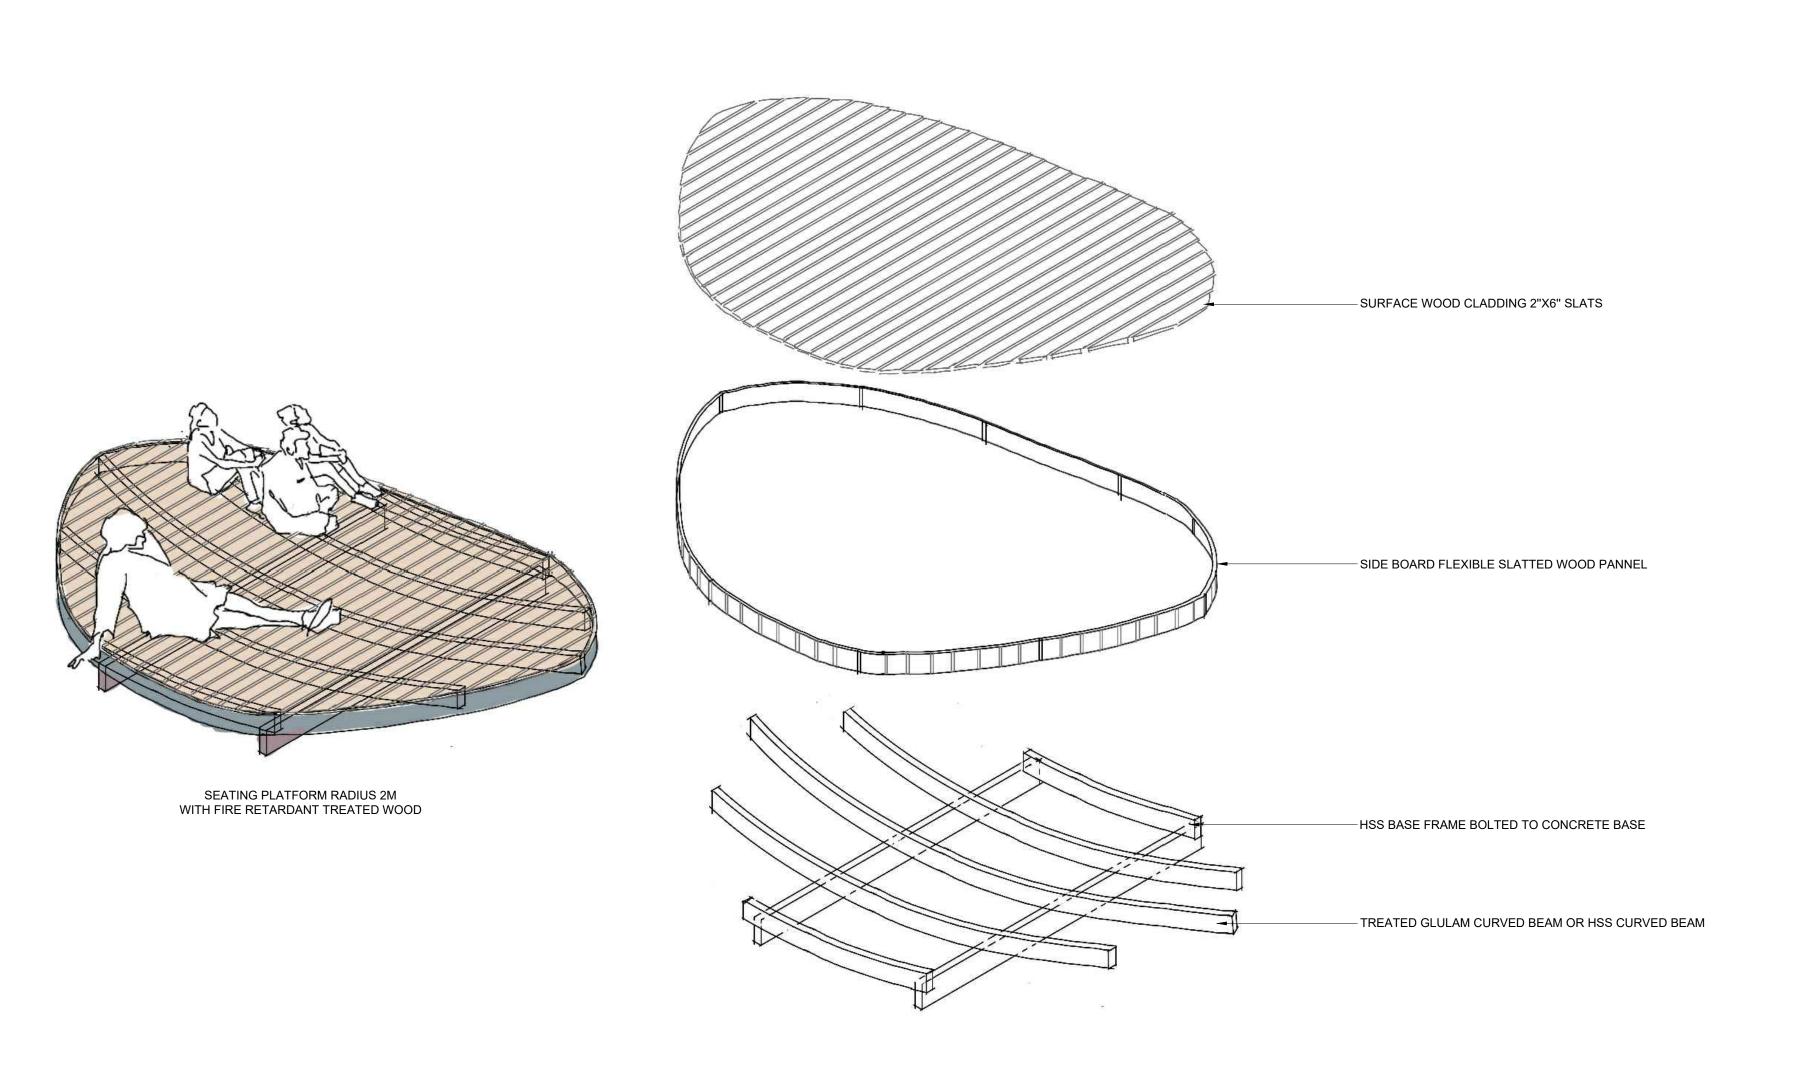
RODGERS CREEK AREA 5


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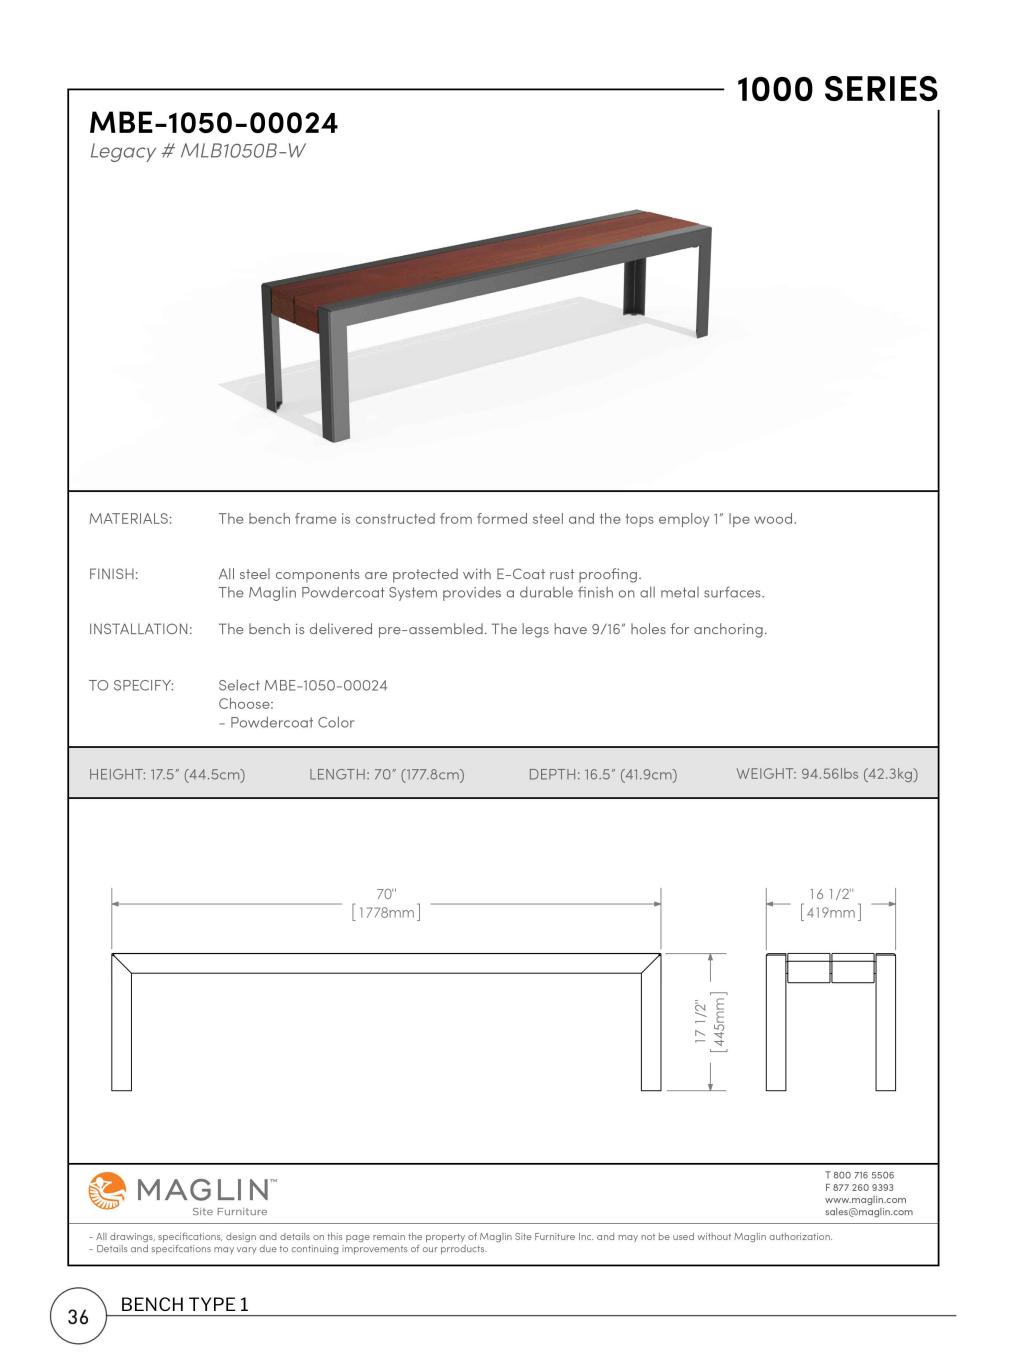
LANDSCAPE DETAILS

Drawing No.


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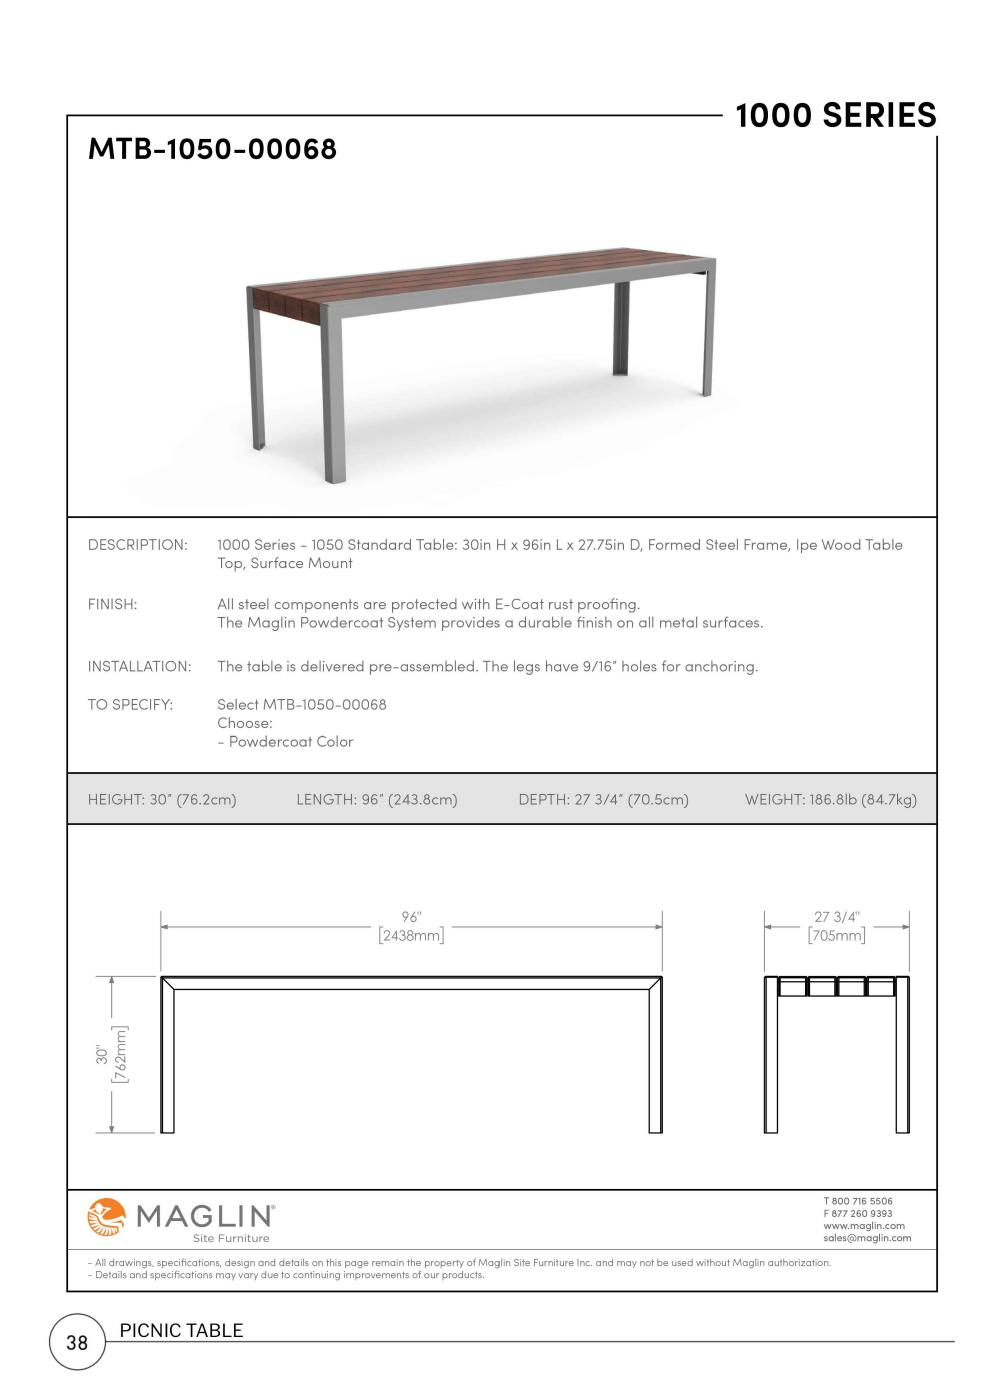


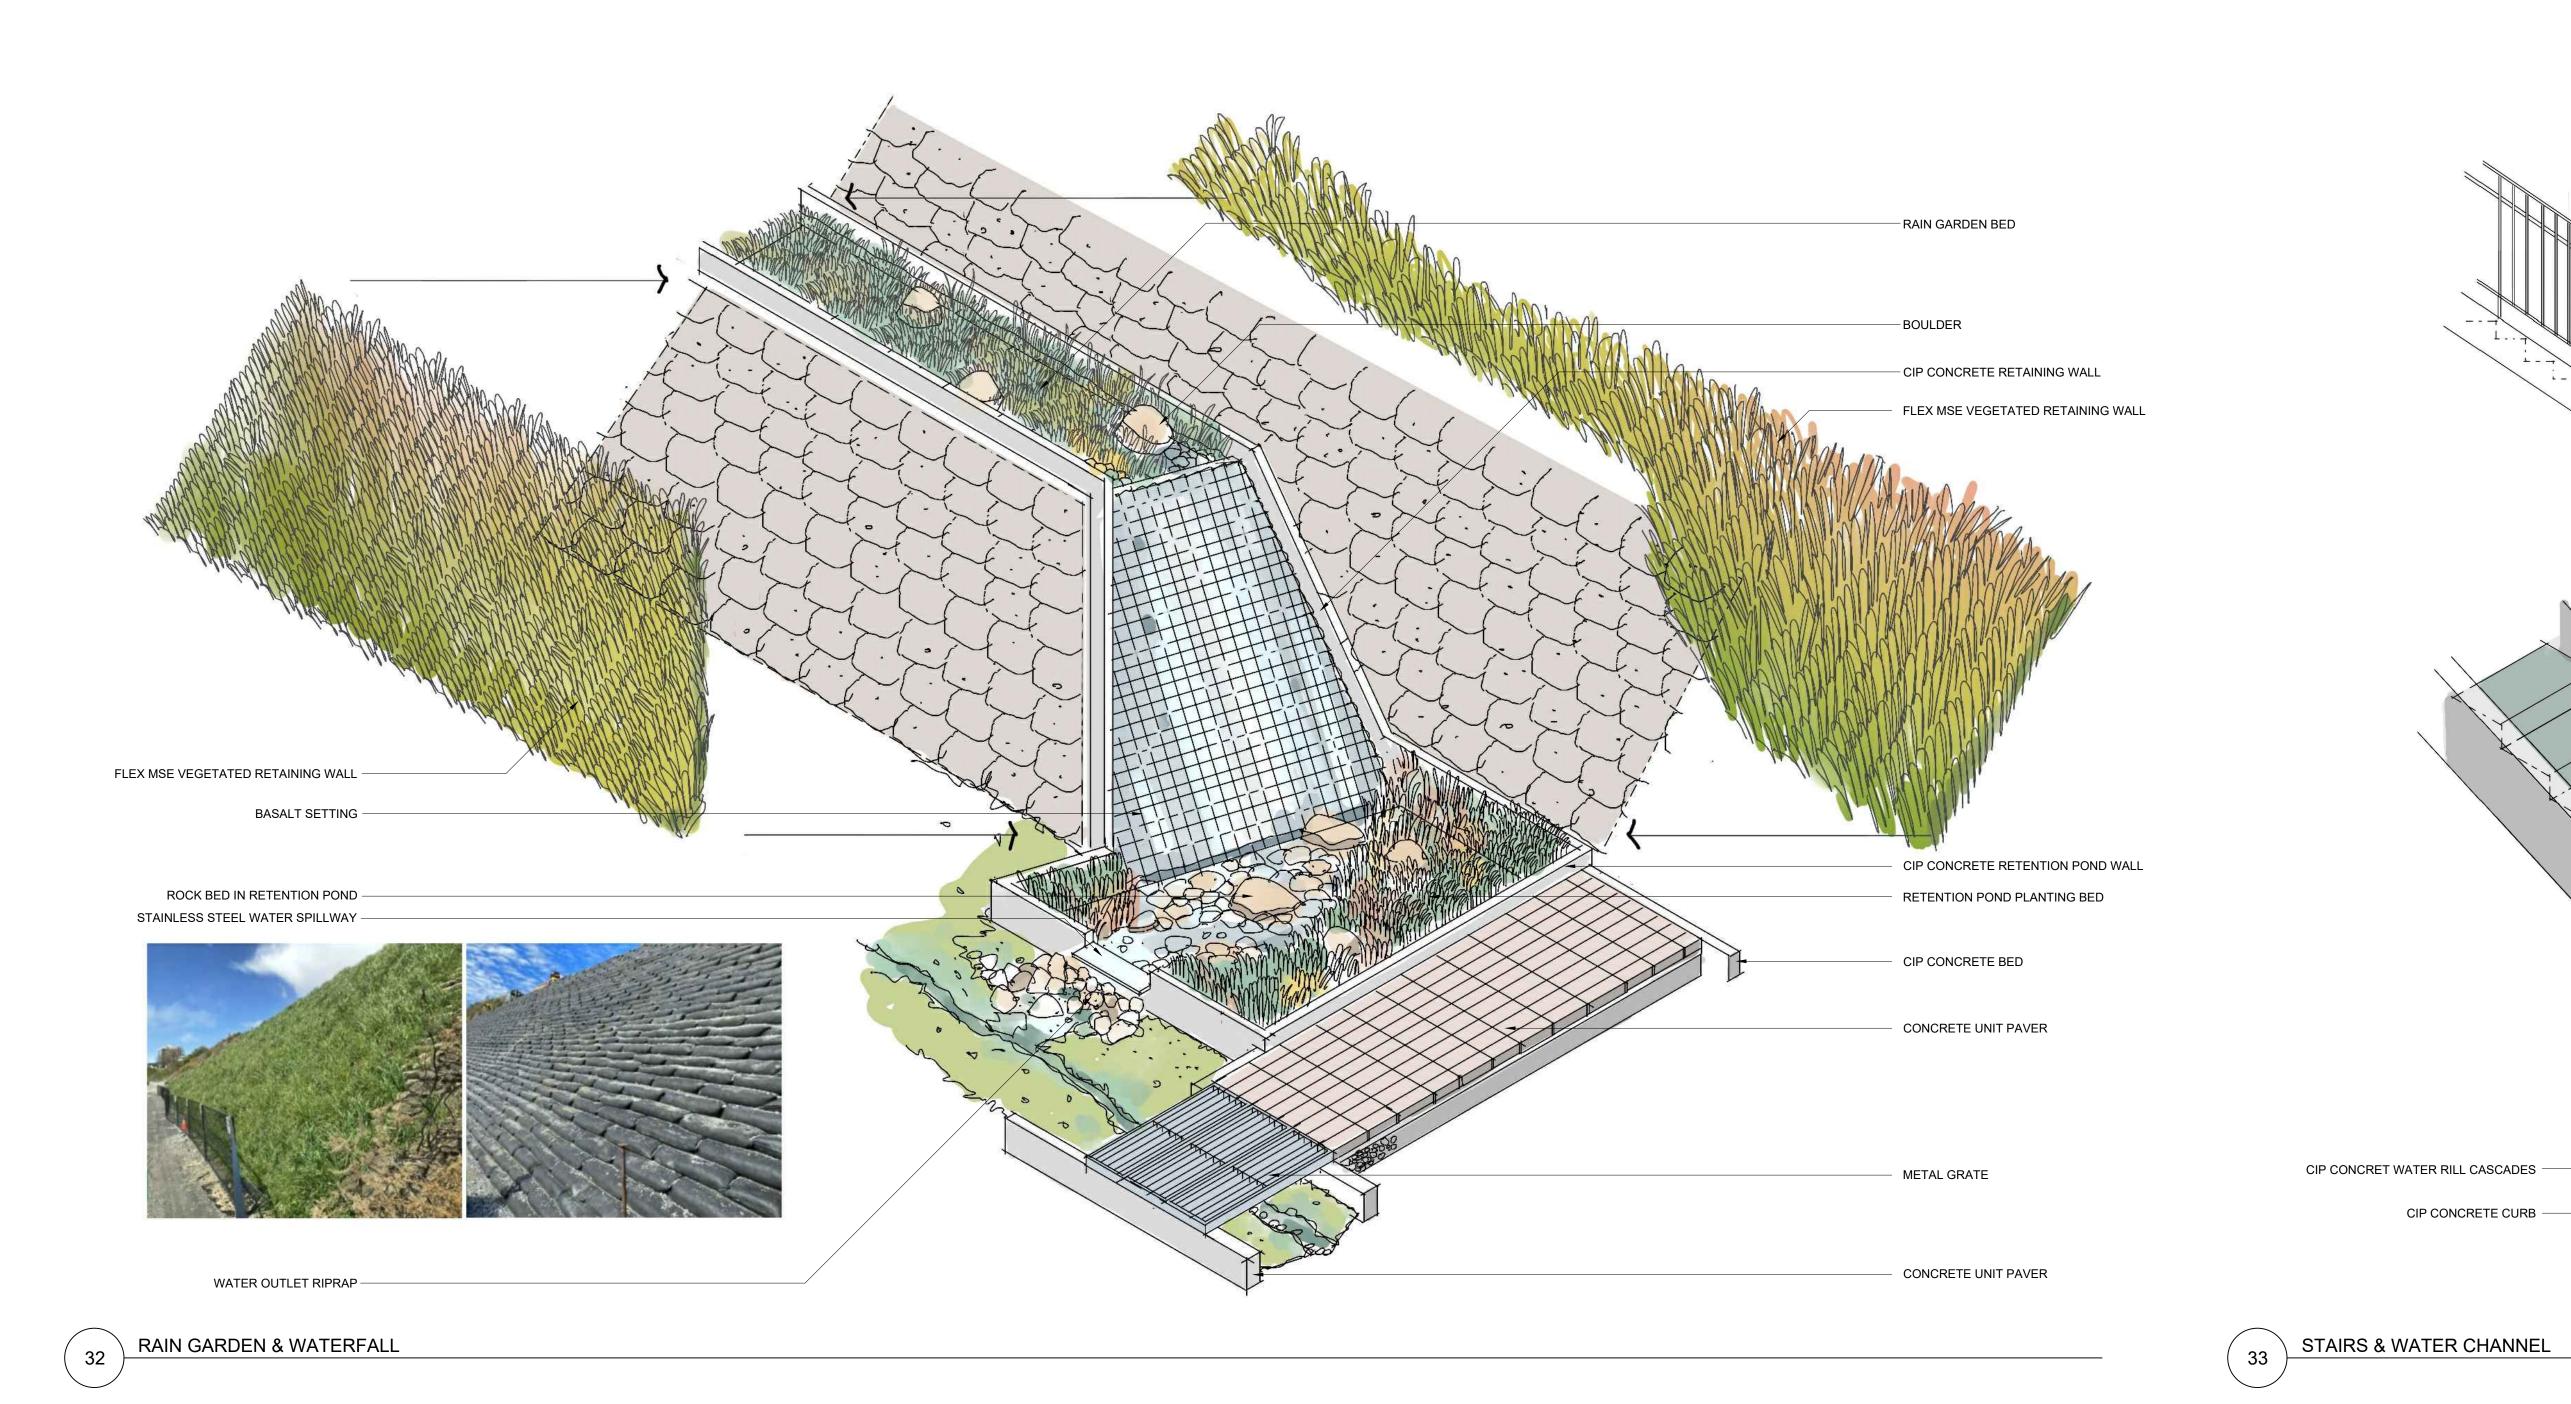


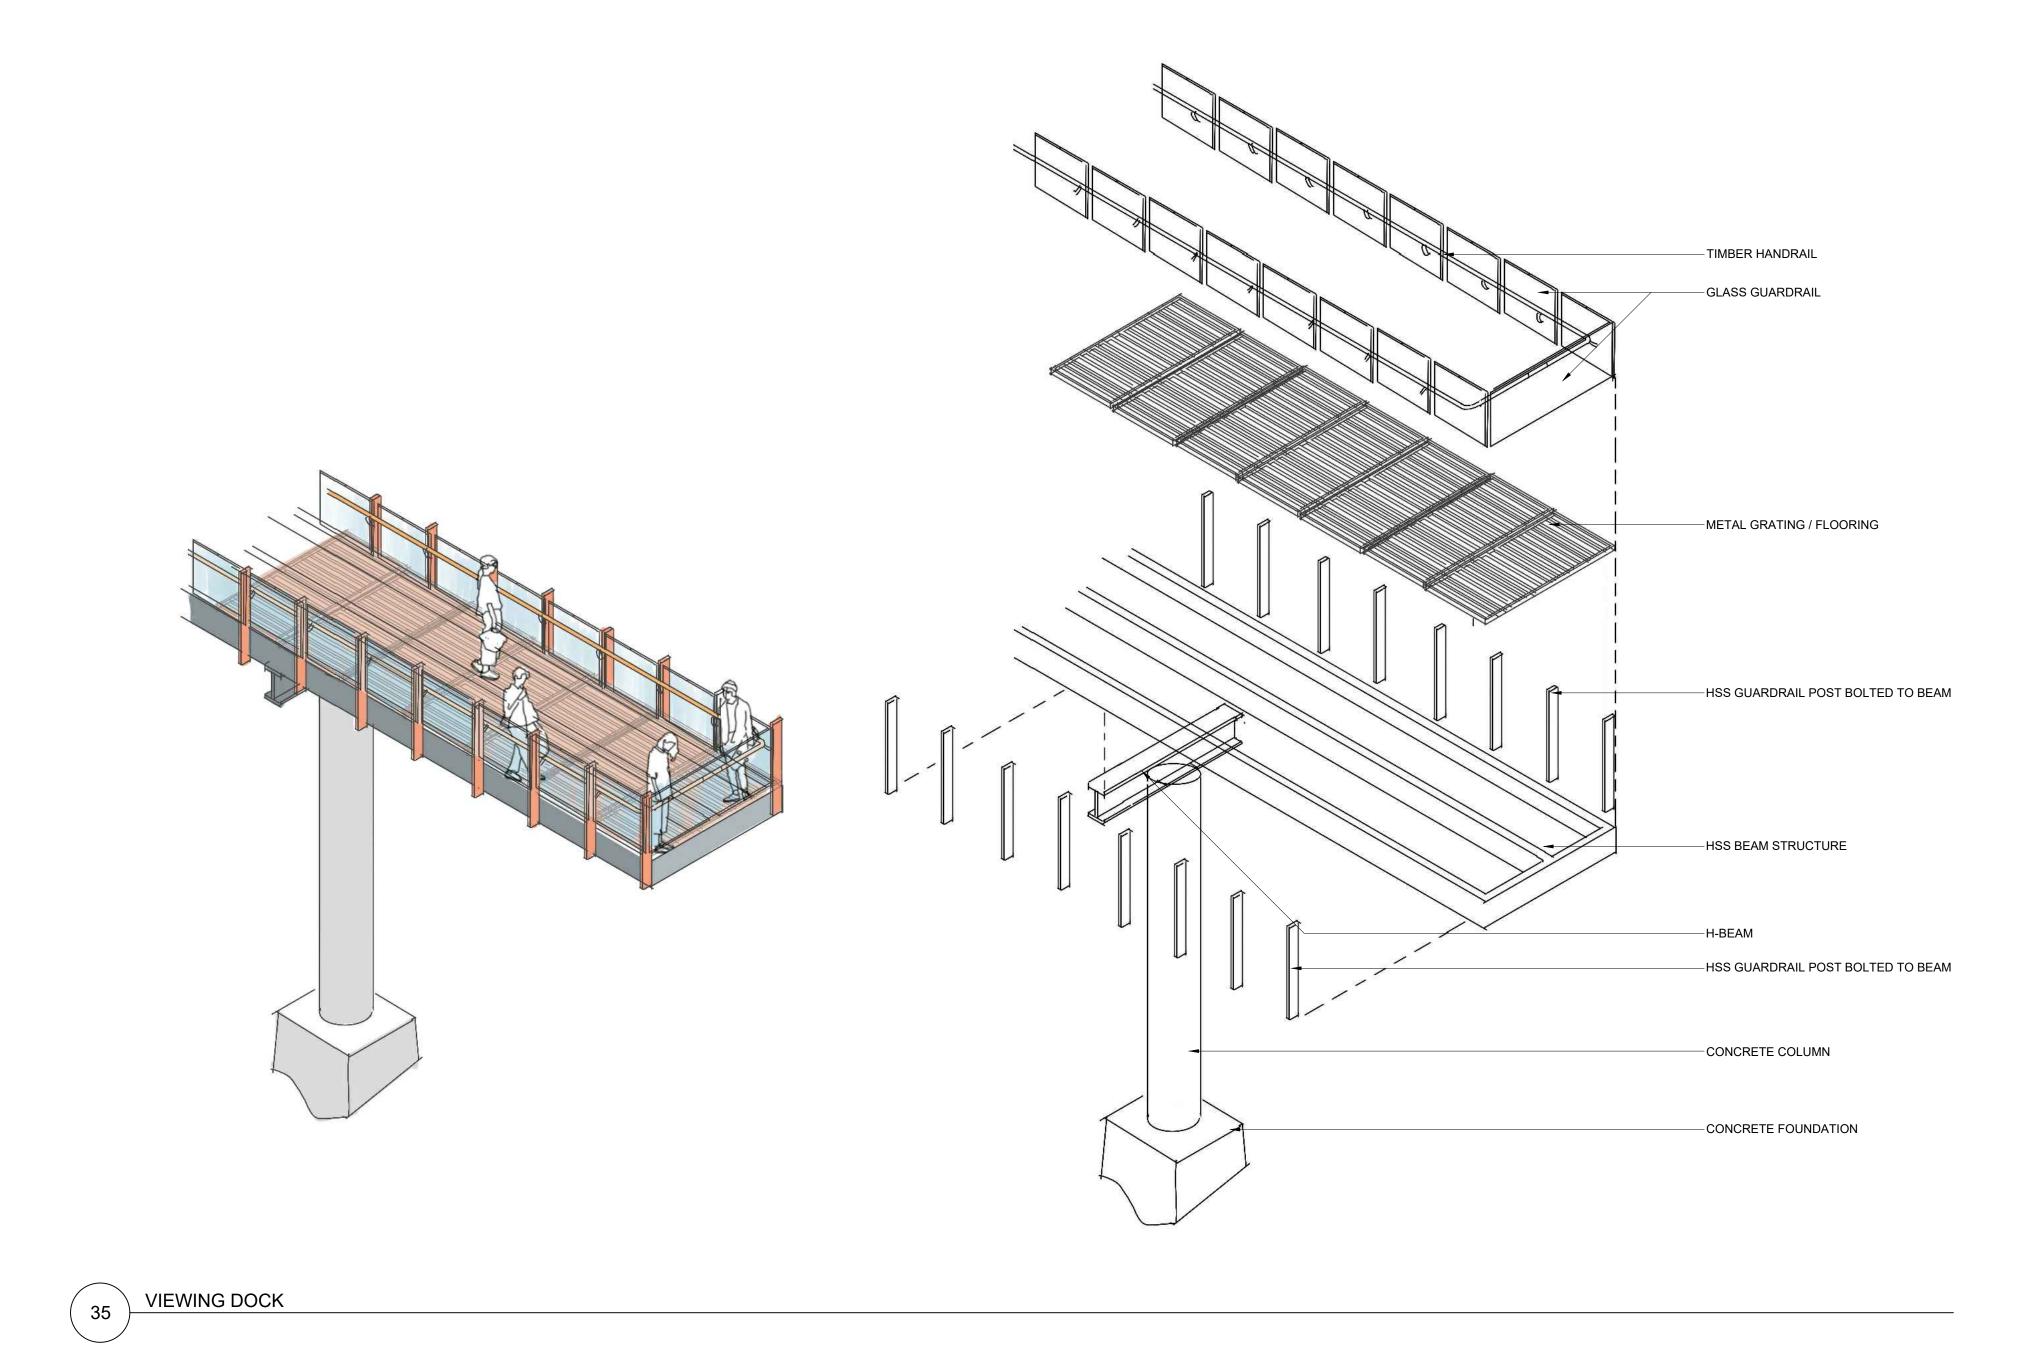


TIMBER PLATFORM



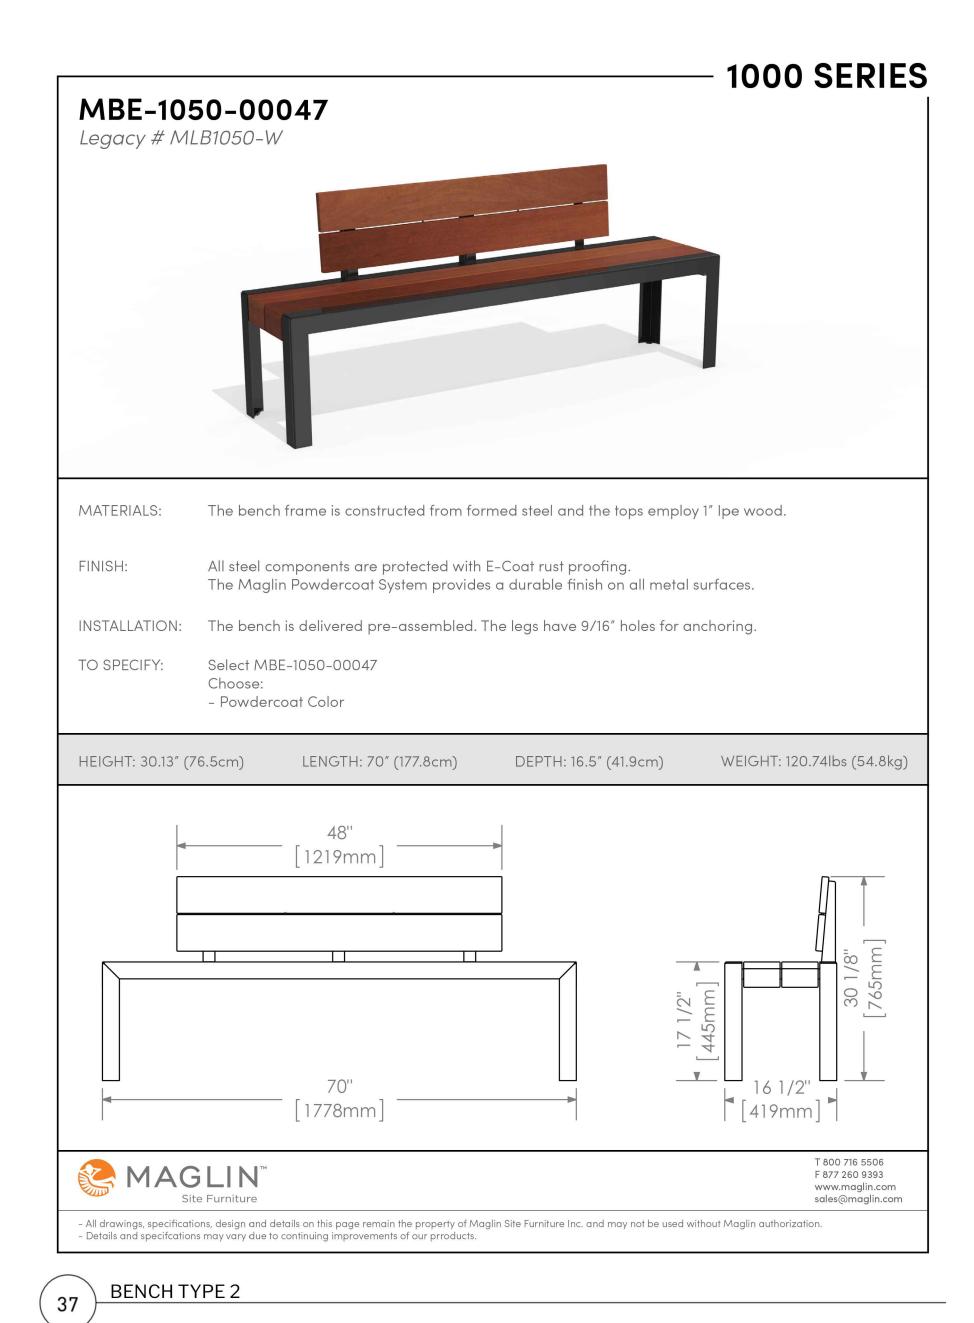

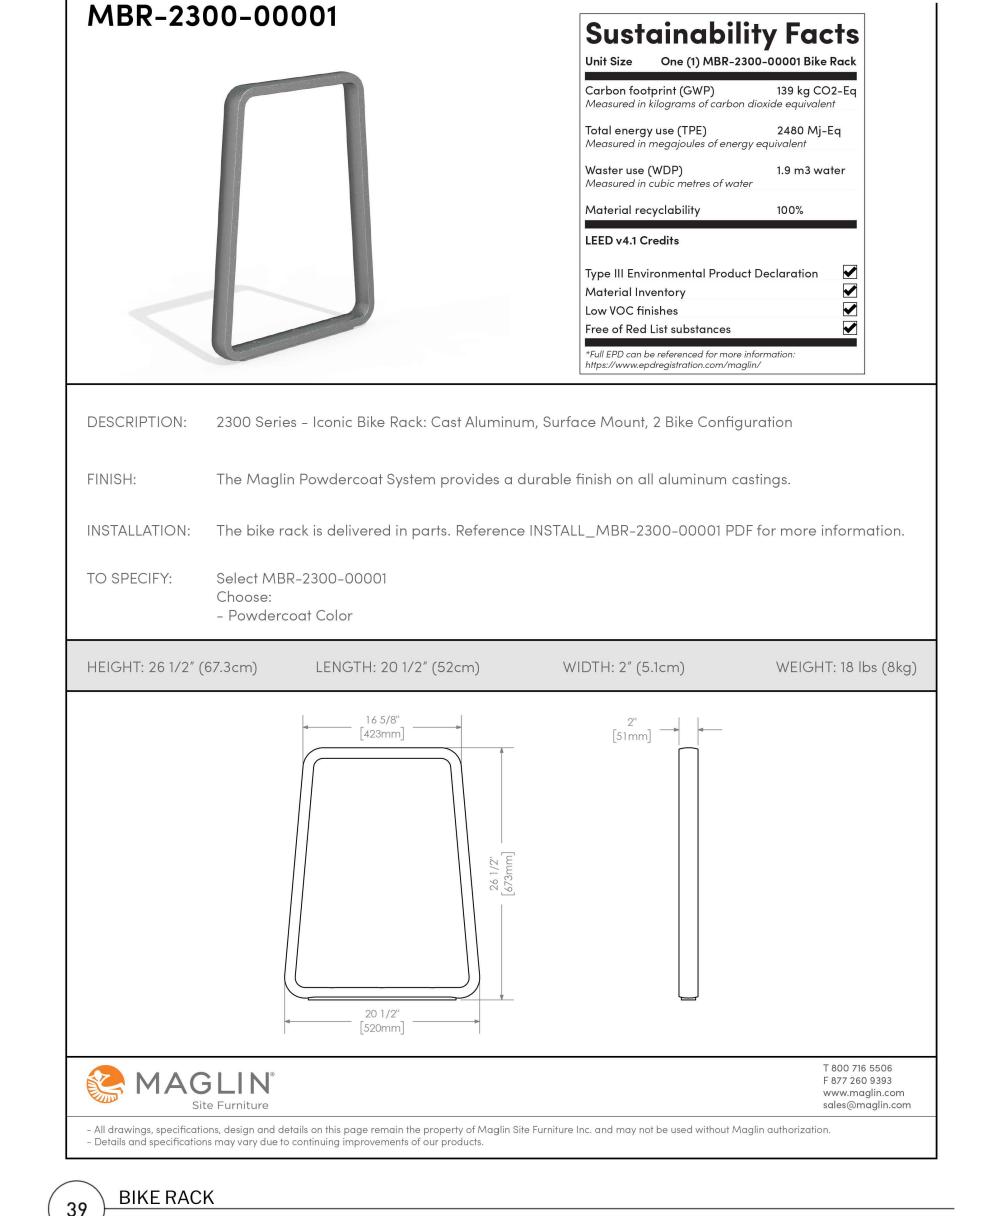


ICONIC

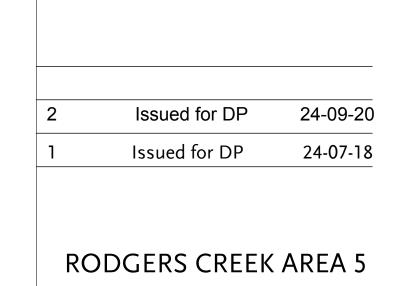

LANDSCAPE DETAILS

Drawing No.

Drawing Title

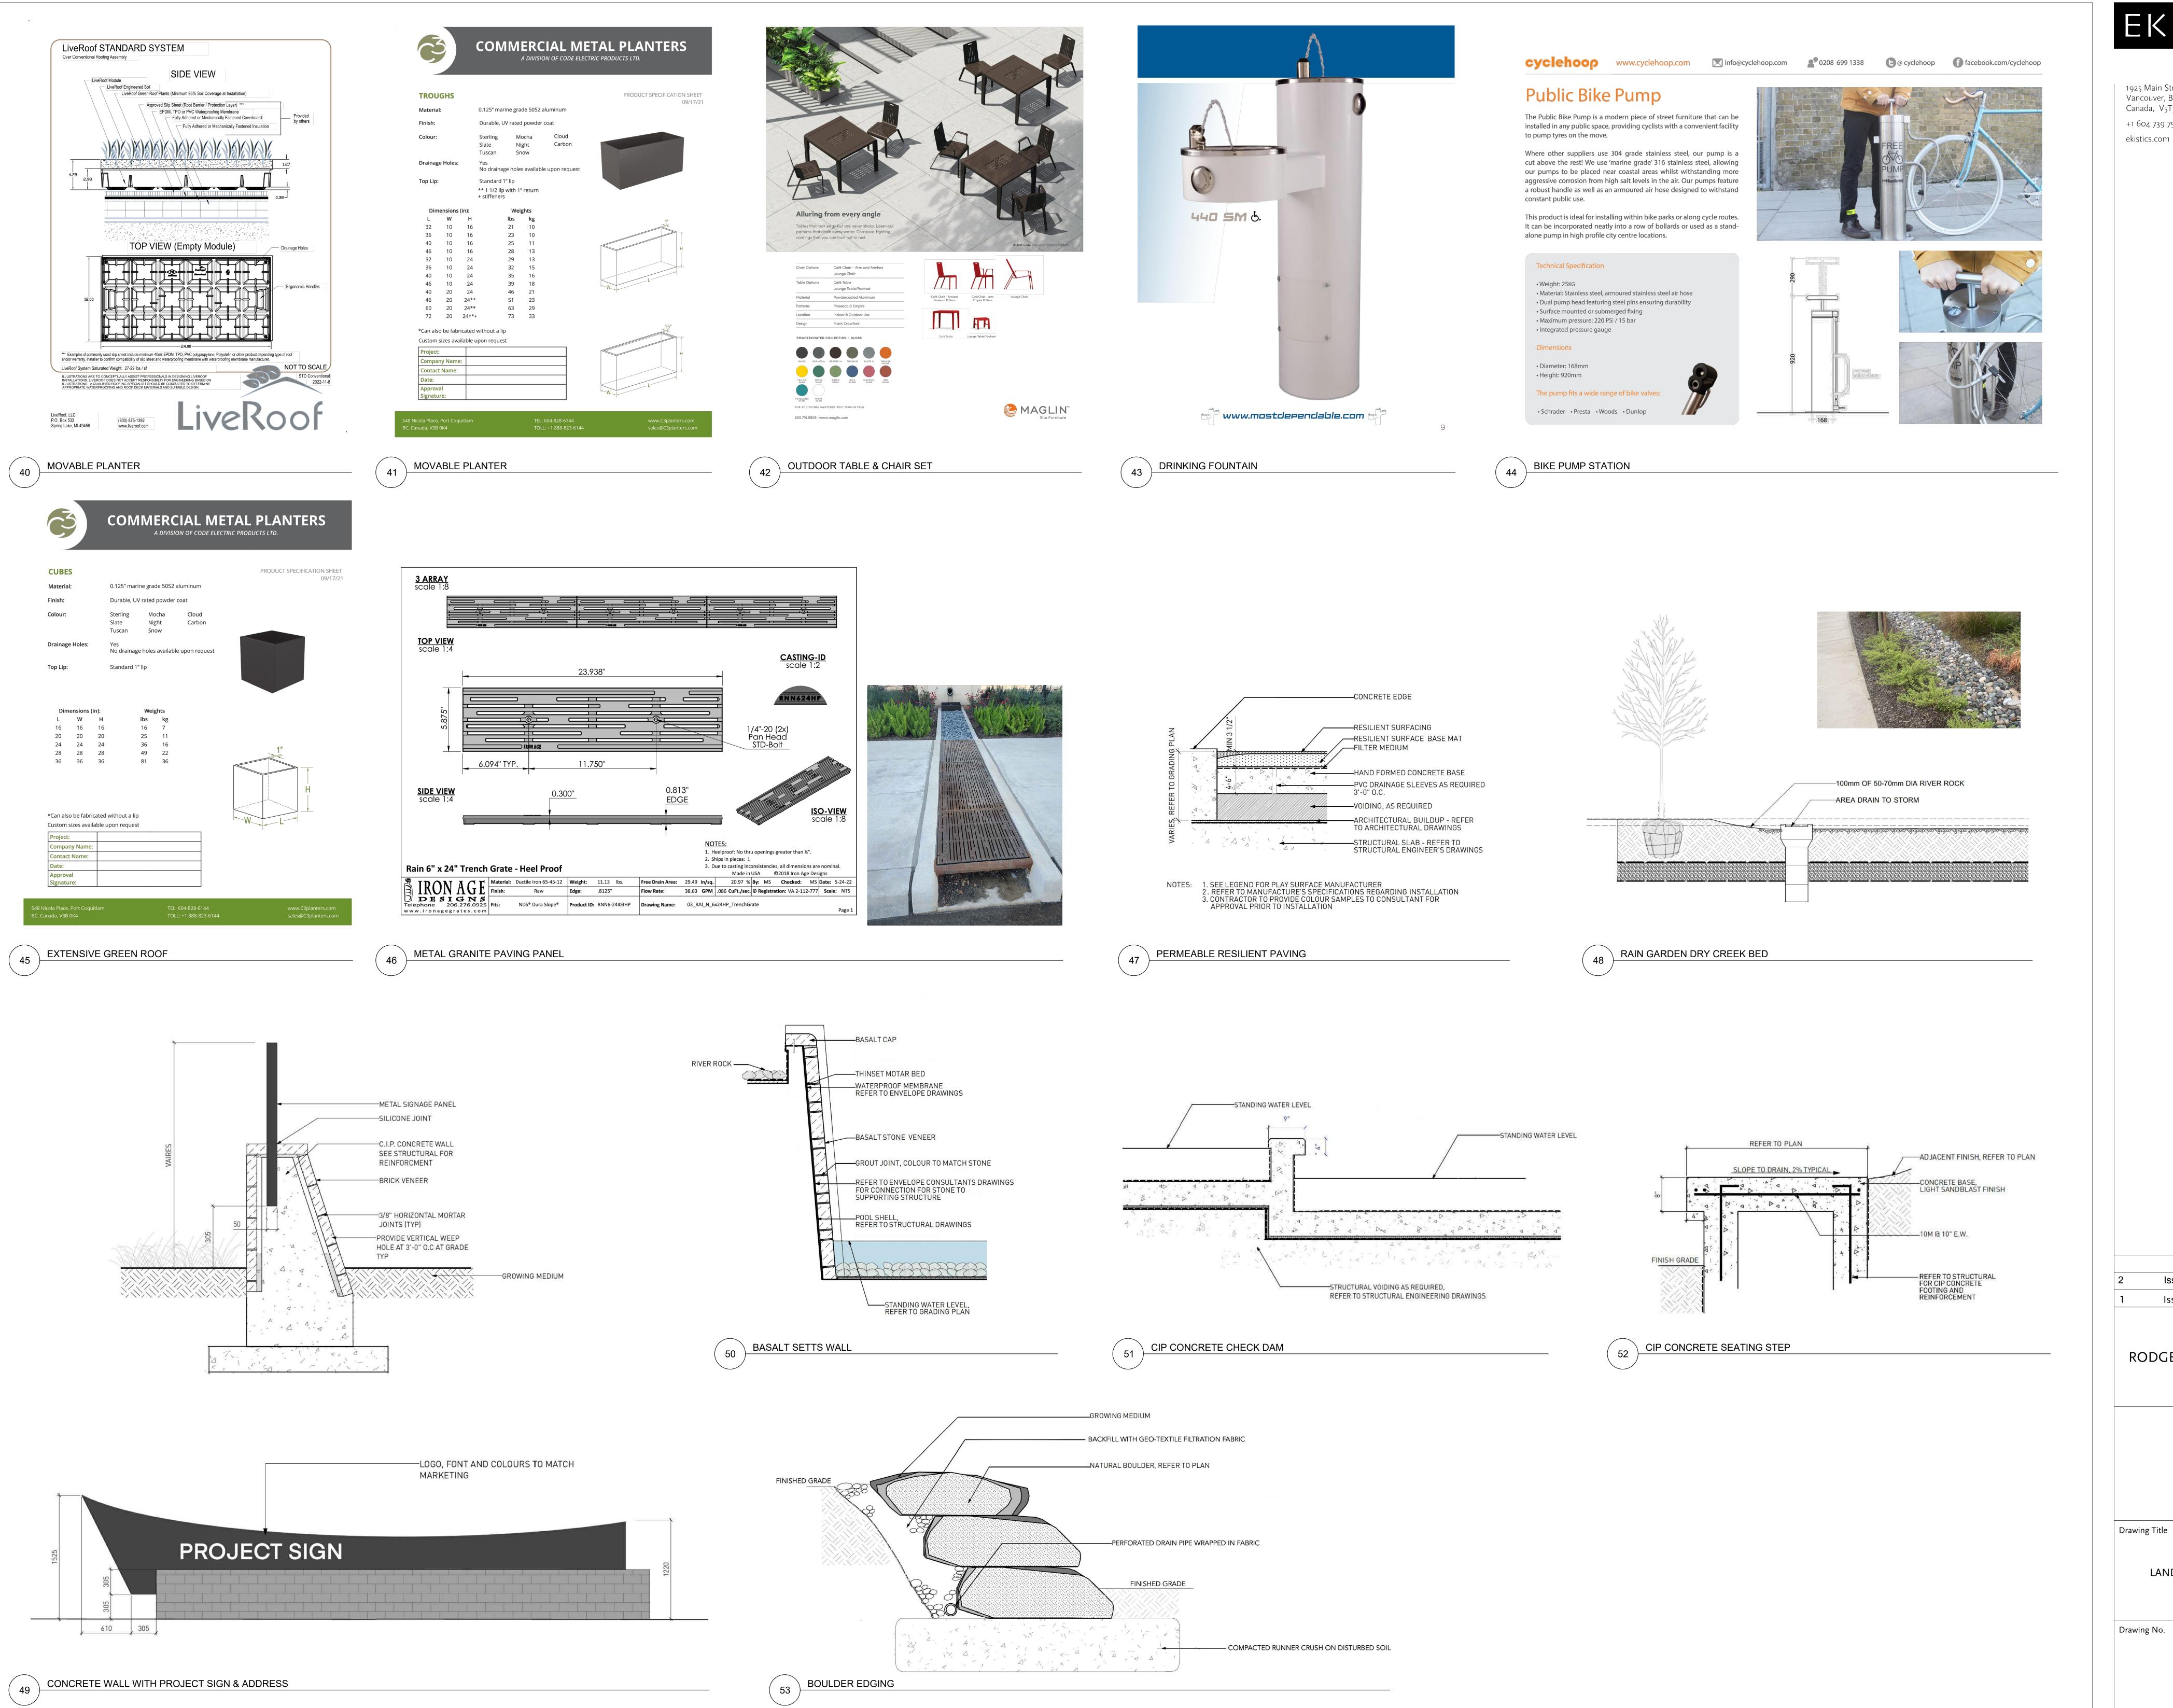

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Drawing No.