

FINAL LANDSCAPE DRAWINGS


SEWELL'S LANDING 6409 Bay Street, Horseshoe Bay, BC

ISSUE FOR DEVELOPMENT PERMIT 28 JANUARY 2016

တ	AD			Not in Contract
z	ALT	Area Drain Alternate	N I C NO	Number
-	ALUM	Alternate	NTS	Not to Scale
_	ARCH	Architect/ Architectural	OC NIS	On Center
-	AVG	Average	OD	Outside Diameter/Dimension
⋖	В	Bottom	PC PC	Point of Curvature
>	BC	Bottom of Curb Elevation	PERP	Perpendicular
<u>ш</u>	BLDG	Building	PERP PI	Point of Intersection
~	BOL	Bollard		Property Line
ш	BP	Bottom of Pool	PL PLNT	Plant/ Planting
<u>_</u>	BS			Point of Origin
⋖	BTW	Bottom of Step/ Stair Elevation	PO	Pedestrian Pole
		Between	PP	Pour-in-Place
-	BW CB	Bottom of Wall Elevation	PIP	
۲ ح	CIV	Catch Basin	PSI	Pounds per Square Inch Point of Tangency
		Civil	PT	0 ,
_	CJ	Control Joint	QTY	Quantity
[]	COJ	Construction Joint	R	Riser
ш	COMP	Compacted	RA	Radius
_	CONC	Concrete	REBAR	Reinforcing Bar
-	DEG	Degree	REQ	Required
エ	DET	Detail	ROW	Right of Way
ပ	D I A	Diameter	SB	Setback
∝	DIM	Dimension	SHT	Sheet
⋖	DN	Down	SPEC	Specifications
ш	DWG	Drawing	SECT	Section
_	EJ	Expansion Joint	SQ	Square
4	ENG	Engineer/ Engineering	SS	Stainless Steel
ان	EQ	Equal	STA PT	Station Point
ဟ	EX	Existing	STD	Standard
	FC	Flush Curb	STL	Steel
z	FDN	Foundation	STR/STRUC	Structure/ Structural
⋖	FG	Finish Grade	T	Тор
_	FIN	Finish	T+B	Top and Bottom
	FTG	Footing	TAN	Tangency
	FTN	Fountain	TC	Top of Curb Elevation
	GALV	Galvanized	TD	Trench Drain
	HEF	Horizontal Each Face	TEMP	Temporary
	HP	High Point	THK	Thick
	HT	Height	TOS	Top of Slab
	HWL	High Water Level	TPZ	Tree Protection Zone
	I D	Inside Diameter/Dimension	TS	Top of Step/ Stair Elevation
	INCL	Include/ Including	TW	Top of Wall Elevation
	JT	Joint	TYP	Typical
	LARCH	Landscape Architect	VERT	Vertical
	LOW	Limit of Work	VEF	Vertical Each Face
	LT	Light	w/	with
	M	Meters/ Metres	w/o	without
	MAX	Maximum	WF	Water Feature
	MIN	Minimum	WJ	Water Jet
		Miscellaneous	WL	Water Level
	MISC	WISCEIIAHEOUS	WL	Water Lever

GENERAL G1.01	DRAWING INDEX + GENERAL INFORMATION
LANDSCA	PE ARCHITECTURAL DRAWINGS
L1.00	SITE PLAN RENDERING
L1.01	TREE MANAGEMENT PLAN
L2.01	MATERIALS PLAN - AREA 1
L2.02	MATERIALS PLAN - AREA 2
L2.03	MATERIALS PLAN - AREA 3: NELSON AVE
L4.01	PLANTING PLAN - AREA 1
L4.02	PLANTING PLAN - AREA 2
L4.03	PLANTING PLAN - AREA 3: NELSON AVE
L5.01	GRADING PLAN - AREA 1
L5.02	GRADING PLAN - AREA 2
L6.01	LIGHTING CONCEPT PLAN
L8.01	SECTIONS
L8.02	SECTIONS
L9.01	DETAILS - PAVING
L9.02	DETAILS - PAVING
L9.03	DETAILS - SITE FURNISHINGS
L9.04	DETAILS - PLANTING
L10.01	PRECEDENT IMAGES
L10.02	PRECEDENT IMAGES

firm: MERRICK date: 2016.01.15 e) dwg: SURVEY MS2745N-PARCEL C-15038-TOP.dwg firm: CHAPMAN LAND SURVEY LTD date: 2015.03.17 1. GRIDLINES SHOWN ON LANDSCAPE DRAWINGS ARE AS PER ARCHITECTURAL LAYOUT. 2. DO NOT SCALE DRAWINGS. USE DIMENSIONAL INFORMATION AS NOTED IN DRAWINGS. CONTACT THE LANDSCAPE ARCHITECT IMMEDIATELY IF THERE IS ANY AMBIGUITY, LACK OF INFORMATION OR INCONSISTENCY, DISREGARD FOR THIS NOTE AND EXTRA COSTS INCURRED WILL NOT BE ACCEPTED. 3. LAYOUT AND MATERIALS DRAWINGS ARE TO BE READ IN CONJUNCTION WITH LANDSCAPE SPECIFICATIONS FOR COMPLIANCE. 4. LANDSCAPE DRAWINGS ARE TO BE READ IN CONJUNCTION WITH ARCHITECTURAL AND ENGINEERING DRAWINGS, REPORT ANY DISCREPANCIES TO THE CONSULTANT FOR REVIEW AND RESPONSE, 5. ALLL LINES AND DIMENSIONS ARE PARALLEL OR PERPENDICULAR TO THE LINES RROM WHICH THEY ARE MEASURED/ REFERENCED UNLESS NOTED OTHERWISE. 6. VERIFY ALL DIMENSIONS WITH FIELD CONDITIONS, REPORT ANY DISCREPANCIES TO THE CONSULTANT FOR REVIEW AND RESPONSE, 7. UTILITY AND LIGHTING ARE INDICATED FOR REFERENCE ONLY. REFER TO ENG. DRAWINGS FOR LOCATIONS, DETAILS, AND SPECIFICATIONS. 8. REFER TO ENGINEERING DRAWINGS FOR SUBGRADE, AND REINFORCING OF ALL PAYED SURFACES IN ROADWAYS. 9. THE CONTRACTOR SHALL VERIFY DIMENSIONS SHOWN ON DRAWINGS AND NOTIFY THE LANDSCAPE ARCHITECT OF ANY DISCREPENCIES OR INCONSISTENCIES PRIOR TO CONSTRUCTION. 10. PROVIDE IRRIGATION FOR ALL SOFT LANDSCAPING INCLUDING GROUNDCOVERS, SHRUBS, AND GREENROOF, COULEE RE-ESTABLISHMENT PLANTING AFTER ESTABLISHED SHALL NOT BE IRRIGATED. 11. PROVIDE ADEQUATE SUB-SURFACE DRAINAGE IN ALL PLANTED AREAS.	xis	ting survey information is based on the following drawings:
firm: MERRICK date: 2015.12.00) dwg: A2.04 Parking P1.dwg firm: MERRICK date: 2015.12.00) dwg: A2.05 Level 1.dwg firm: MERRICK date: 2015.12.00) dwg: SURVEY MS2745N-PARCEL C-15038-TOP.dwg firm: CHAPMAN LAND SURVEY LTD date: 2015.03.17 GRIDLINES SHOWN ON LANDSCAPE DRAWINGS ARE AS PER ARCHITECTURAL LAYOUT. . DO NOT SCALE DRAWINGS. USE DIMENSIONAL INFORMATION AS NOTED IN DRAWINGS. CONTACT THE LANDSCAPE ARCHITECT IMMEDIATELY IF THERE IS ANY AMBIGUITY. LACK OF INFORMATION OR INCONSISTENCY. DISREGARD FOR THIS NOTE AND EXTRA COSTS INCURRED WILL NOT BE ACCEPTED. . LAYOUT AND MATERIALS DRAWINGS ARE TO BE READ IN CONJUNCTION WITH LANDSCAPE SPECIFICATIONS FOR COMPLIANCE. LANDSCAPE DRAWINGS ARE TO BE READ IN CONJUNCTION WITH ARCHITECTURAL AND ENGINEERING DRAWINGS. REPORT ANY DISCREPANCIES TO THE CONSULTANT FOR REVIEW AND RESPONSE. . ALL LINES AND DIMENSIONS ARE PARALLEL OR PERPENDICULAR TO THE LINES FROM WHICH THEY ARE MEASURED/ REFERENCED UNLESS NOTED OTHERWISE. . VERIFY ALL DIMENSIONS WITH FIELD CONDITIONS. REPORT ANY DISCREPANCIES TO THE CONSULTANT FOR REVIEW AND RESPONSE. . UTILITY AND LIGHTING ARE INDICATED FOR REFERENCED UNLESS NOTED OTHERWISE. . VERIFY ALL DIMENSIONS WITH FIELD CONDITIONS. REPORT ANY DISCREPANCIES TO THE CONSULTANT FOR REVIEW AND RESPONSE. . UTILITY AND LIGHTING ARE INDICATED FOR REFERENCE ONLY. REFER TO ENG. DRAWWINGS FOR LOCATIONS, DETAILS, AND SPECIFICATIONS. REFER TO ENGINEERING DRAWINGS FOR SUBGRADE, AND REINFORCING OF ALL PAVED SURFACES IN ROADWAYS. . THE CONTRACTOR SHALL VERIFY DIMENSIONS SHOWN ON DRAWINGS AND NOTIFY THE LANDSCAPE ARCHITECT OF ANY DISCREPENCIES OR INCONSISTENCIES PRIOR TO CONSTRUCTION. 0. PROVIDE IRRIGATION FOR ALL SOFT LANDSCAPING INCLUDING GROUNDCOVERS, SHRUBS, AND GREENROOF. COULEE RE-ESTABLISHMENT PLANTING AFTER ESTABLISHED SHALL NOT BE IRRIGATED. 1. PROVIDE ADEQUATE SUB-SURFACE DRAINAGE IN ALL PLANTED AREAS. 2. SEE CIVIL AND ARCHITECTURAL DRAWINGS FOR BUILDING PERIMETER	1	firm: MERRICK
Itim: MERRICK date: 2015,12,00) dwg: A2.05 Level 1.dwg firm: MERRICK date: 2015,12,00) dwg: SURVEY MS2745N-PARCEL C-15038-TOP.dwg firm: CHAPMAN LAND SURVEY LTD date: 2015,03,17 GRIDLINES SHOWN ON LANDSCAPE DRAWINGS ARE AS PER ARCHITECTURAL LAYOUT. DO NOT SCALE DRAWINGS. USE DIMENSIONAL INFORMATION AS NOTED IN DRAWINGS. CONTACT THE LANDSCAPE ARCHITECT IMMEDIATELY IF THERE IS ANY AMBIGUITY, LACK OF INFORMATION OR INCONSISTENCY, DISREGARD FOR THIS NOTE AND EXTRA COSTS INCURRED WILL NOT BE ACCEPTED. LAYOUT AND MATERIALS DRAWINGS ARE TO BE READ IN CONJUNCTION WITH LANDSCAPE SPECIFICATIONS FOR COMPLIANCE. LANDSCAPE DRAWINGS ARE TO BE READ IN CONJUNCTION WITH ARCHITECTURAL AND ENGINEERING DRAWINGS. REPORT ANY DISCREPANCIES TO THE CONSULTANT FOR REVIEW AND RESPONSE, ALL LINES AND DIMENSIONS ARE PARALLEL OR PERPENDICULAR TO THE LINES FROM WHICH THEY ARE MEASURED/REFERENCED UNLESS NOTED OTHERWISE. VERIFY ALL DIMENSIONS WITH FIELD CONDITIONS, REPORT ANY DISCREPANCIES TO THE CONSULTANT FOR REVIEW AND RESPONSE, UTILITY AND LIGHTING ARE INDICATED FOR REFERENCE ONLY, REFER TO ENG. DRAWINGS FOR LOCATIONS, DETAILS, AND SPECIFICATIONS. REFER TO ENGINEERING DRAWINGS FOR SUBGRADE, AND REINFORCING OF ALL PAYED SURFACES IN ROADWAYS. THE CONTRACTOR SHALL VERIFY DIMENSIONS SHOWN ON DRAWINGS AND NOTIFY THE LANDSCAPE ARCHITECT OF ANY DISCREPENCIES OR INCONSISTENCIES PRIOR TO CONSTRUCTION. PROVIDE IRRIGATION FOR ALL SOFT LANDSCAPING INCLUDING GROUNDCOVERS, SHRUBS, AND GREENROOF. COULEE RE-ESTABLISHMENT PLANTING AFTER ESTABLISHED SHALL NOT BE IRRIGATED. PROVIDE ARRIGATION FOR ALL SOFT LANDSCAPING INCLUDING GROUNDCOVERS, SHRUBS, AND GREENROOF. COULEE RE-ESTABLISHMENT PLANTING AFTER ESTABLISHED SHALL NOT BE IRRIGATED.	1	firm: MERRICK
date: 2016.01.15 e) dwg: SURVEY MS2745N-PARCEL C-15038-TOP.dwg firm: CHAPMAN LAND SURVEY LTD date: 2015.03.17 1. GRIDLINES SHOWN ON LANDSCAPE DRAWINGS ARE AS PER ARCHITECTURAL LAYOUT. 2. DO NOT SCALE DRAWINGS. USE DIMENSIONAL INFORMATION AS NOTED IN DRAWINGS. CONTACT THE LANDSCAPE ARCHITECT IMMEDIATELY IF THERE IS ANY AMBIGUITY, LACK OF INFORMATION OR INCONSISTENCY. DISREGARD FOR THIS NOTE AND EXTRA COSTS INCURRED WILL NOT BE ACCEPTED. 3. LAYOUT AND MATERIALS DRAWINGS ARE TO BE READ IN CONJUNCTION WITH LANDSCAPE PECIFICATIONS FOR COMPLIANCE. 4. LANDSCAPE DRAWINGS ARE TO BE READ IN CONJUNCTION WITH ARCHITECTURAL AND ENGINEERING DRAWINGS. REPORT ANY DISCREPANCIES TO THE CONSULTANT FOR REVIEW AND RESPONSE. 5. ALL LINES AND DIMENSIONS ARE PARALLEL OR PERPENDICULAR TO THE LINES FROM WHICH THEY ARE MEASURED REFERENCED UNLESS NOTED OTHERWISE. 6. VERIFY ALL DIMENSIONS WITH FIELD CONDITIONS. REPORT ANY DISCREPANCIES TO THE CONSULTANT FOR REVIEW AND RESPONSE. 7. UTILITY AND LIGHTING ARE INDICATED FOR REFERENCE ONLY. REFER TO ENG. DRAWINGS FOR LOCATIONS, DETAILS, AND SPECIFICATIONS. 8. REFER TO ENGINEERING DRAWINGS FOR SUBGRADE, AND REINFORCING OF ALL PAVED SURFACES IN ROADWAYS. 9. THE CONTRACTOR SHALL VERIFY DIMENSIONS SHOWN ON DRAWINGS AND NOTIFY THE LANDSCAPE ARCHITECT OF ANY DISCREPENCIES OR INCONSISTENCIES PRIOR TO CONSTRUCTION. 10. PROVIDE IRRIGATION FOR ALL SOFT LANDSCAPING INCLUDING GROUNDCOVERS, SHRUBS, AND GREENROOF, COULEE RE-ESTABLISHMENT PLANTING AFTER ESTABLISHED SHALL NOT BE IRRIGATED. 11. PROVIDE ADEQUATE SUB-SURFACE DRAWINGS FOR BUILDING PERIMETER 12. SEE CIVIL AND ARCHITECTURAL DRAWINGS FOR BUILDING PERIMETER	Ĺ.,	firm: MERRICK
If The CHAPMAN LAND SURVEY LTD date: 2015.03.17 GRIDLINES SHOWN ON LANDSCAPE DRAWINGS ARE AS PER ARCHITECTURAL LAYOUT. DO NOT SCALE DRAWINGS. USE DIMENSIONAL INFORMATION AS NOTED IN DRAWINGS. CONTACT THE LANDSCAPE ARCHITECT IMMEDIATELY IF THERE IS ANY AMBIGUITY. LACK OF INFORMATION OR INCONSISTENCY. DISREGARD FOR THIS NOTE AND EXTRA COSTS INCURRED WILL NOT BE ACCEPTED. LAYOUT AND MATERIALS DRAWINGS ARE TO BE READ IN CONJUNCTION WITH LANDSCAPE SPECIFICATIONS FOR COMPLIANCE. LANDSCAPE DRAWINGS ARE TO BE READ IN CONJUNCTION WITH ARCHITECTURAL AND ENGINEERING DRAWINGS. REPORT ANY DISCREPANCIES TO THE CONSULTANT FOR REVIEW AND RESPONSE. ALL LINES AND DIMENSIONS ARE PARALLEL OR PERPENDICULAR TO THE LINES FROM WHICH THEY ARE MEASURED/REFERENCED UNLESS NOTED OTHERWISE. VERIFY ALL DIMENSIONS WITH FIELD CONDITIONS. REPORT ANY DISCREPANCIES TO THE CONSULTANT FOR REVIEW AND RESPONSE. UTILITY AND LIGHTING ARE INDICATED FOR REFERENCE ONLY. REFER TO ENG. DRAWINGS FOR LOCATIONS, DETAILS, AND SPECIFICATIONS. REFER TO ENGINEERING DRAWINGS FOR SUBGRADE, AND REINFORCING OF ALL PAVED SURFACES IN ROADWAYS. THE CONTRACTOR SHALL VERIFY DIMENSIONS SHOWN ON DRAWINGS AND NOTIFY THE LANDSCAPE ARCHITECT OF ANY DISCREPENCIES OR INCONSISTENCIES PRIOR TO CONSTRUCTION. PROVIDE IRRIGATION FOR ALL SOFT LANDSCAPING INCLUDING GROUNDCOVERS, SHRUBS, AND GREENROOF. COULEE RE-ESTABLISHMENT PLANTING AFTER ESTABLISHED SHALL NOT BE IRRIGATED.	- 1	firm: MERRICK
ARCHITECTURAL LAYOUT. 2. DO NOT SCALE DRAWINGS. USE DIMENSIONAL INFORMATION AS NOTED IN DRAWINGS. CONTACT THE LANDSCAPE ARCHITECT IMMEDIATELY IF THERE IS ANY AMBIGUITY. LACK OF INFORMATION OR INCONSISTENCY. DISREGARD FOR THIS NOTE AND EXTRA COSTS INCURRED WILL NOT BE ACCEPTED. 3. LAYOUT AND MATERIALS DRAWINGS ARE TO BE READ IN CONJUNCTION WITH LANDSCAPE SPECIFICATIONS FOR COMPILANCE. 4. LANDSCAPE DRAWINGS ARE TO BE READ IN CONJUNCTION WITH ARCHITECTURAL AND ENGINEERING DRAWINGS. REPORT ANY DISCREPANCIES TO THE CONSULTANT FOR REVIEW AND RESPONSE. 5. ALL LINES AND DIMENSIONS ARE PARALLEL OR PERPENDICULAR TO THE LINES FROM WHICH THEY ARE MEASURED! REFERENCED UNLESS NOTED OTHERWISE. 6. VERIFY ALL DIMENSIONS WITH FIELD CONDITIONS. REPORT ANY DISCREPANCIES TO THE CONSULTANT FOR REVIEW AND RESPONSE. 7. UTILITY AND LIGHTING ARE INDICATED FOR REFERENCE ONLY. REFER TO ENG. DRAWINGS FOR LOCATIONS, DETAILS, AND SPECIFICATIONS. 8. REFER TO ENGINEERING DRAWINGS FOR SUBGRADE, AND REINFORCING OF ALL PAVED SUFFACES IN ROADWAYS. 9. THE CONTRACTOR SHALL VERIFY DIMENSIONS SHOWN ON DRAWINGS AND NOTIFY THE LANDSCAPE ARCHITECT OF ANY DISCREPENCIES OR INCONSISTENCIES PRIOR TO CONSTRUCTION. 10. PROVIDE IRRIGATION FOR ALL SOFT LANDSCAPING INCLUDING GROUNDCOVERS, SHRUBS, AND GREENROOF, COULEE RE-ESTABLISHMENT PLANTING AFTER ESTABLISHED SHALL NOT BE IRRIGATED. 11. PROVIDE ADEQUATE SUB-SURFACE DRAWINGS FOR BUILDING PERIMETER	- 1	firm: CHAPMAN LAND SURVEY LTD
ARCHITECTURAL LAYOUT. 2. DO NOT SCALE DRAWINGS. USE DIMENSIONAL INFORMATION AS NOTED IN DRAWINGS. CONTACT THE LANDSCAPE ARCHITECT IMMEDIATELY IF THERE IS ANY AMBIGUITY. LACK OF INFORMATION OR INCONSISTENCY. DISREGARD FOR THIS NOTE AND EXTRA COSTS INCURRED WILL NOT BE ACCEPTED. 3. LAYOUT AND MATERIALS DRAWINGS ARE TO BE READ IN CONJUNCTION WITH LANDSCAPE SPECIFICATIONS FOR COMPILANCE. 4. LANDSCAPE DRAWINGS ARE TO BE READ IN CONJUNCTION WITH ARCHITECTURAL AND ENGINEERING DRAWINGS. REPORT ANY DISCREPANCIES TO THE CONSULTANT FOR REVIEW AND RESPONSE. 5. ALL LINES AND DIMENSIONS ARE PARALLEL OR PERPENDICULAR TO THE LINES FROM WHICH THEY ARE MEASURED! REFERENCED UNLESS NOTED OTHERWISE. 6. VERIFY ALL DIMENSIONS WITH FIELD CONDITIONS. REPORT ANY DISCREPANCIES TO THE CONSULTANT FOR REVIEW AND RESPONSE. 7. UTILITY AND LIGHTING ARE INDICATED FOR REFERENCE ONLY. REFER TO ENG. DRAWINGS FOR LOCATIONS, DETAILS, AND SPECIFICATIONS. 8. REFER TO ENGINEERING DRAWINGS FOR SUBGRADE, AND REINFORCING OF ALL PAVED SUFFACES IN ROADWAYS. 9. THE CONTRACTOR SHALL VERIFY DIMENSIONS SHOWN ON DRAWINGS AND NOTIFY THE LANDSCAPE ARCHITECT OF ANY DISCREPENCIES OR INCONSISTENCIES PRIOR TO CONSTRUCTION. 10. PROVIDE IRRIGATION FOR ALL SOFT LANDSCAPING INCLUDING GROUNDCOVERS, SHRUBS, AND GREENROOF, COULEE RE-ESTABLISHMENT PLANTING AFTER ESTABLISHED SHALL NOT BE IRRIGATED. 11. PROVIDE ADEQUATE SUB-SURFACE DRAWINGS FOR BUILDING PERIMETER		
IN DRAWINGS, CONTACT THE LANDSCAPE ARCHITECT IMMEDIATELY IF THERE IS ANY AMBIGUITY, LACK OF INFORMATION OR INCONSISTENCY. DISREGARD FOR THIS NOTE AND EXTRA COSTS INCURRED WILL NOT BE ACCEPTED. 3. LAYOUT AND MATERIALS DRAWINGS ARE TO BE READ IN CONJUNCTION WITH LANDSCAPE SPECIFICATIONS FOR COMPLIANCE. 4. LANDSCAPE DRAWINGS ARE TO BE READ IN CONJUNCTION WITH ARCHITECTURAL AND ENGINEERING DRAWINGS. REPORT ANY DISCREPANCIES TO THE CONSULTANT FOR REVIEW AND RESPONSE. 5. ALL LINES AND DIMENSIONS ARE PARALLEL OR PERPENDICULAR TO THE LINES FROM WHICH THEY ARE MEASURED/REFERENCED UNLESS NOTED OTHERWISE. 6. VERIFY ALL DIMENSIONS WITH FIELD CONDITIONS. REPORT ANY DISCREPANCIES TO THE CONSULTANT FOR REVIEW AND RESPONSE. 7. UTILITY AND LIGHTING ARE INDICATED FOR REFERENCE ONLY. REFER TO ENG. DRAWINGS FOR LOCATIONS, DETAILS, AND SPECIFICATIONS. 8. REFER TO ENGINEERING DRAWINGS FOR SUBGRADE, AND REINFORCING OF ALL PAVED SURFACES IN ROADWAYS. 9. THE CONTRACTOR SHALL VERIFY DIMENSIONS SHOWN ON DRAWINGS AND NOTEY THE LANDSCAPE ARCHITECT OF ANY DISCREPENCIES OR INCONSISTENCIES PRIOR TO CONSTRUCTION. 10. PROVIDE IRRIGATION FOR ALL SOFT LANDSCAPING INCLUDING GROUNDCOVERS, SHRUBS, AND GREENROOF, COULEE RE-ESTABLISHMENT PLANTING AFTER ESTABLISHED SHALL NOT BE IRRIGATED. 11. PROVIDE ADEQUATE SUB-SURFACE DRAWINGS FOR BUILDING PERIMETER		
WITH LANDSCAPE SPECIFICATIONS FOR COMPLIANCE. 4. LANDSCAPE DRAWINGS ARE TO BE READ IN CONJUNCTION WITH ARCHITECTURAL AND ENGINEERING DRAWINGS, REPORT ANY DISCREPANCIES TO THE CONSULTANT FOR REVIEW AND RESPONSE. 5. ALL LINES AND DIMENSIONS ARE PARALLEL OR PERPENDICULAR TO THE LINES RROM WHICH THEY ARE MEASURED/ REFERENCED UNLESS NOTED OTHERWISE. 6. VERIFY ALL DIMENSIONS WITH FIELD CONDITIONS, REPORT ANY DISCREPANCIES TO THE CONSULTANT FOR REVIEW AND RESPONSE. 7. UTILITY AND LIGHTING ARE INDICATED FOR REFERENCE ONLY, REFER TO ENG. DRAWINGS FOR LOCATIONS, DETAILS, AND SPECIFICATIONS. 8. REFER TO ENGINEERING DRAWINGS FOR SUBGRADE, AND REINFORCING OF ALL PAVED SURFACES IN ROADWAYS. 9. THE CONTRACTOR SHALL VERIFY DIMENSIONS SHOWN ON DRAWINGS AND NOTIFY THE LANDSCAPE ARCHITECT OF ANY DISCREPENCIES OR INCONSISTENCIES PRIOR TO CONSTRUCTION. 10. PROVIDE IRRIGATION FOR ALL SOFT LANDSCAPING INCLUDING GROUNDCOVERS, SHRUBS, AND GREENROOF, COULEE RE-ESTABLISHMENT PLANTING AFTER ESTABLISHED SHALL NOT BE IRRIGATED. 11. PROVIDE ADEQUATE SUB-SURFACE DRAINAGE IN ALL PLANTED AREAS. 12. SEE CIVIL AND ARCHITECTURAL DRAWINGS FOR BUILDING PERIMETER		IN DRAWINGS. CONTACT THE LANDSCAPE ARCHITECT IMMEDIATELY IF THERE IS ANY AMBIGUITY, LACK OF INFORMATION OR INCONSISTENCY. DISREGARD FOR THIS NOTE AND EXTRA COSTS INCURRED WILL NOT BE
ARCHITECTURAL AND ENGINEERING DRAWINGS, REPORT ANY DISCREPANCIES TO THE CONSULTANT FOR REVIEW AND RESPONSE. 5. ALL LINES AND DIMENSIONS ARE PARALLEL OR PERPENDICULAR TO THE LINES FROM WHICH THEY ARE MEASURED REFERENCED UNLESS NOTED OTHERWISE. 6. VERIFY ALL DIMENSIONS WITH FIELD CONDITIONS, REPORT ANY DISCREPANCIES TO THE CONSULTANT FOR REVIEW AND RESPONSE. 7. UTILITY AND LIGHTING ARE INDICATED FOR REFERENCE ONLY, REFER TO ENG. DRAWINGS FOR LOCATIONS, DETAILS, AND SPECIFICATIONS. 8. REFER TO ENGINEERING DRAWINGS FOR SUBGRADE, AND REINFORCING OF ALL PAVED SURFACES IN ROADWAYS. 9. THE CONTRACTOR SHALL VERIFY DIMENSIONS SHOWN ON DRAWINGS AND NOTIFY THE LANDSCAPE ARCHITECT OF ANY DISCREPENCIES OR INCONSISTENCIES PRIOR TO CONSTRUCTION. 10. PROVIDE IRRIGATION FOR ALL SOFT LANDSCAPING INCLUDING GROUNDCOVERS, SHRUBS, AND GREENROOF, COULEE RE-ESTABLISHMENT PLANTING AFTER ESTABLISHED SHALL NOT BE IRRIGATED. 11. PROVIDE ADEQUATE SUB-SURFACE DRAINAGE IN ALL PLANTED AREAS. 12. SEE CIVIL AND ARCHITECTURAL DRAWINGS FOR BUILDING PERIMETER		
OTHERWISE. 6. VERIFY ALL DIMENSIONS WITH FIELD CONDITIONS. REPORT ANY DISCREPANCIES TO THE CONSULTANT FOR REVIEW AND RESPONSE. 7. UTILITY AND LIGHTING ARE INDICATED FOR REFERENCE ONLY. REFER TO ENG. DRAWINGS FOR LOCATIONS, DETAILS, AND SPECIFICATIONS. 8. REFER TO ENGINEERING DRAWINGS FOR SUBGRADE, AND REINFORCING OF ALL PAVED SURFACES IN ROADWAYS. 9. THE CONTRACTOR SHALL VERIFY DIMENSIONS SHOWN ON DRAWINGS AND NOTIFY THE LANDSCAPE ARCHITECT OF ANY DISCREPENCIES OR INCONSISTENCIES PRIOR TO CONSTRUCTION. 10. PROVIDE IRRIGATION FOR ALL SOFT LANDSCAPING INCLUDING GROUNDCOVERS, SHRUBS, AND GREENROOF. COULEE RE-ESTABLISHMENT PLANTING AFTER ESTABLISHED SHALL NOT BE IRRIGATED. 11. PROVIDE ADEQUATE SUB-SURFACE DRAINAGE IN ALL PLANTED AREAS. 12. SEE CIVIL AND ARCHITECTURAL DRAWINGS FOR BUILDING PERIMETER		ARCHITECTURAL AND ENGINEERING DRAWINGS. REPORT ANY
7. UTILITY AND LIGHTING ARE INDICATED FOR REFERENCE ONLY. REFER TO ENG. DRAWINGS FOR LOCATIONS, DETAILS, AND SPECIFICATIONS. 8. REFER TO ENGINEERING DRAWINGS FOR SUBGRADE, AND REINFORCING OF ALL PAVED SURFACES IN ROADWAYS. 9. THE CONTRACTOR SHALL VERIFY DIMENSIONS SHOWN ON DRAWINGS AND NOTIFY THE LANDSCAPE ARCHITECT OF ANY DISCREPENCIES OR INCONSISTENCIES PRIOR TO CONSTRUCTION. 10. PROVIDE IRRIGATION FOR ALL SOFT LANDSCAPING INCLUDING GROUNDCOVERS, SHRUBS, AND GREENROOF, COULEE RE-ESTABLISHMENT PLANTING AFTER ESTABLISHED SHALL NOT BE IRRIGATED. 11. PROVIDE ADEQUATE SUB-SURFACE DRAINAGE IN ALL PLANTED AREAS. 12. SEE CIVIL AND ARCHITECTURAL DRAWINGS FOR BUILDING PERIMETER		LINES FROM WHICH THEY ARE MEASURED/ REFERENCED UNLESS NOTED
ENG. DRAWINGS FOR LOCATIONS, DETAILS, AND SPECIFICATIONS. 8. REFER TO ENGINEERING DRAWINGS FOR SUBGRADE, AND REINFORCING OF ALL PAVED SURFACES IN ROADWAYS. 9. THE CONTRACTOR SHALL VERIFY DIMENSIONS SHOWN ON DRAWINGS AND NOTIFY THE LANDSCAPE ARCHITECT OF ANY DISCREPENCIES OR INCONSISTENCIES PRIOR TO CONSTRUCTION. 10. PROVIDE IRRIGATION FOR ALL SOFT LANDSCAPING INCLUDING GROUNDCOVERS, SHRUBS, AND GREENROOF, COULEE RE-ESTABLISHMENT PLANTING AFTER ESTABLISHED SHALL NOT BE IRRIGATED. 11. PROVIDE ADEQUATE SUB-SURFACE DRAINAGE IN ALL PLANTED AREAS. 12. SEE CIVIL AND ARCHITECTURAL DRAWINGS FOR BUILDING PERIMETER		
OF ALL PAVED SURFACES IN ROADWAYS. 9. THE CONTRACTOR SHALL VERIFY DIMENSIONS SHOWN ON DRAWINGS AND NOTIFY THE LANDSCAPE ARCHITECT OF ANY DISCREPENCIES OR INCONSISTENCIES PRIOR TO CONSTRUCTION. 10. PROVIDE IRRIGATION FOR ALL SOFT LANDSCAPING INCLUDING GROUNDCOVERS, SHRUBS, AND GREENROOF, COULEE RE-ESTABLISHMENT PLANTING AFTER ESTABLISHED SHALL NOT BE IRRIGATED. 11. PROVIDE ADEQUATE SUB-SURFACE DRAINAGE IN ALL PLANTED AREAS. 12. SEE CIVIL AND ARCHITECTURAL DRAWINGS FOR BUILDING PERIMETER		
AND NOTIFY THE LANDSCAPE ARCHITECT OF ANY DISCREPENCIES OR INCONSISTENCIES PRIOR TO CONSTRUCTION. 10. PROVIDE IRRIGATION FOR ALL SOFT LANDSCAPING INCLUDING GROUNDCOVERS, SHRUBS, AND GREENROOF. COULEE RE-ESTABLISHMENT PLANTING AFTER ESTABLISHED SHALL NOT BE IRRIGATED. 11. PROVIDE ADEQUATE SUB-SURFACE DRAINAGE IN ALL PLANTED AREAS. 12. SEE CIVIL AND ARCHITECTURAL DRAWINGS FOR BUILDING PERIMETER		
GROUNDCOVERS, SHRUBS, AND GREENROOF. COULEE RE-ESTABLISHMENT PLANTING AFTER ESTABLISHED SHALL NOT BE IRRIGATED. 11. PROVIDE ADEQUATE SUB-SURFACE DRAINAGE IN ALL PLANTED AREAS. 12. SEE CIVIL AND ARCHITECTURAL DRAWINGS FOR BUILDING PERIMETER		AND NOTIFY THE LANDSCAPE ARCHITECT OF ANY DISCREPENCIES OR
12. SEE CIVIL AND ARCHITECTURAL DRAWINGS FOR BUILDING PERIMETER		GROUNDCOVERS, SHRUBS, AND GREENROOF. COULEE RE-ESTABLISHMENT PLANTING AFTER ESTABLISHED SHALL NOT BE
	11.	PROVIDE ADEQUATE SUB-SURFACE DRAINAGE IN ALL PLANTED AREAS.
13. ALL PLANT MATERIAL AND LANDSCAPE CONSTRUCTION TO CONFORM TO AALA STANDARDS.		
14. ENSURE POSITIVE DRAINAGE.		ENSURE POSITIVE DRAINAGE.

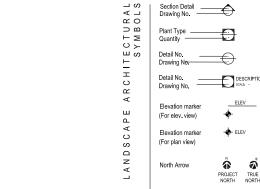



BOROWSKI SAKUMOTO FLIGG MCINTYRE LTD.

VANCOUVER

839 Camble Street, Suite 300 Vancouver BC V6B 2P4 T: 604.683.4131 F: 604.683.9313

VICTORIA

18 Bastion Square Victoria BC V8W 1H9 т: 250,480,7811 F: 250.480.5215

www.merrickarch.com

Revis	sion	
No.	Description	Date
01	Issue for DP	2016-01-14

Issue Date



PLANNING • URBAN DESIGN LANDSCAPE ARCHITECTURE

1777 West 3rd Avenue Vancouver BC V6J 1K7 604.736.5168

Consultant


6409 Bay Street Horseshoe Bay, BC

Westbank

DRAWING INDEX GENERAL INFORMATIONS





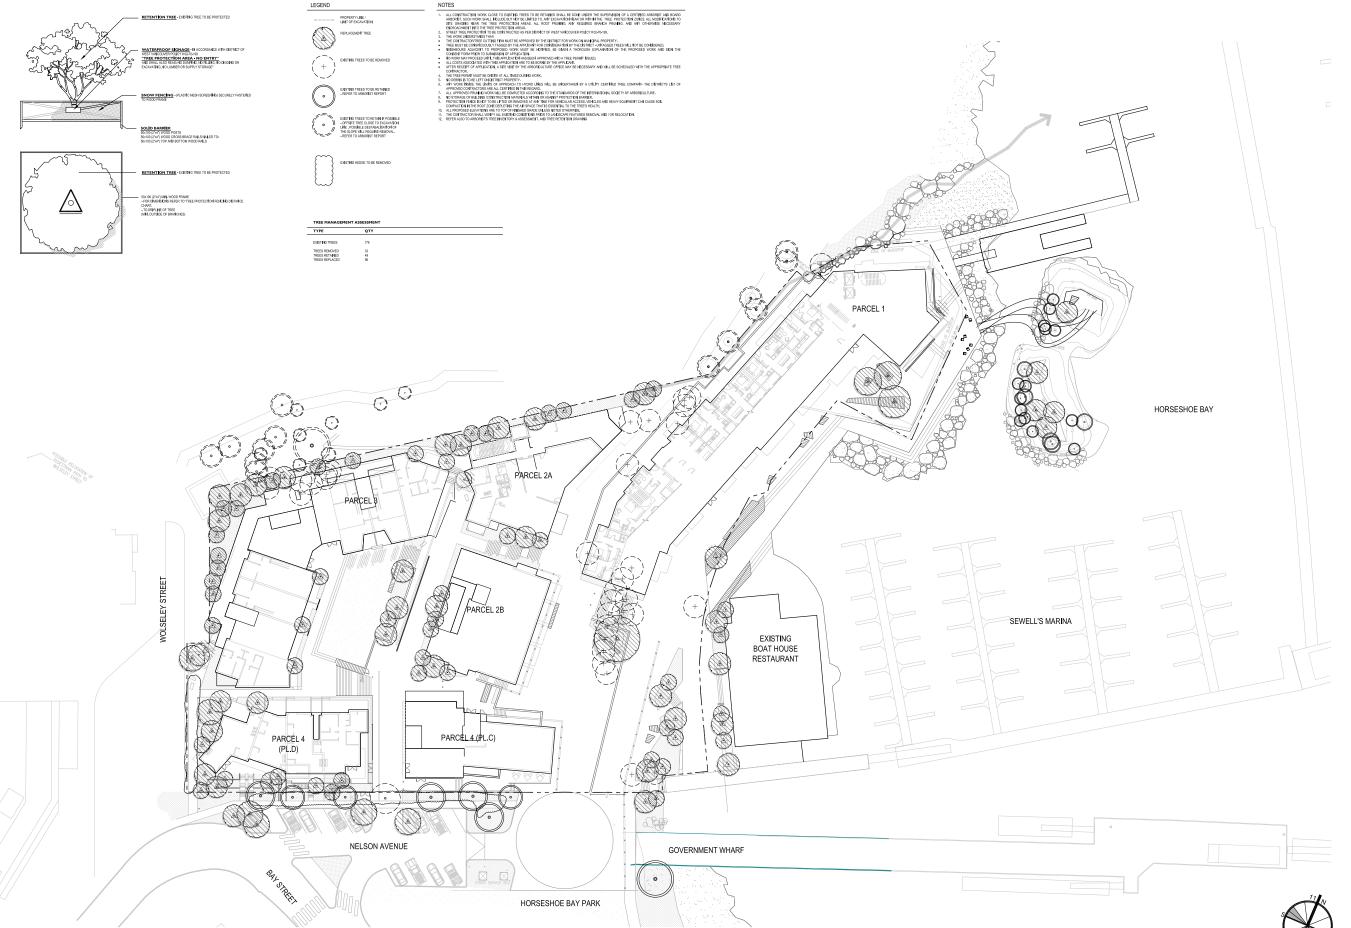

MERRICK ARCHITECTURE

BOROWSKI SAKUMOTO FLIGG MCINTYRE LTD.

VANCOUVER

839 Camble Street, Suite 300 Vancouver BC V6B 2P4 T: 604.683.4131 F: 604.683.9313

VICTORIA

18 Bastion Square Victoria BC V8W 1H9 T: 250.480.7811 F: 250.480.5215

www.merrickarch.com

Revis	ion	
No.	Description	Date
01	Issue for DP	2016-01-14

Issue



PLANNING • URBAN DESIGN LANDSCAPE ARCHITECTURE

1777 West 3rd Avenue Vancouver BC V6J 1K7 604.736.5168

Consultant

Project

6409 Bay Street Horseshoe Bay, BC For Westbank

Sheet Title

TREE MANAGEMENT PLAN

Checked KM
KM
Scale
1/32" =1'-0"
Sheet Number

L1.01

STORMWATER DAYLIGHTING

Rocky stream bed as part of Foreshore
 Enhancement

MADRONA ISLAND

- Foreshore sensitive accessible bridge
- Granular foot path
- Lookout / ceremony space
- Existing planting enhancement
- Seating

WATERFRONT PROMENADE

- Mixed use plaza: Working marina & Public realm amenity
- Multilevel accessible waterfront with mixed seating opportunities
- Bollard / paving band separation for pedestrian protected zone
- Mixed paving materials: Stone & wood Native & adaptive ornamental planting
- Enhanced foreshore and connection to Madrona Island
- 'End of trip' bike facility & non-motorized boat storage and launch
- Continuation of Horseshoe Bay Park walk
- Enhance Existing Boathouse Restaurant planting and patio

LOWER RESIDENTIAL PLAZA

- Vehicular / pedestrian shared plaza
- Connection to existing hiking path
- Bollard / paving band separation for pedestrian protected zone
- Access to P1 parking garage
- Native & adaptive ornamental planting

UPPER RESIDENTIAL PLAZA

- Amenity Lawn and wood patio deck.
- Stone surfacing and seating stepsOrnamental planting
- Stone stair and wood stair access to lower residential plaza
- Private Patios facing onto amenity space
- Accessible path from Nelson Ave to Lobby entry

COMMERCIAL PLAZA

- Vehicular / pedestrian shared plaza
- Stone surfacing
- Bollard / paving band separation for pedestrian protected zone
- Feature Tree and ornamental planting
- Stone stair to waterfront promenadeAccess to P2 parking garage

NELSON STREET

- Extend Nelson sidewalk To the approval of the District of West Vancouver
- Enhance turnabout by creating a node in the park connection / water front promenade
- Preserve existing street trees
- Enhance boulevard planting Species to the approval of the District of West Vancouver
- Terraced townhouse access

PARK CONNECTION

- Connect waterfront promenade to existing Horseshoe Bay Park walk
- Preserved cherry trees





MERRICK ARCHITECTURE

BOROWSKI SAKUMOTO FLIGG MCINTYRE LTD.

VANCOUVER

839 Cambie Street, Suite 300 Vancouver BC V6B 2P4 T: 604.683.4131 F: 604.683.9313

VICTORIA

18 Bastion Square Victoria BC V8W 1H9 T: 250.480.7811 F: 250.480.5215

www.merrickarch.com

Revision		
No.	Description	Date
01	Issue for DP	2016-01-14

Issue Date



PLANNING • URBAN DESIGN LANDSCAPE ARCHITECTURE

1777 West 3rd Avenue Vancouver BC V6J 1K7 604.736.5168

Consultant

Project


6409 Bay Street Horseshoe Bay, BC For Westbank

Sheet Title

RENDER SITE PLAN

Drawn By	Checked
MH / MP	KM
Project Number	Scale
15014	1/32" = 1'-0"
Revision	Sheet Number

L1.00

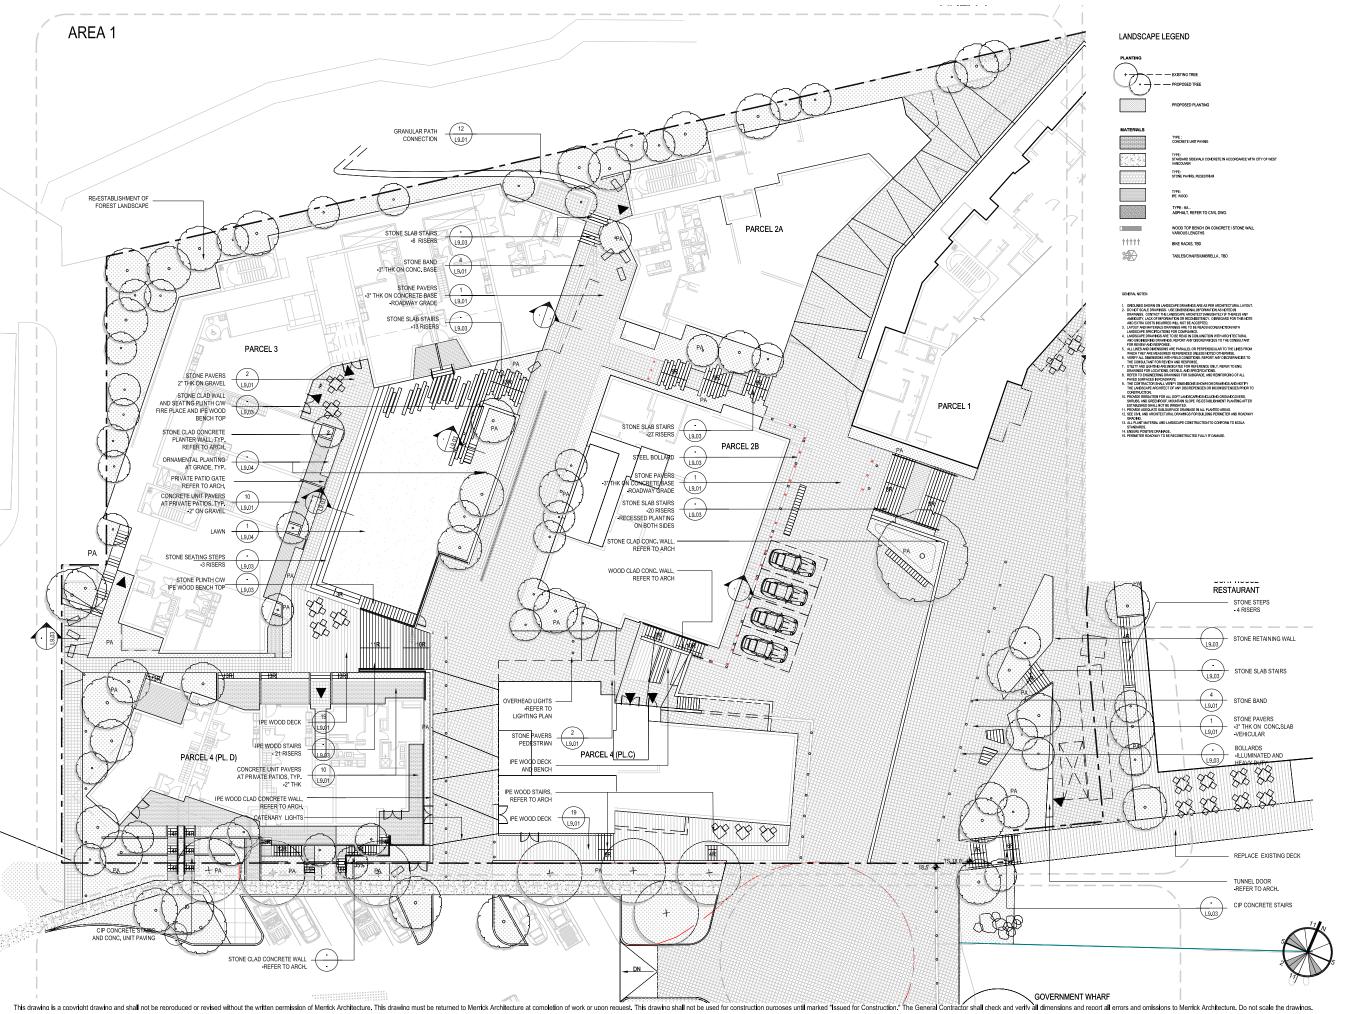

MERRICK ARCHITECTURE

BOROWSKI SAKUMOTO FLIGG MCINTYRE LTD.

VANCOUVER

839 Camble Street, Suite 300 Vancouver BC V6B 2P4 T: 604.683.4131 F: 604.683.9313

VICTORIA

18 Bastion Square Victoria BC V8W 1H9 T: 250.480.7811 F: 250.480.5215

www.merrickarch.com

Revis	sion	
No.	Description	Date
01	Issue for DP	2016-01-1

ue Issue D



PES STUDIO
PLANNING • URBAN DESIGN
LANDSCAPE ARCHITECTURE

1777 West 3rd Avenue Vancouver BC V6J 1K7 604.736.5168

Consultant

Project


6409 Bay Street Horseshoe Bay, BC For Westbank

Sheet Title

MATERIAL PLAN AREA 1

Drawn By	Checked
MH / MP	KM
Project Number	Scale
15014	1/16" = 1'-0"
Revision	Sheet Number

L2.0

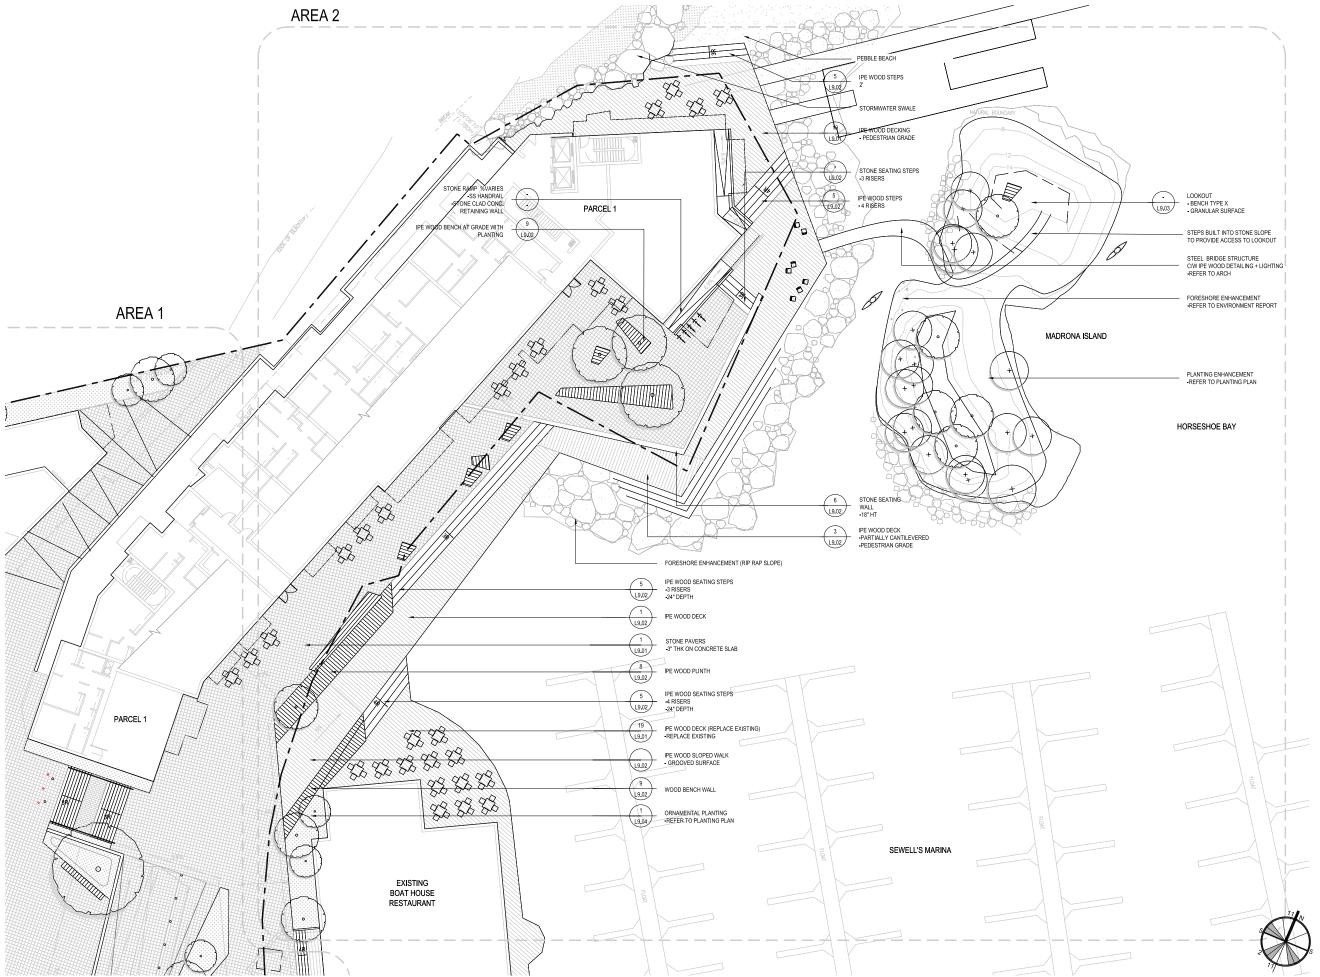

MERRICK ARCHITECTURE

BOROWSKI SAKUMOTO FLIGG MCINTYRE LTD.

VANCOUVER

839 Camble Street, Suite 300 Vancouver BC V6B 2P4 T: 604.683.4131 F: 604.683.9313

VICTORIA

18 Bastion Square Victoria BC V8W 1H9 T: 250.480.7811 F: 250.480.5215

www.merrickarch.com

Revision		
No.	Description	Date
01	Issue for DP	2016-01-14

Issue Date



PLANNING • URBAN DESIGN LANDSCAPE ARCHITECTURE

1777 West 3rd Avenue

Vancouver BC V6J 1K7 604.736.5168

Consultant

Projec

6409 Bay Street Horseshoe Bay, BC For Westbank


Sheet Ti


MATERIAL PLAN AREA 2

Drawn By	Checked
MH / MP	KM
Project Number	Scale
15014	1/16" = 1'-0"
Revision	Sheet Number

L2.02

LANDSCAPE LEGEND

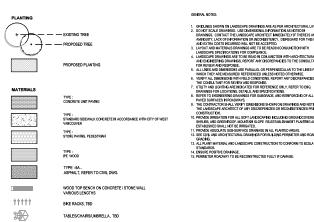

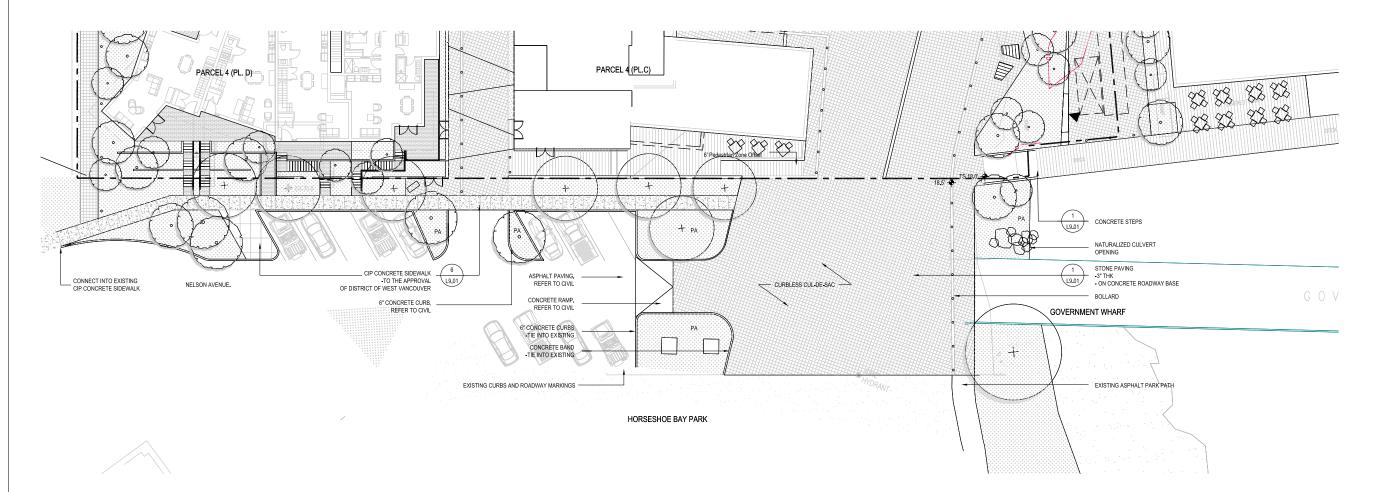



MERRICK ARCHITECTURE

BOROWSKI SAKUMOTO FLIGG MCINTYRE LTD.

VANCOUVER

839 Camble Street, Suite 300 Vancouver BC V6B 2P4 T: 604.683.4131 F: 604.683.9313

VICTORIA

18 Bastion Square Victoria BC V8W 1H9 T: 250.480.7811 F: 250.480.5215

www.merrickarch.com

Revis	ion	
No.	Description	Date
01	Issue for DP	2016-01-14

sue Issue Date



PLANNING • URBAN DESIGN LANDSCAPE ARCHITECTURE

1777 West 3rd Avenue Vancouver BC V6J 1K7 604.736.5168

Consultant

Proj


6409 Bay Street Horseshoe Bay, BC For Westbank

Sheet Ti

MATERIAL PLAN NELSON STREET

Drawn By	Checked
MH / MP	KM
Project Number	Scale
15014	1/16" = 1'-0"
Revision	Sheet Number

L2.03

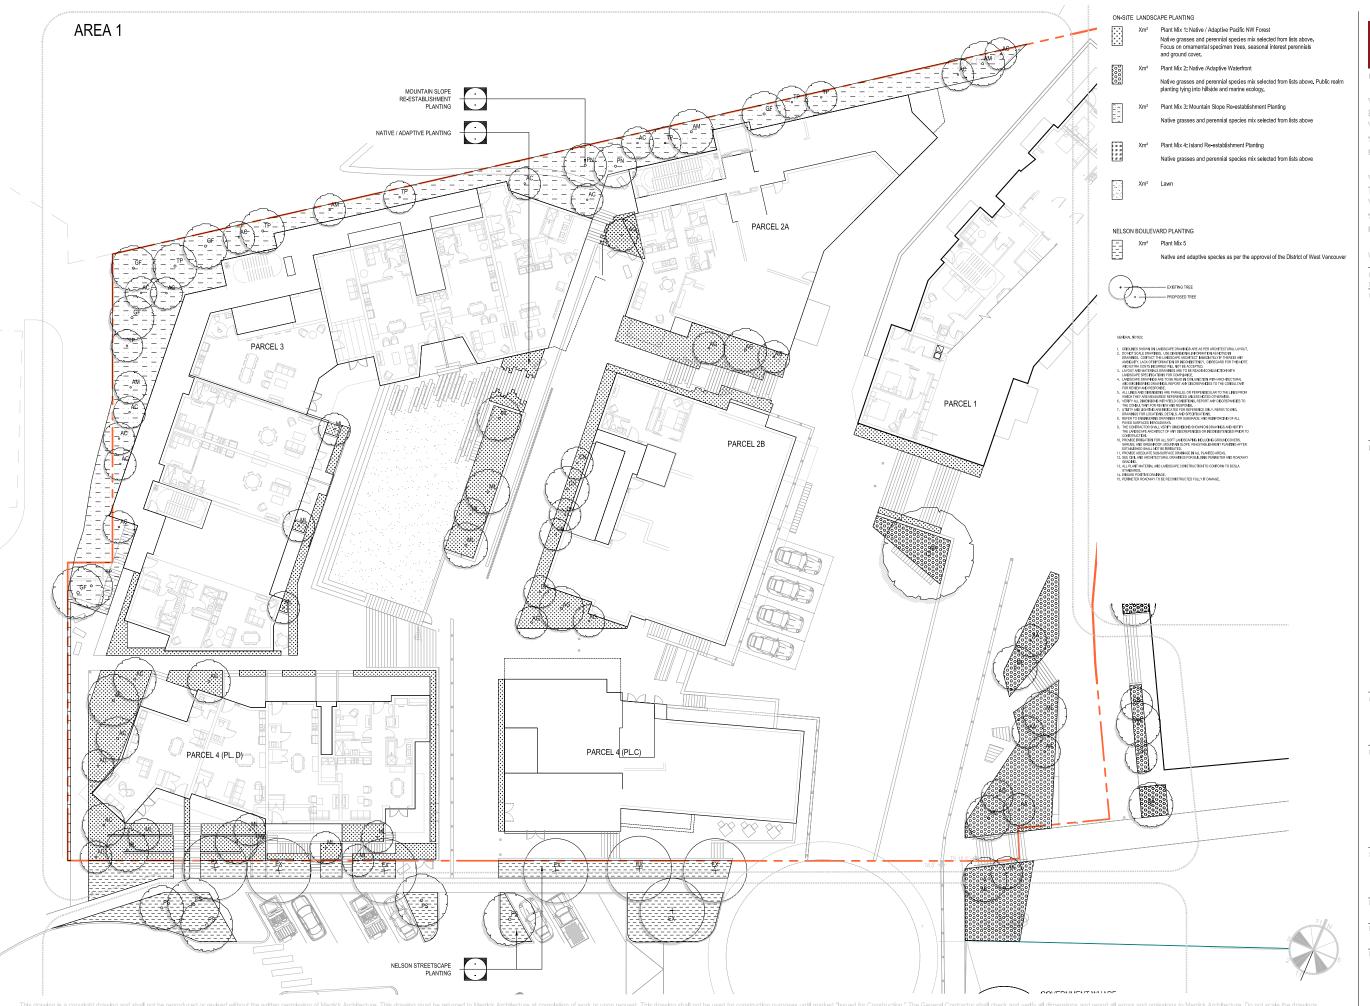



BOROWSKI SAKUMOTO FLIGG MCINTYRE LTD.

VANCOUVER

839 Cambie Street, Suite 300 Vancouver BC V6B 2P4 T: 604.683.4131 F: 604.683.9313

VICTORIA

18 Bastion Square Victoria BC V8W 1H9 T: 250.480.7811 F: 250.480.5215

www.merrickarch.com

Revis	IOH	
No.	Description	

Jeeua Date



PLANNING • URBAN DESIGN LANDSCAPE ARCHITECTURE

1777 West 3rd Avenue Vancouver BC V6J 1K7 604.736.5168

Consultant

roject

6409 Bay Street orseshoe Bay, BC For Westbank

PLANTING PLAN AREA 1

Drawn By	Checked
MH / MP	KM
Project Number	Scale
15014	1/16" = 1'-0"
Revision	Sheet Number

L4.01