## **AQUILA**

## **ISSUED FOR DEVELOPMENT PERMIT**

## STERLING PACIFIC // CLIENT

DAVE HARPER

JAMIE HARPER harps.jamie@gmail.com 778.322.9340

## FORMWERKS // ARCHITECT

ANDREW COOK andrew@formwerks.ca 604.683.5441

## LOCI LANDSCAPE ARCHITECTURE + URBAN DESIGN // LANDSCAPE ARCHITECT

MICHAEL ENNS // BCSLA, CSLA mike@locidesign.ca 604.763.2886

CHLOE BROWN chloe@locidesign.ca 519.288.1153

## LANDSCAPE DRAWING INDEX PERMIT

Sheet No.	Sheet Name
L0.0	COVER SHEET
L0.1	TREE PROTECTION
L1.0	OVERALL LANDSCAPE PLAN
L1.1	LAYOUT + MATERIALS PLAN
L1.2	GRADING PLAN
L1.3	PLANTING SCHEMATIC PLAN
L2.0	PLAYGROUND - MATERIALS
L3.0	PLANT LIST + IMAGES
L4.0	HARDSCAPE DETAILS
L4.1	HARDSCAPE DETAILS
L4.2	FURNISHING DETAILS
L4.3	PLAYGROUND DETAILS
L4.4	SOFTSCAPE DETAILS

## **GENERAL NOTES**

- 1. ALL PLANTING SHALL BE IN ACCORDANCE WITH BC LANDSCAPE STANDARD, LATEST EDITION.
- 2. ALL PLANTING AREAS TO RECEIVE AUTOMATIC DRIP IRRIGATION, WITH TIME CLOCK AND RAIN SENSOR
- 3. ALL LANDSCAPE ARCHITECTURAL DRAWINGS IN THIS PACKAGE SHALL BE READ IN CONJUNCTION WITH ALL OTHER CONSULTANT DRAWINGS, DETAILS, SPECIFICATIONS, AND ANY OTHER CORRESPONDENCE THAT MAY BE ISSUED DURING THE COURSE OF THE CONTRACT.
- 4. IF A DISCREPANCY OCCURS BETWEEN THE DRAWINGS AND THE SPECIFICATIONS OR ANY OTHER DOCUMENT ASSOCIATED WITH THE PROJECT, THE CONFLICT SHALL BE REPORTED IN WRITING TO THE LANDSCAPE ARCHITECT TO OBTAIN CLARIFICATION AND APPROVAL BEFORE PROCEEDING
- 5. ALL EXISTING INFORMATION IS BASED ON AVAILABLE RECORDS AND SHALL NOT BE CONSTRUED TO BE COMPLETE OR ACCURATE.
- 6. THE CONTRACTOR SHALL VISIT THE SITE TO VERIEV THE TRUE EXISTING CONDITIONS ANY LINCLEAR ISSUES SHALL BE CLARIFIED WITH THE CONSULTANT TEAM. NO CLAIM SHALL BE ALLOWED FOR EXTRAS WHICH MAY ARISE THROUGH NEGLECT OF THIS ADVICE.
- 7. THE CONTRACTOR IS RESPONSIBLE FOR DETERMINING THE EXISTENCE. LOCATION, AND ELEVATION OF ALL UTILITIES AND CONCEALED STRUCTURES, AND IS RESPONSIBLE FOR NOTIFYING THE APPROPRIATE COMPANY, DEPARTMENT OR PERSON(S) OF ITS INTENTION TO CARRY OUT ITS OPERATIONS.
- 8. LAYOUT OF PAVING, WALLS, SITE FURNITURE, SOIL, PLANTING, AND ALL OTHER LANDSCAPE MATERIALS IS TO BE STAKED OUT AND APPROVED BY THE LANDSCAPE ARCHITECT PRIOR TO INSTALLATION.
- 9. ALL DIMENSIONS AND ELEVATIONS ARE IN FEET UNLESS OTHERWISE NOTED. VERIFY ALL ELEVATIONS WITH FIELD CONDITIONS. REPORT ANY DISCREPANCIES TO CONSULTANT TEAM FOR REVIEW AND RESPONSE.
- 10. ALL UTILITIES TO BE STAKED OUT BY CONTRACTOR AND PROTECTED FOR DURATION OF CONSTRUCTION PERIOD.
- 11. PROTECT ALL EXISTING STRUCTURES
- 12. ALL SUBSTITUTIONS OF SPECIFIED MATERIALS TO BE APPROVED BY LANDSCAPE ARCHITECT.
- 13. FINAL PLANT SPACING, QUANTITY AND TREE PLACEMENT HAS BEEN REVIEWED TO THE SATISFACTION OF GENERAL MANAGER OF ENGINEERING SERVICES.
- 14. ALL WORKS ON CITY OF VANCOUVER PROPERTY TO BE AS PER THE CITY OF VANCOUVER STREET RESTORATION MANUAL.
- 15. LOCI LANDSCAPE ARCHITECTURE + URBAN DESIGN DOES NOT GUARANTEE THE EXISTENCE, LOCATION, AND ELEVATION OF UTILITIES OR CONCEALED STRUCTURES AT THE PROJECT SITE



Project Stamp



No.	Description	
С	ISSUED FOR DP DRAFT	21-0
D	RE-ISSUED FOR DP DRAFT	21-1
Ε	ISSUED FOR REVIEW	21-
F	ISSUED FOR DP	21-1

21056

Aquila West Vancouver

COVER SHEET

L0.0

# GENERAL TREE PROTECTION FENCING TYP NOTES:

- COMPONENTS AND WORKMANSHIP TO CONFORM TO BCLNANDARDS TYPICAL
- POSITION TREE STAKES INTO DIRECTION OF PREVAILING WINDS IF MINIMUM UTILITY SETBACKS PERMIT.
- TREE STAKES TO HAVE A MINIMUM 10m CLEARANCE FROM ALL U/G VER TELEPHONE AND GAS ALIGNMENTS.
- ALL ROOTBALL HOLES TO BE DUG BY HAND WHEN CLOSER TO 1.0M (40') TO U/G POWER, TELEPHONE AND GAS ALIGNMENTS. FOR TREES WITH DRIPLINES FROM FROM 3M 5M (9' 15') FROM CONSTRUCTION ACTIVITY;
- PLACE STANDARD 'SAFETY ORANGE SNOWFENCE MIN. OF 45M (14'8') FROM TREE TRUNK. BXACT SIZE/SHAPE TO BE DETERMINED ON SITE excavation within 1-3m (3" - 9) of any trees dripline, root ning required to a depth of 500mm (20"), immediately after wation, prune all exposed roots flush with the excavation
- A MAXIMUM OF 25% OF ANY TREES ROOTS AT THE DRIPLINE SHOULD BE MPACTED BY EXCAVATION IF THE TREE IS EXPECTED TO SURVIVE.
- INSTALL AND MAINTAIN HOARDING IN CLEAN AND SAFE CONDITION THROUGHOUT CONSTRUCTION PROCESS.
- HOARDING REQUIREMENTS ARE ON ALL EXISTING TREES THROUGHOUT CONSTRUCTION, ALL EQUIPMENT, SOIL, BUILDING MATERIAL AND OTHER DEBRIS SHALL BE KEPT OUTSIDE THE HOARDING. RDING IS PUNCTURED AND DAMAGE OCCURS TO HOARDED TREEKS). \* LANDSCAPE ARCHITECT.
- THE BEST METHOD TO AVOID SOIL COMPACTION IS TO KEEP OFF. THIS INCLUDES RETRICITING ALL TRAFFIC BOTH VEHICULAR AND PEDESTRIAN FROM CROSSING, OVER THE ROOT ZONES, AND RESTRICTING EVEN TEMPORARY MATERIAL STORAGE UNDER TREES.
- AWATION AROUND TREES WITHIN DRIP LINE OF TREES ONLY WHERE WEATED ON PLANS AND AS DIRECTED BY THE CONSULTANT. ANY EXCAVATION WITHIN THE DRIP LINE OF A TREE THE CITOR SHALL EXCAVATE AROUND TREE ROOTS AS DIRECTED BY THE TANT. DO NOT CUT TREE ROOTS UNLESS DIRECTED BY THE TANT.
- TREES AND OTHER DESIRABLE VEGETATION TO BE TOTALLY FENCED. FENCING TO BE MAINTAINED FOR THE DURATION OF THE PROJECT. EXCAVATION FOR NEW CONSTRUCTION WITHIN THE DRIP LINES OF TREES: HAND EXCAVATE TO MINIMIZE DAMAGE TO ROOT SYSTEMS
- VARROW TINE SPADING FORKS TO PROBE AND COMB SOIL TO EXPOSE
- UTILITY TRENCHING WITHIN THE DRIP LINES OF TREES: TUNNEL UNDER AND AROUND ROOTS BY HAND DIGGING:
- UTTING OF SMALLER ROOTS THAT INTERFERE WITH INSTALLATION OF NEW ORK SHALL BE DONE WITH CLEAN SHARP TREE PRUNING TOOLS; IS THAT ARE ENCOUNTERED IMMEDIATELY ADJACENT TO THE TONG OF NEW CONSTRUCTION AND ARE TOO DIFFICULT TO RELOCATE LBE CUIT 150MM (6') BACK FROM NEW CONSTRUCTION. USE CLEAN PIREE PRUNING TOOLS.
- TECTION OF EXPOSED ROOTS: DO NOT ALLOW EXPOSED ROOTS TO OUT PRIOR TO PLACEMENT OF PERMANENT COVER.
- ZA A PROVIDE TEMPORARY EARTH COVER, MANITAIN MOISTURE.

  B PACK WITH WET PEAT MOSS, MANITAIN MOISTURE.

  C. PACK WITH FOUR LAYERS OF WET UNTREATED BURLAP, MAINTAIN MOISTURE. 3. PROVIDE ONE OF THE FOLLOWING TEMPORARY REMEDIAL MEASURES:
- STEMPORARILY SUPPORT AND PROTECT EXPOSED ROOTS FROM DAMAGE UNTIL PERMANENTLY RELOCATED AND COVERED WITH BACKFILL
- REMOVAL OF STREET TREES TO THE SATISFACTION OF THE GENERAL MANAGER OF ENGINEERING SERVICES. WATER PUDDLE BACKFILL AROUND ROOTS TO ELIMINATE VOIDS AND AIR
- 3. THIS PLAN SHOWS ALL IDENTIFIED TREES OUTSIDE OF THE WETLAND AREA AS DEFINED IN THE DISTRICT OF WEST VANCOUVER TREE BYLAW NO. 4892, 2016"

## TREE MANAGEMENT PLAN

 $(\cdot)$ 

XISTING PERMIT-RATED TREE TO BE RETAINED -HEMOCK, CEDAR AND FIR Refer to Arborist Report

TREE PROTECTION PLAN
Scale: 1:350

0.1 TREE PROTECTION

Checked By Checked





Dote 21-06-07 21-07-02 21-07-13 21-07-23

## DESIGN RATIONALE:

The overall landscape design for the site is inspired by the natural west coast setting it sits on, with existing forest stands along the perimeter and selected groupings within the residential areas augmented by new understorey native trees, shrubs and boulder groupings. Accent plantings of ornamental grasses, perennials and small trees provide colour and texture for variety and seasonal interest, placed at unit entries as well as at site entries and adjacent to paths. Retaining walls will be a mixture of boulder stacks, placed strategically to allow for pocket planting, and architectural concrete walls at entries to the units as required. Collectively, the materiality is aimed to promote a landscape experience that allows the residents to feel this development is part of the site's history.

From a site amenity perspective, the crown jewel for the neighbourhood is the proposed Eagle Creek Park, a linear park along the existing Eagle Creek that is comprised of a meandering pathway, a new playground, resting benches, and naturalized plantings. This public amenity will connect lower Daffodil Drive with Westport Road, and provide an easy-to-access natural and recreational addition to the community. To the west, the reclaimed watercourse and wetland area is "opened up" for residents, with a small path and viewing deck proposed along the main entry road. Site circulation is further enhanced with gravel pathways that connect the upper and lower benches of the site.

## KEY ITEMS:

- 1 SITE ENTRIES
  - -Feature wall, possible arch feature -"Aquila brand"
- -Accent paving
- DRIVE COURT
  - -Accent paving bands -Ornamental trees -Layered native plants
- COMMON MEETING/REST AREA
  -Unit pavers/gravel
  - -Benches -Accent planting
- 4 RECLAIMED/REHABILITATED WATERCOURSE + WETLANDS
  -Native shrubs + trees
  -Viewing deck + bench
- 5 EAGLE PARK + PLAYGROUND
  -Community trail along historic skid trail
  -Adventure/naturalized playground
- CLUSTERS OF PROTECTED NATIVE TREES + UNDERSTOREY











# GENERAL LAYOUT + MATERIALS NOTES

- 1. ALL DIMENSIONS ARE METRIC UNLESS OTHERWISE NOTED, VERIFY ALL DIMENSIONS WITH FIELD CONDITIONS, REPORT ANY DISCREPANCIES TO LANDSCAPE ARCHITECT FOR REVIEW AND RESPONSE.
- 3. UNLESS OTHERWISE NOTED, PROVIDE A MINIMUM 2% SLOPE ON ALL HARD AND SOFT LANDSCAPE, AREAS TO ENSURE POSITIVE DRAINIGE AWAY FROM BULIDINGS OR TO DRAINIGE STRUCTURES. MAXIMUM 3.1 SLOPE IN SOFT LANDSCAPE AREAS. 2. ALL UTILITIES TO BE STAKED OUT BY CONTRACTOR AND PROTECTED FOR DURATION OF CONSTRUCTION PERIOD.
- 4. THE LAYOUT OF ALL HARDSCAPE ITEMS, SITE FURNISHINGS, BOULDERS, LANDSCAPE LICHTING, PLANTING BEDS AND OTHER MATERIALS IS TO BE STAKED OUT BY THE CONTRACTOR AND APPROVED BY THE LANDSCAPE ARCHITECT PRIOR TO INSTALLATION.
- 5. ALL SUBSTITUTIONS OF SPECIFIED MATERIALS TO BE APPROVED BY LANDSCAPE ARCHITECT.

SYMBOL

KEY DESCRIPTION


PS PAVING TYPE 5
Gravel Surfacing, TYP.

Ę

STEPPING LOGS

STONE SLAB STEPS

STEPPING ROCKS CLIMBING BOULDER

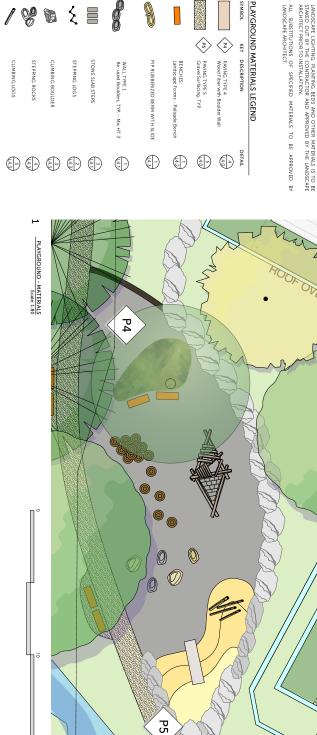



Na Description
C ISSUED FOR DPDRAFT
D RE-BSUED FOR DPDRAFT
E ISSUED FOR RE/IEW
F ISSUED FOR DP Done 21-06-07 21-07-02 21-07-13 21-07-23

Aquila West Vancouver Schemalic West Yancouver

MATERIALS L2.0

# PRELIMINARY PLANT SCHEDULE

## RIPERIAN PLANTING:

TREES:				
Latin Name	Common Name	Scheduled Size	Spacing	Notes
Acer circinatum	Vine Maple	5cm cal.	20 - 35 ft.	B&B Specimen, Multistem
Betula papyrifera	Paper Birch	7cm cal.	20 - 35 ft	B&B Specimen, Multistem.
Pinus monticola	Western White Pine	3m. ht.	20 - 35 ft	B&B Specimen
SHRUBS:				
Cornus alba 'Ivory Halo'	Ivory Halo(R) Dogwood	#5 Pot	<= 12 in	
Cornus stolonifera	Red Twig Dogwood	#3 Pot	36 in 4 ft.	
Salix lucida	Pacific Willow	6cm cal.	7 - 12 ft	B&B Specimen
Vaccinium quatum	Evergreen Huckleberry	#2 Do+	4-7 ft.	

## ₹

	Vaccinium ovatum	Evergreen Huckleberry	#3 Pot	4-7 ft.	
	PERENNIALS, GRASSES, GROUNDCOVER:	COVER:			
ATIVE	ATIVE PLANTING:				
	TREES:				
	Acer macrophyllum	Big Leaf Maple	8cm cal.	20 - 35 ft.	B&B Specimen, Multistem
	Cercidiphyllum japonicum	Katsura Tree	6cm cal.	20 - 35 ft.	B&B Specimen
	Populus tremuloides	Trembling Aspen	5cm cal.	12 - 20 ft	B&B Specimen
	Pseudotsuga menziesii	Douglas Fir	3-5m. ht.	12 - 20 ft	8&B
	Thuja plica ta	Western Red Cedar	3-5m. ht.	12 - 20 ft	B&B
	SHRUBS:				
	Gaultheria shallon	Salal	#1 Pot	12 - 24 in	
	Pieris japonica 'Forest Flame'	Lily-of-the-Valley Shrub	#5 Pot	4 - 7 ft	
	Vaccinium ovatum	Evergreen Huckleberry	#3 Pot	4-7 ft.	
	PERENNIALS, GRASSES, GROUNDCOVER:	COVER:			
	Arctostaphylos uva-ursi	Bearberry, Kinnikinick	#1 Pot	24 - 36 in	
	Blechnumspicant	Deer Fern	#2 Pot	12 - 24 in.	
	Carex densa	Dense Sedge	#2 pot	24 - 36 ft.	
	Dicentra formosa	Pacific Bleeding Heart	#1 Pot		
	Fragaria chiloensis	Coastal Strawberry	#1 Pot	12 - 24 in	
	Helictotrichon sempervirens	Blue Oat Grass	#2 pot	24 - 36 ft.	
	Polystichum munitum	Western sword fern	#3 Pot		

## ORNAMENTAL PLANTING:

1	A CONTRACT OF THE PARTY OF THE				
	TREES:				
	Fraxinus 'Autumn applause'	White Ash	8cm cal.	20 - 35 ft	B&B Specimen
	Quercus coccinea	Scarlet Oak	8cm cal.	20 - 35 ft	B&B Specimen
	Magnolia 'Galaxy'	Galaxy Magnolia	5cm cal.	7 - 12 ft	B&B Specimen
	Corrus nuttallii ' Eddie's White Wonder' Eddie's Pacific Dogwood	er' Eddie's Pacific Dogwood	6cm cal.	12 - 20 ft	B&B Specimen
	SHRUBS:				
	Calluna vulgaris	Scotch Heather	#2 Pot	12 - 24 in	
	Pinus mugo pumilio	Dwarf Mugo Pine	#2 Pot	24"	
	Rosa nutkana	Nootka Rose	#5 Pot	48 in.	
	Spiraea japonica 'Goldflame'	Goldfame Japanese Spirea	#3 Pot	36"	
	PERENNIALS, GRASSES, GROUNDCOVER:	COVER:			
	Calamagrostis x acutiflora 'Karl Foerster' Foerster's Feather Reed Grass	ter' Foerster's Feather Reed Grass	#2 pot	12 - 24 in.	
	Echinacea purpurea	Purple Coneflower	#1 Pot	4-7 ft	
	Hemerocallis x 'Stella de Oro'	Daylily	#1 Pot	12 - 24 in.	
	Lavandula angustifolia 'Hidcote'	Hidcote Lavender	#2 Pot	12 - 24 in	
	Stipa tenuissima	Mexican Feather Grass	#3 pot	12 - 24 in	
	Rudbeckia fulgida 'Goldsturm'	Black-Eyed Susan	#2 Pot	12 - 24 in.	

ORNAMENTAL PLANTING:

Carex densa Dense Sedge

## PLANT IMAGES RIPERIAN PLANTING:























Salix lucida
Pacific Willow





NATIVE PLANTING:

Comus stolonifera Red Twig Dogwood







































21-06-07 21-07-02 21-07-13 21-07-23



Helictotrichon se Blue Oat Grass

 Project Team	City	West fancouver	Schematic	Aquila West Vancouver


Landscape Architect	Architect Formwerks	Sterling Pacific


Drawn By	Drawn By	
_	Q	
Checked	hecked By	





Stipa tenuissima Mexican Feather Grass

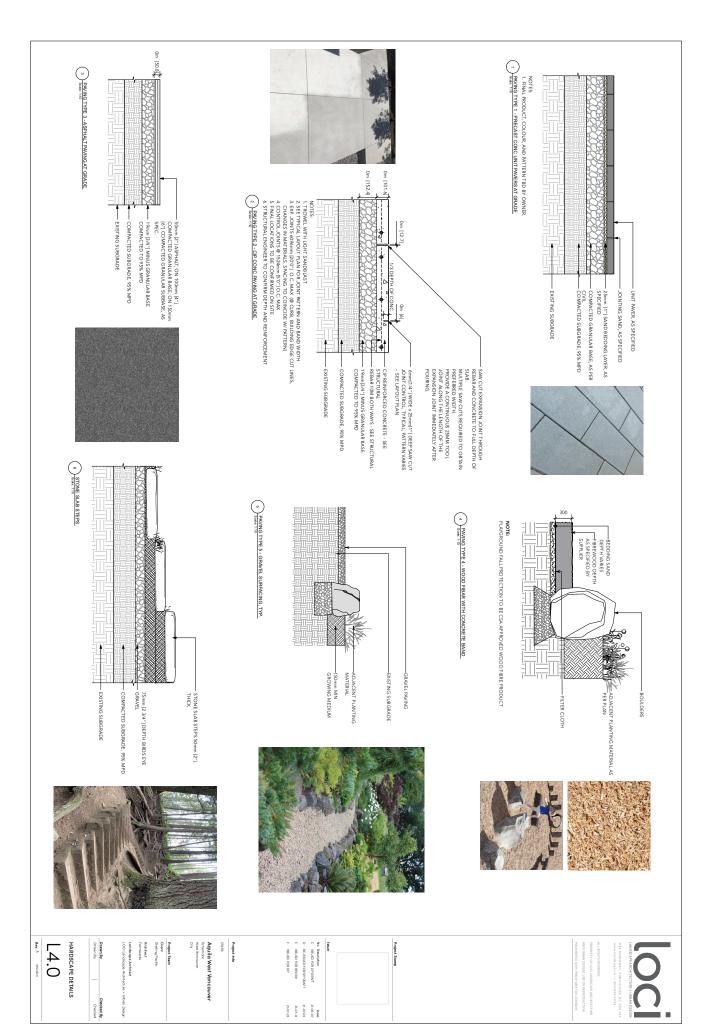


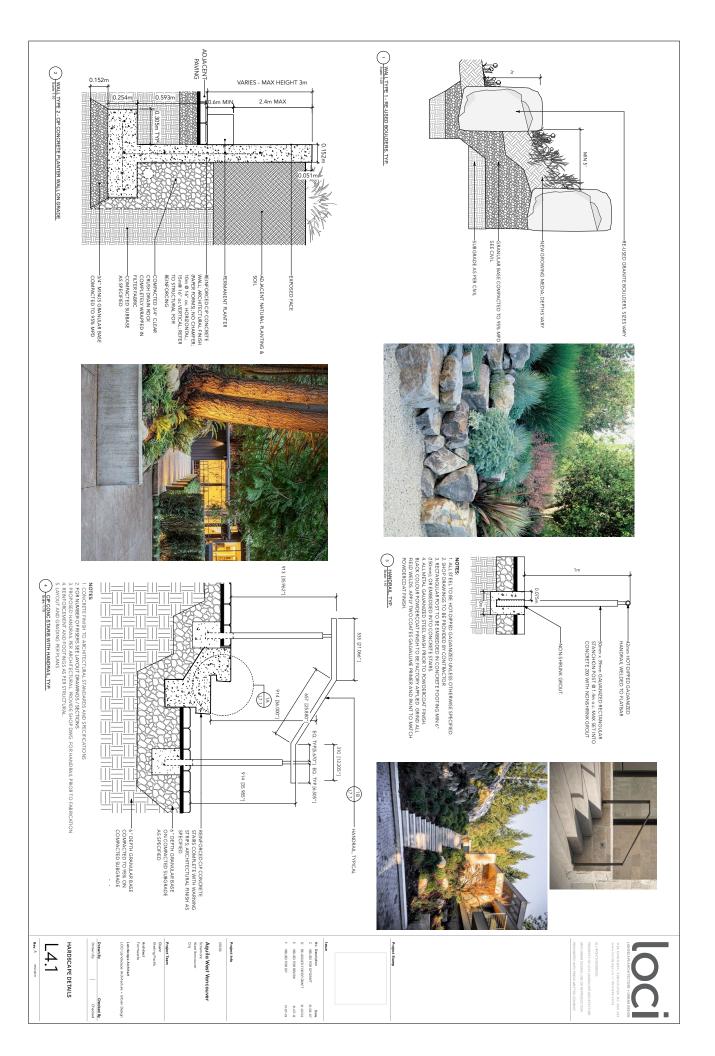








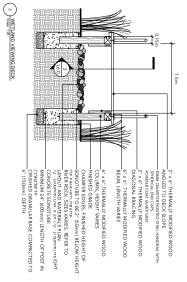



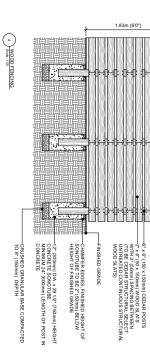

3 UNIT PILASTERS Soile NTS





Drawn By	Drawn By	LOCI Landscape Architecture + Urban Design	Landscape Architect	Formwerks	Sterling Pocific	Client	Project Team	CIN
_		erchitecture	8					
Checked	Checked By	+ Urban Design						

ᇎ	
SIN	
Ĭ	
DE S	
Ĭ	
S	


L4.2

No Descript
C ISSUED
D RE-BSUE
E ISSUED
F ISSUED


plion	Date
D FOR DP DRAFT	21-06-07
SUED FOR DR DRAFT	21-07-02
D FOR REVIEW	21-07-13
D FOR DP	21-07-23

-GALVANIZED WOOD SCREWS




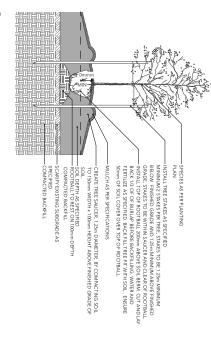


## DECIDUOUS TREE ON GRADE TYP. Scale: 125

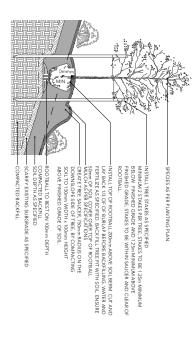


## 2 DECIDUOUS TREE ON SLOPE TYP. Soale 1:25

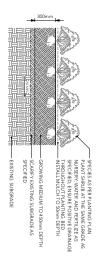

3 SHRUB PLANTING ON GRADE TYP.
3 Scille: 125

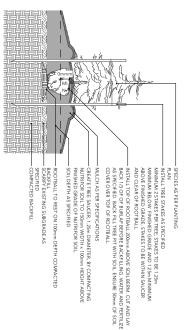

## CONIFEROUS TREE ON GRADE TYP.

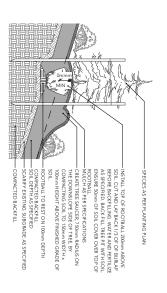


No Description
C ISSUED FOR DEDRAFT
D RE-BSUED FOR REVIEW
E ISSUED FOR REVIEW
F ISSUED FOR DE

Done 21-06-07 21-07-02 21-07-13

Aquila West Vancouver Schemalic West Yancouver

## 5 CONIFEROUS TREE ON SLOPE TYP. 5 Scale: 125

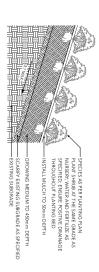

6 SHRUB PLANTING ON SLOPE TYP.



SOFTSCAPE DETAILS

L4.4

Checked By Checked