DEVELOPMENT APPLICATION INFORMATION MEETING





MEETING DATE	April 18, 2024
MEETING TIME	6 PM - 8 PM
MEETING LOCATION	West Vancouver Recreation Center, Cedar Room

The applicant, Feenstra Architecture Inc. and the property owners will conduct the Public Information Meeting.

A representative of the District of West Vancouver Planning Department will also attend and be available to respond to questions on policy and process.

TOPIC 2368 BELLEVUE AVENUE The owners of 2368 Bellevue are applying for a Development Permit with proposed zoning variances to construct a new house on this property.

FORMAT An Open House and Informal Presentation will held on April 18, 2024. At the meeting, we will be available to answer your questions and listen to your comments.

The meeting is being held by the applicant to inform neighbours of the project prior to West Vancouver Council considering approval of the Development Permit with Variances 23-079.

FOR MORE INFORMATION

Feenstra Archtecture Inc / Ted Feenstra / 604 739-8888 / ted@feenstra.ca Proposed plans may be viewed using the following link: https://drive.google.com/file/d/1-WexFpaho-OQ9v19FC3SSv_x8yQGm9kF/view?usp=sharing

CONTACT To ask questions and/or submit public feedback on the proposal, please contact: Ted Feenstra at 604 739-8888 / ted@feenstra.ca

> To ask questions or provided comments to the District , please contact the file planner: Hanna Demyk, at hdemyk@westvancouver.ca or 604 913-2750

2368 Bellevue Proposal Summary

The Owners of 2368 Bellevue are applying for Development Permits to construct a new house

Two (2) Development Permits are required for this project: Ambleside Apartment Area Development Permit and Foreshore Development Permit


The house will include one (1) habitable floor above the Flood Construction Level and one (1) non-habitable floor below the Flood Construction Level

In order to preserve views from neighbouring houses along Bellevue Avenue, only one storey is proposed above Flood Construction Level

A zoning variance for retaining wall height is requested to enable the retaining wall to provide flood protection for the 2368 Bellevue property



SEAWALK LOOKING EAST

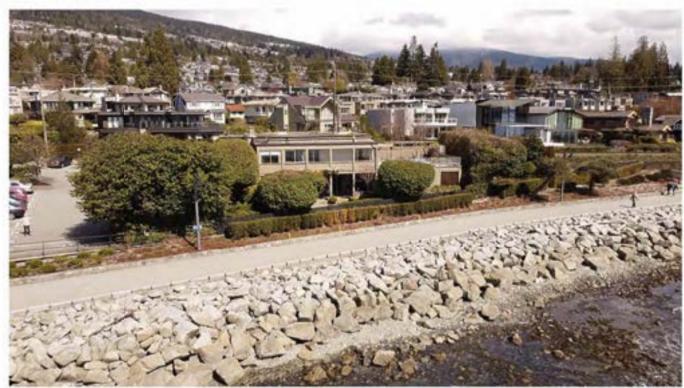

EXISTING DWELLING



EXISTING DWELLING



EXISTING DWELLING ENTRANCE





CONTEXT PLAN



SEASTRAND BUILDING





AMBLESIDE APPARTMENT AREA DEVELOPMENT PERMIT AREA



[...]

For the purpose of reducing the risk from coastal flood hazards on upland property and development, the following guidelines for buildings and construction shall apply:

* GUIDELINES NE 2 FORESHORE DEVELOPMENT PERMIT AREA


o) Consider zoning bylaw variances in order to construct a home at the elevation of the calculated FCL or 15 metres from the future estimated natural boundary of the ocean at Year 2100, whichever is greater (see Guideline I(b)). Variances may include, but are not limited to, height and setback variances. Requested variances shall consider proximity to adjacent dwellings, as well as privacy and view impacts for neighbours.


FORM & SCALE





3 EXISTING VIEW

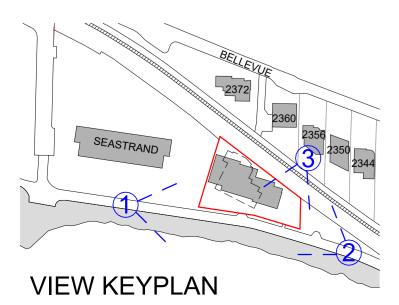

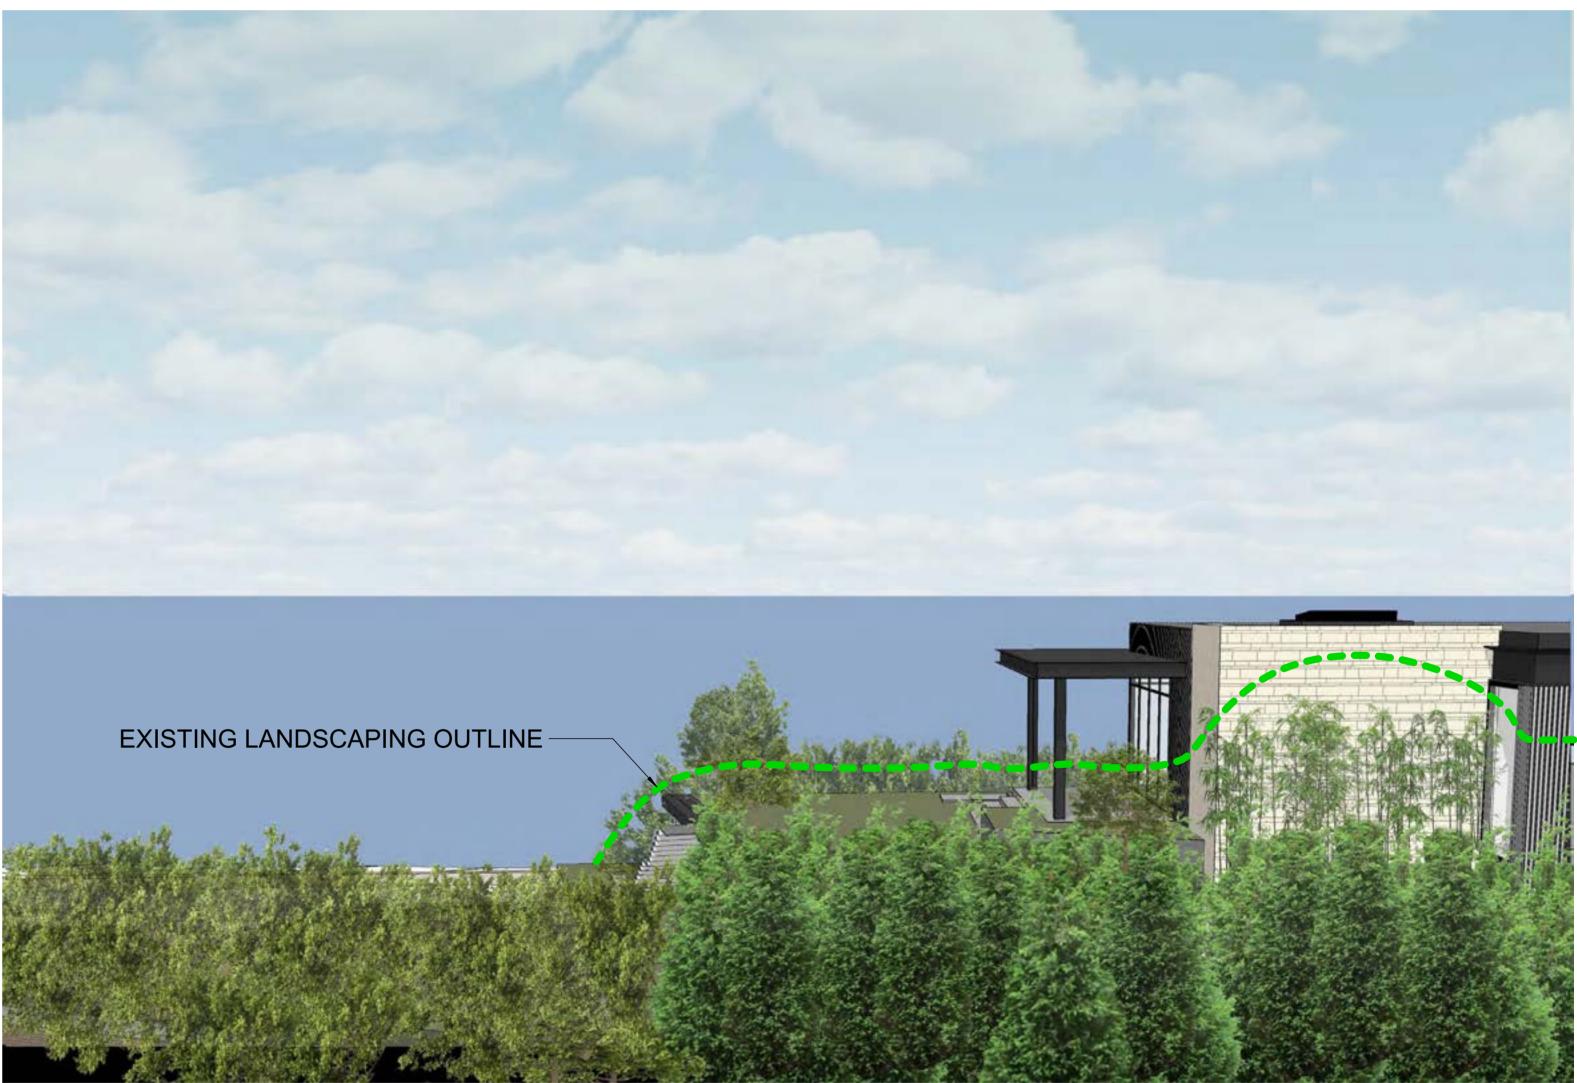






EXTERIOR MATERIALS



MATERIAL IMAGES




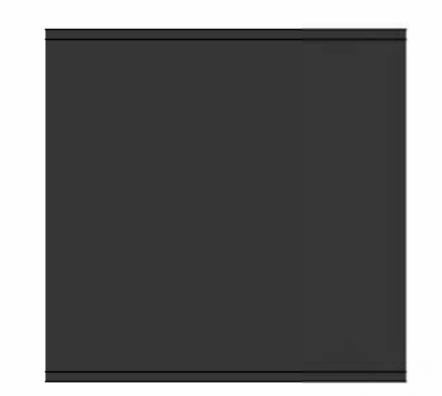

③ METAL ROOF TRIM



④ WOOD SOFFIT

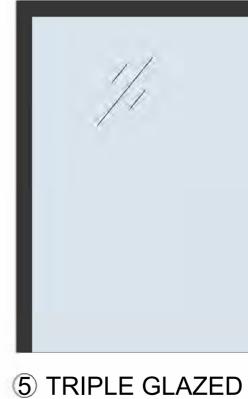


WINDOWS

MATERIAL SPECIFICATIONS

- (1) LIMESTONE WALL CLADDING 1 1/4" THICK 'LIMESTONE' STONE VENEER 3/4" BACKING 3/4" STRAPPING
- 2 FIBER CEMENT WALL CLADDING 5/16" THICK VERTICAL FIBER CEMENT PANELS, 12" WIDE BY 12' TALL PANEL 1 1/2" X 1 1/2" X 12' VERTICAL BATTENS 3/4" STRAPPING
- 3 METAL ROOF TRIM EXPOSED STEEL, PAINTED BLACK
- (4) WOOD SOFFIT 3/4" THICK HORIZONTAL WOOD SOFFIT
- 5 TRIPLE GLAZED WINDOWS TRIPLE GLAZED DOUBLE LOW-E (USI 0.8) FIBERGLASS MULLIONS PAINTED BLACK
- 6 BOARD FORM CONCRETE WALLS EXTERIOR GRAY CONCRETE WALL

6 BOARD FORM CONCRETE WALL


CHARACTER & MATERIAL

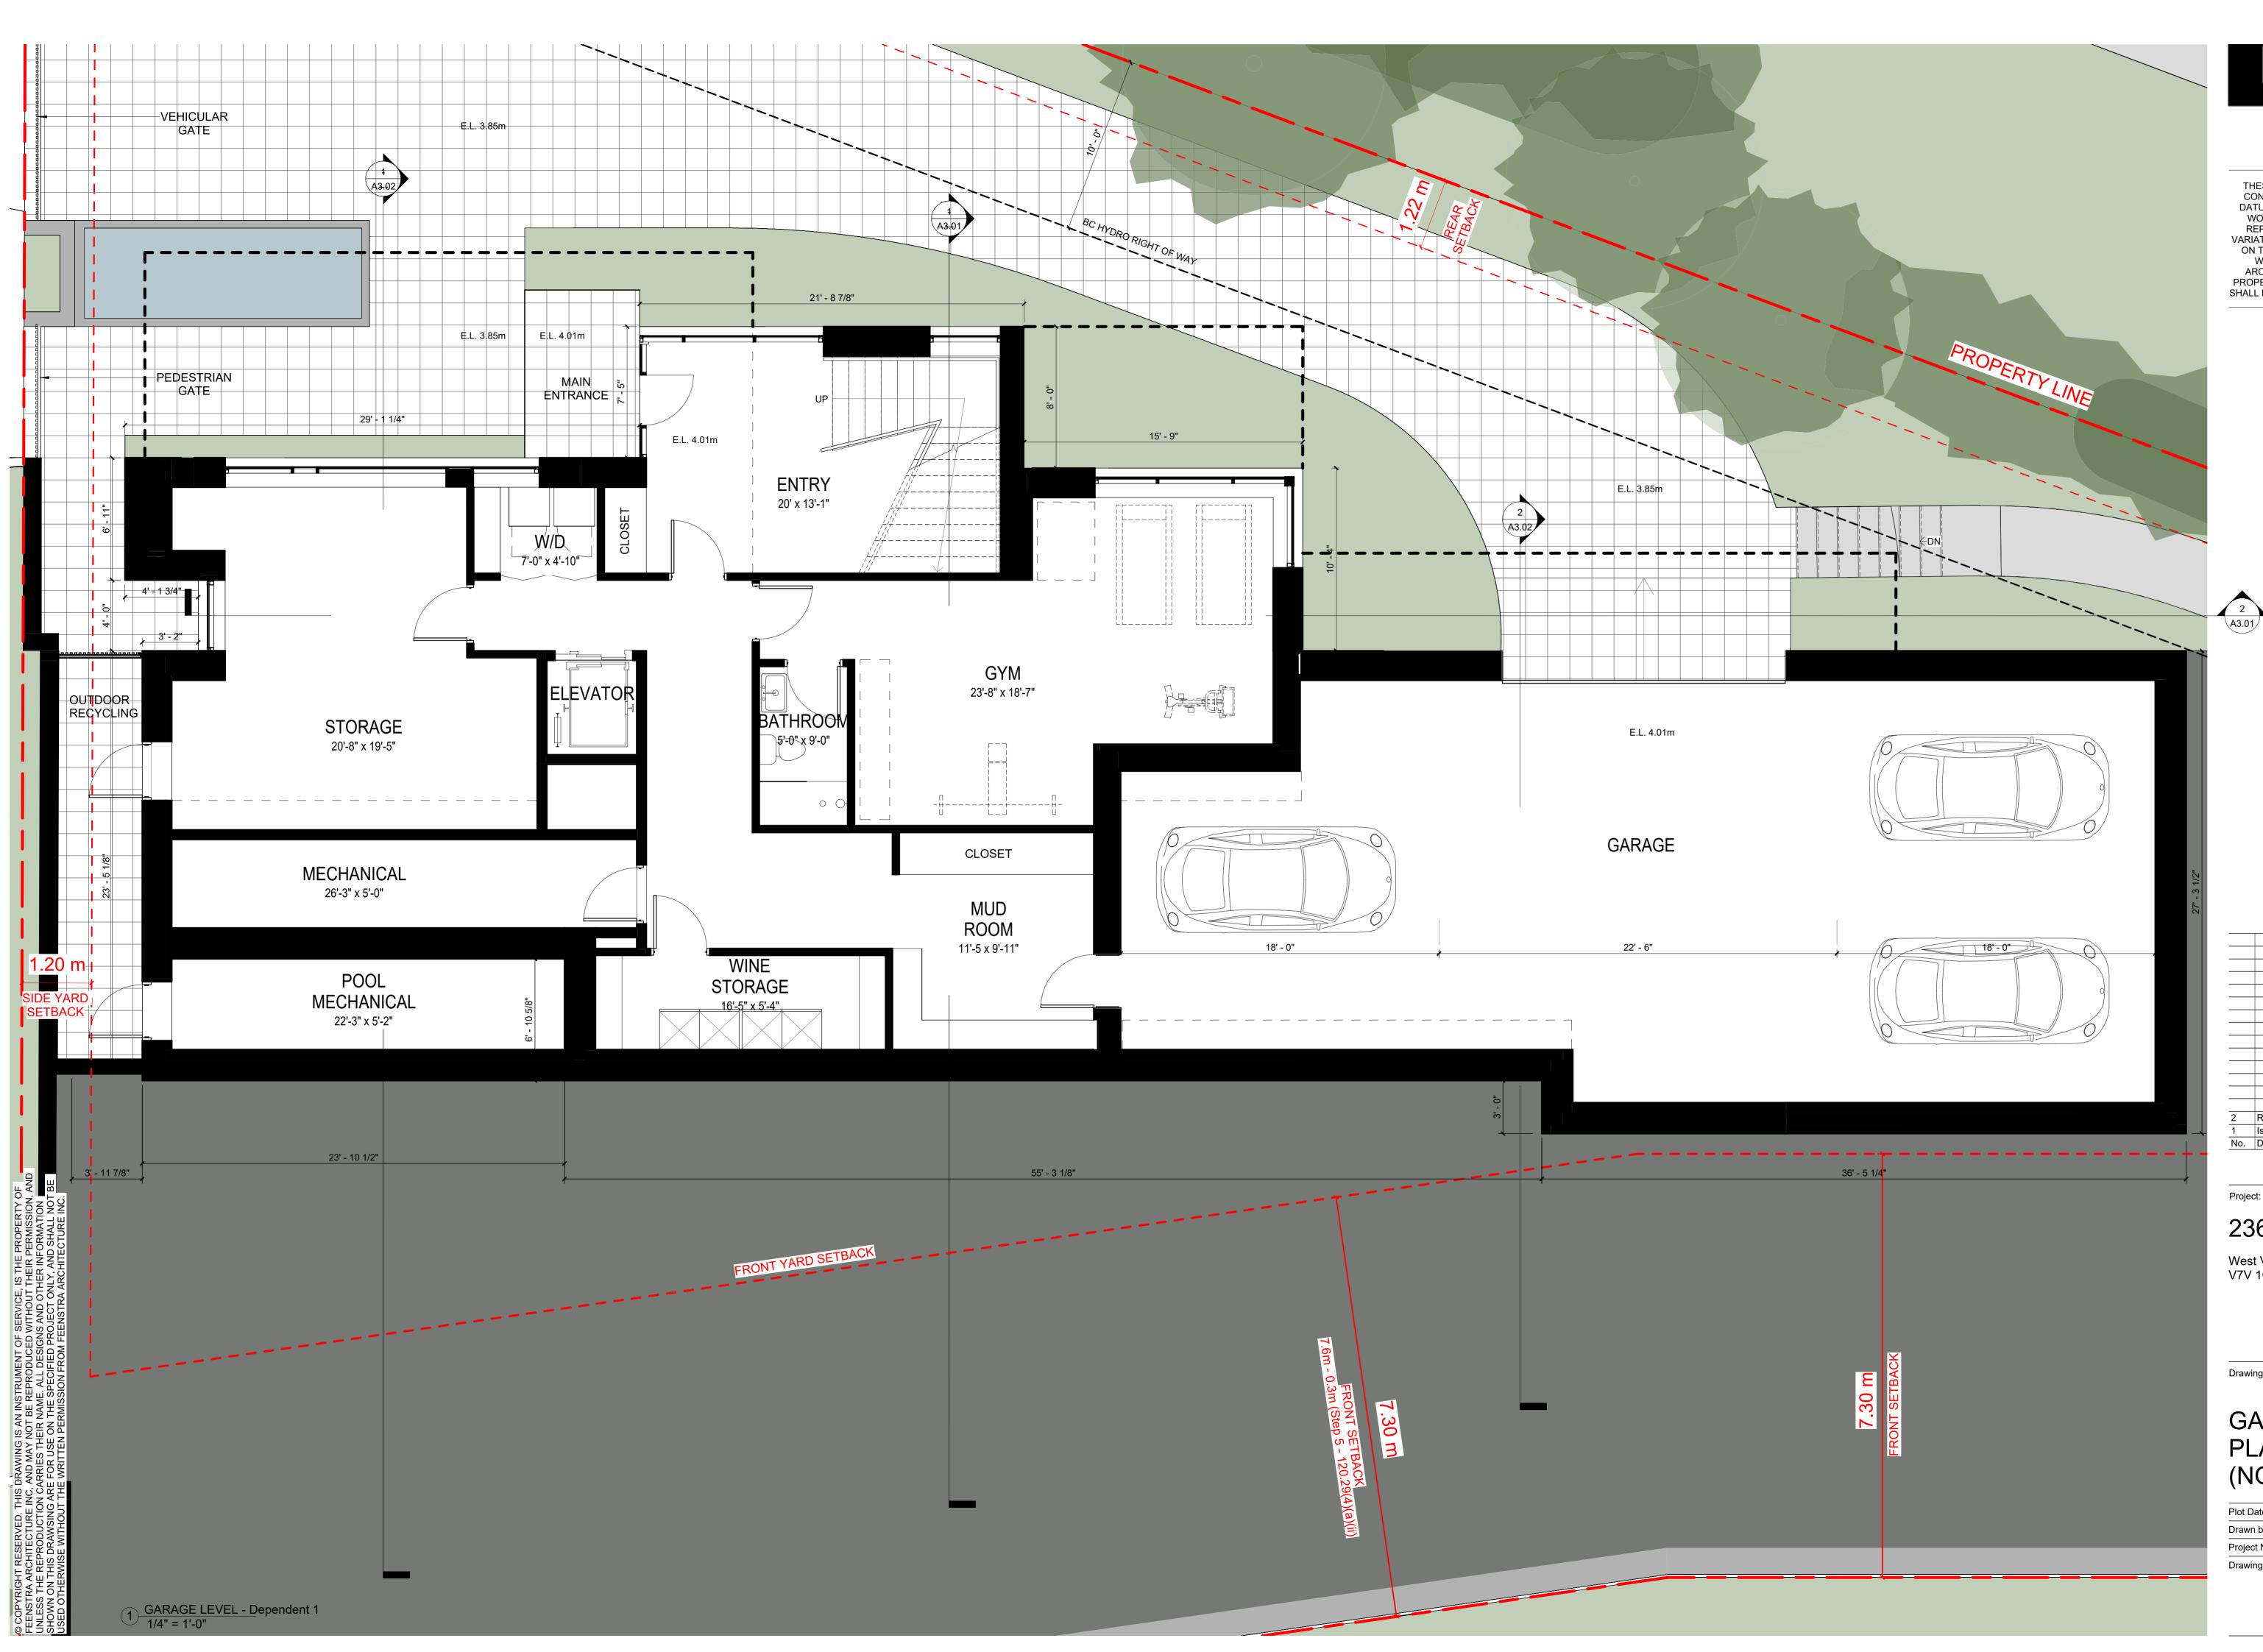



601 - 1587 West 8th Ave. Vancouver, B.C. V6J 1T5 Tel. (604) 739-8888 Fax (604) 739-8889

THESE DRAWINGS SHALL NOT BE SCALED. THE CONTRACTOR SHALL VERIFY ALL DIMENSIONS, DATUMS, AND LEVELS PRIOR TO BEGINNING THE WORK. ALL ERRORS AND OMMISSIONS TO BE REPORTED IMMEDIATELY TO THE ARCHITECT. VARIATIONS AND MODIFICATIONS TO WORK SHOWN ON THIS DRAWING SHALL NOT BE CARRIED OUT WITHOUT THE WRITTEN CONSENT OF THE ARCHITECT. THIS DRAWING IS THE EXCLUSIVE PROPERTY OF FEENSTRA ARCHITECTURE INC. AND SHALL NOT BE REPRODUCED WITHOUT PERMISSION.

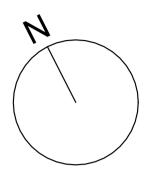

2	Re-issued for Development Permit	2023-08-17
1	Issued for Development Permit	2023-03-01
No.	Description	Date

Project:

2368 Bellevue Ave


West Vancouver, BC V7V 1C8

Drawing Title:

GARAGE LEVEL PLAN (NON HABITABLE)

Plot Date: 07/09/02		
Drawn by: Author	awn by: Author Checked by: Checker	
Project No.	Scale:	1/4" = 1'-0"
Drawing No.		


A1.03

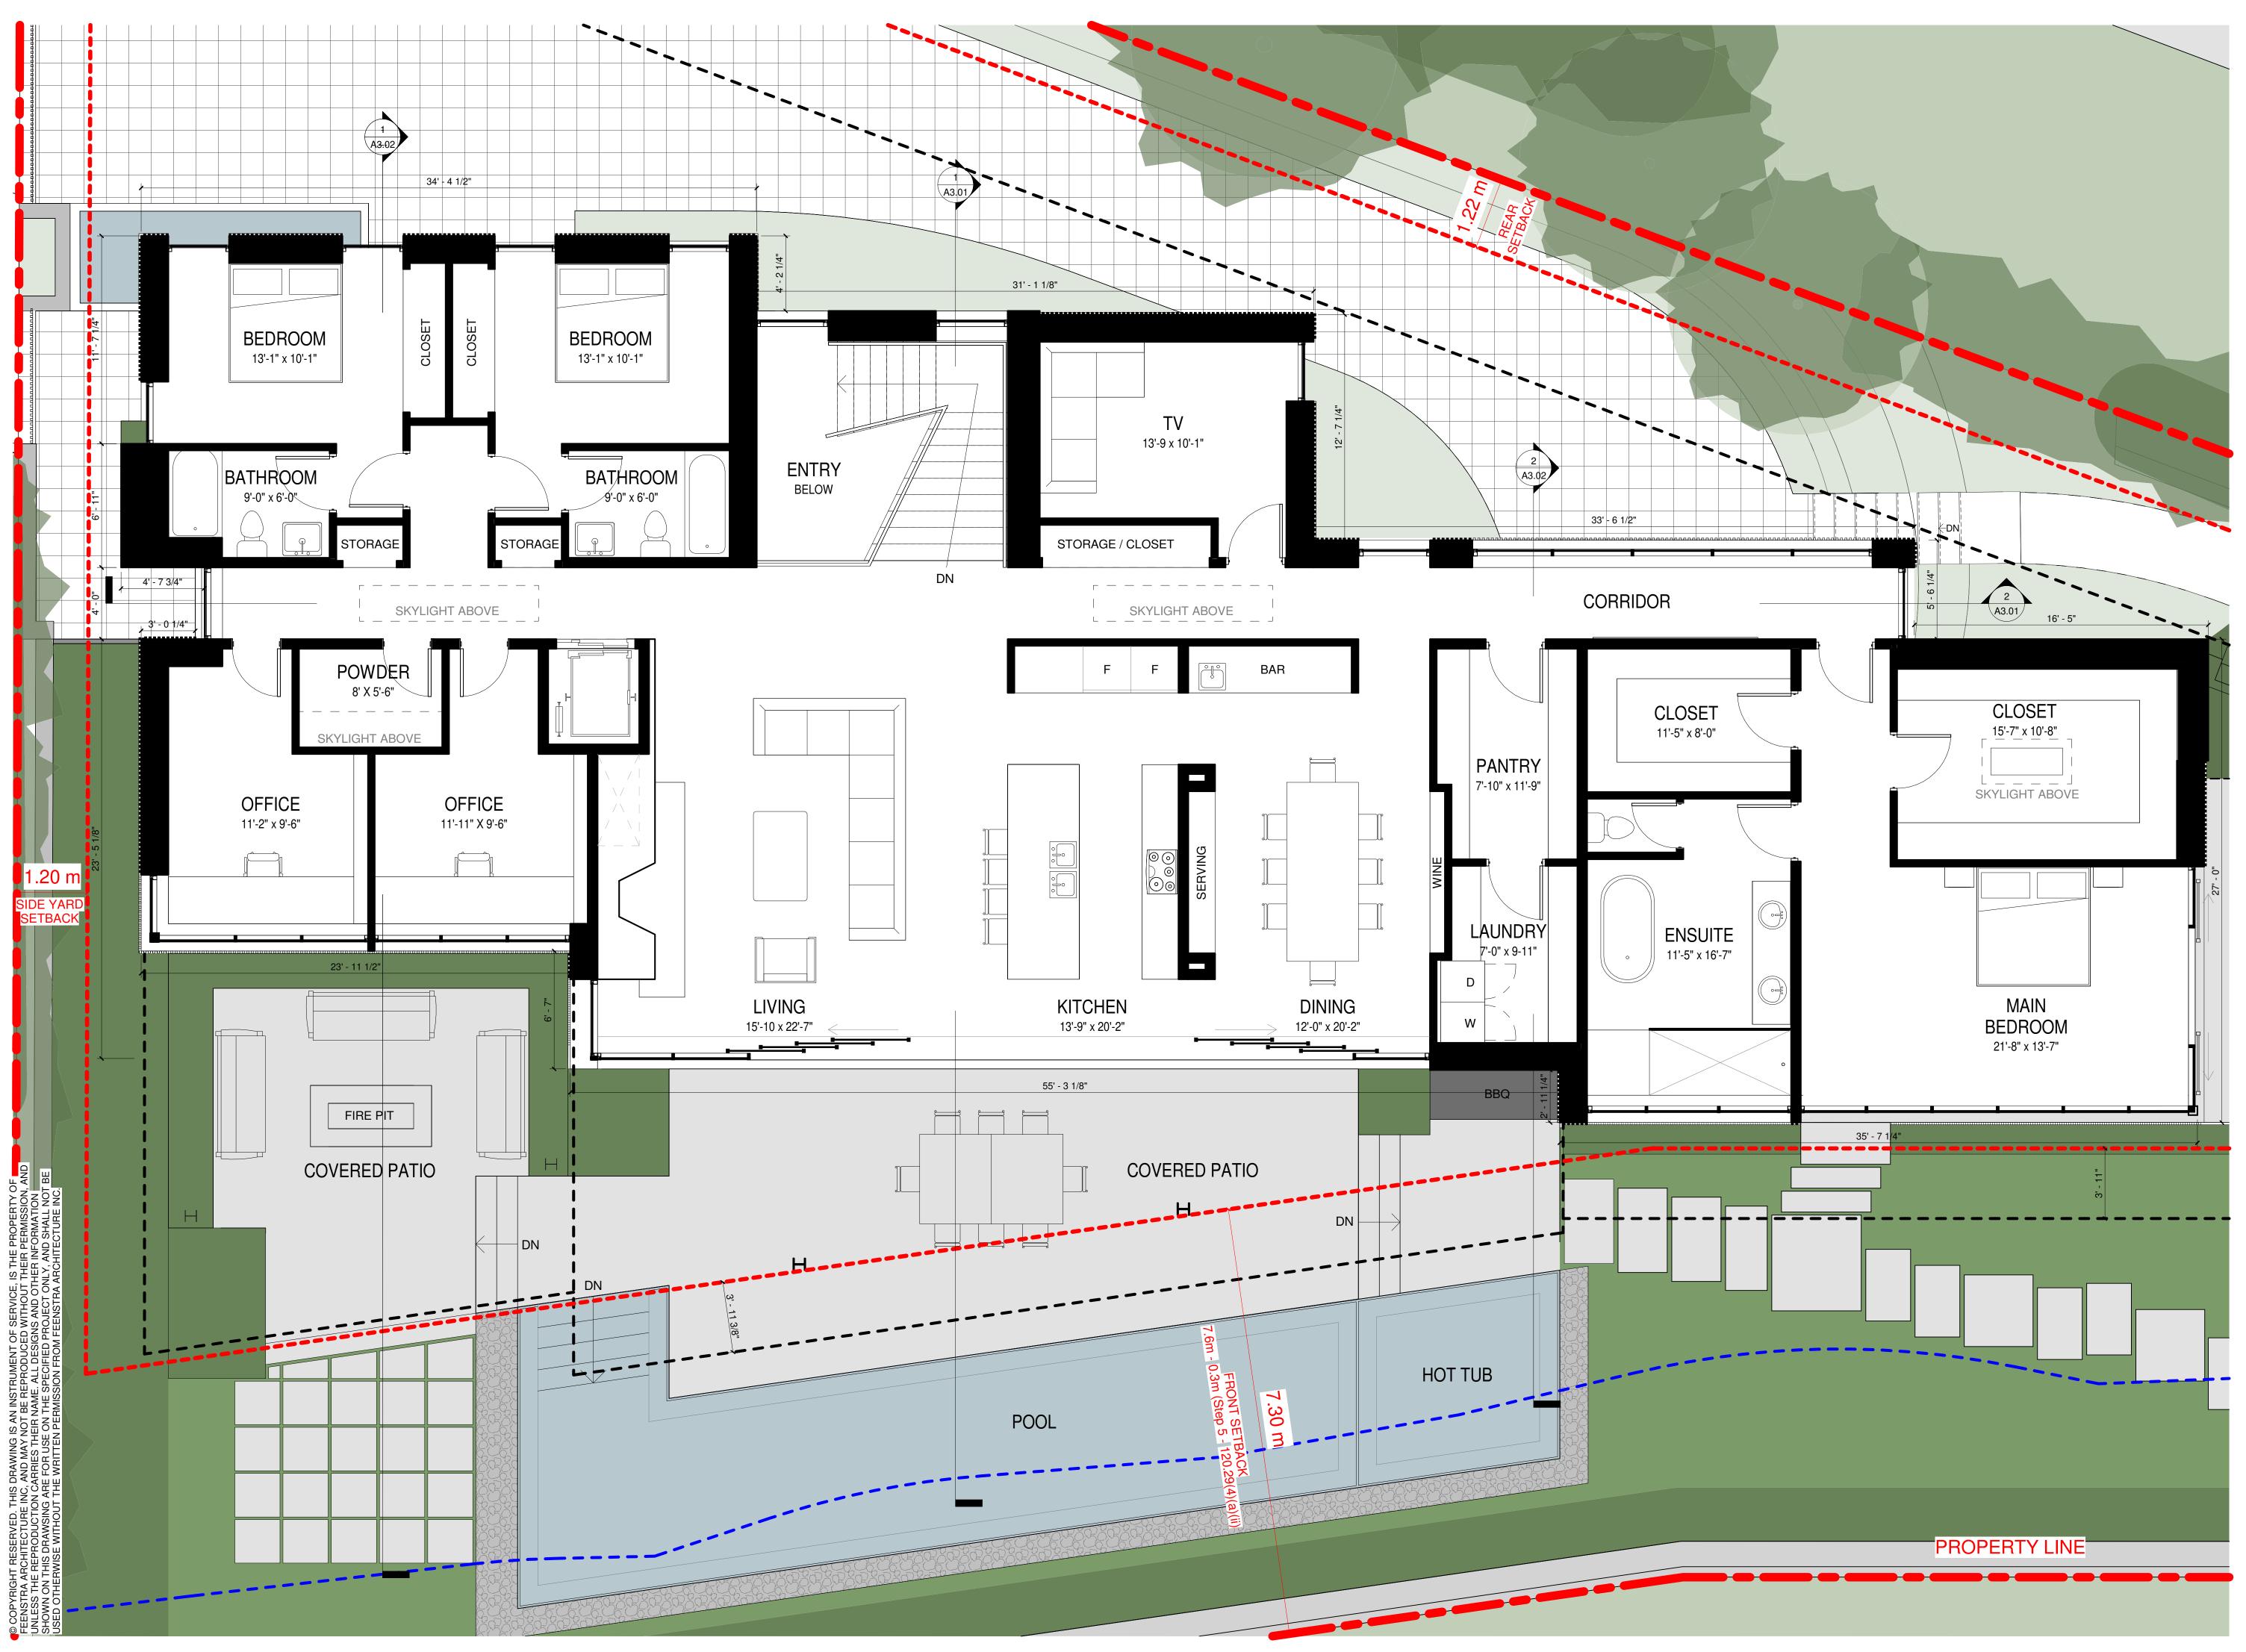



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2	Re-issued for Development Permit	2023-08-17
1	Issued for Development Permit	2023-03-01
No.	Description	Date

Project:

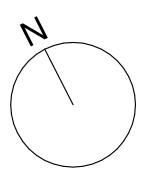2368 Bellevue Ave

West Vancouver, BC V7V 1C8

Drawing Title:

MAIN FLOOR

Plot Date: 07/09/02 Drawn by: Author Project No. Drawing No.

Checked by: Checker Scale: 1/4" = 1'-0"

A1.01





2	Re-issued for Development Permit	2023-08-17
1	Issued for Development Permit	2023-03-01
No.	Description	Date

Project:

2368 Bellevue Ave

West Vancouver, BC V7V 1C8

Drawing Title:

ELEVATIONS

Plot Date: 07/09/02	
Drawn by: Author	Checked by: Checker
Project No.	Scale: As indicated
Drawing No.	


A2.01B

2 WEST ELEVATION 1/4" = 1'-0"

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Drawing Title:

ELEVATIONS

Plot Date: 07/09/02 Drawn by: Author Project No. Drawing No.

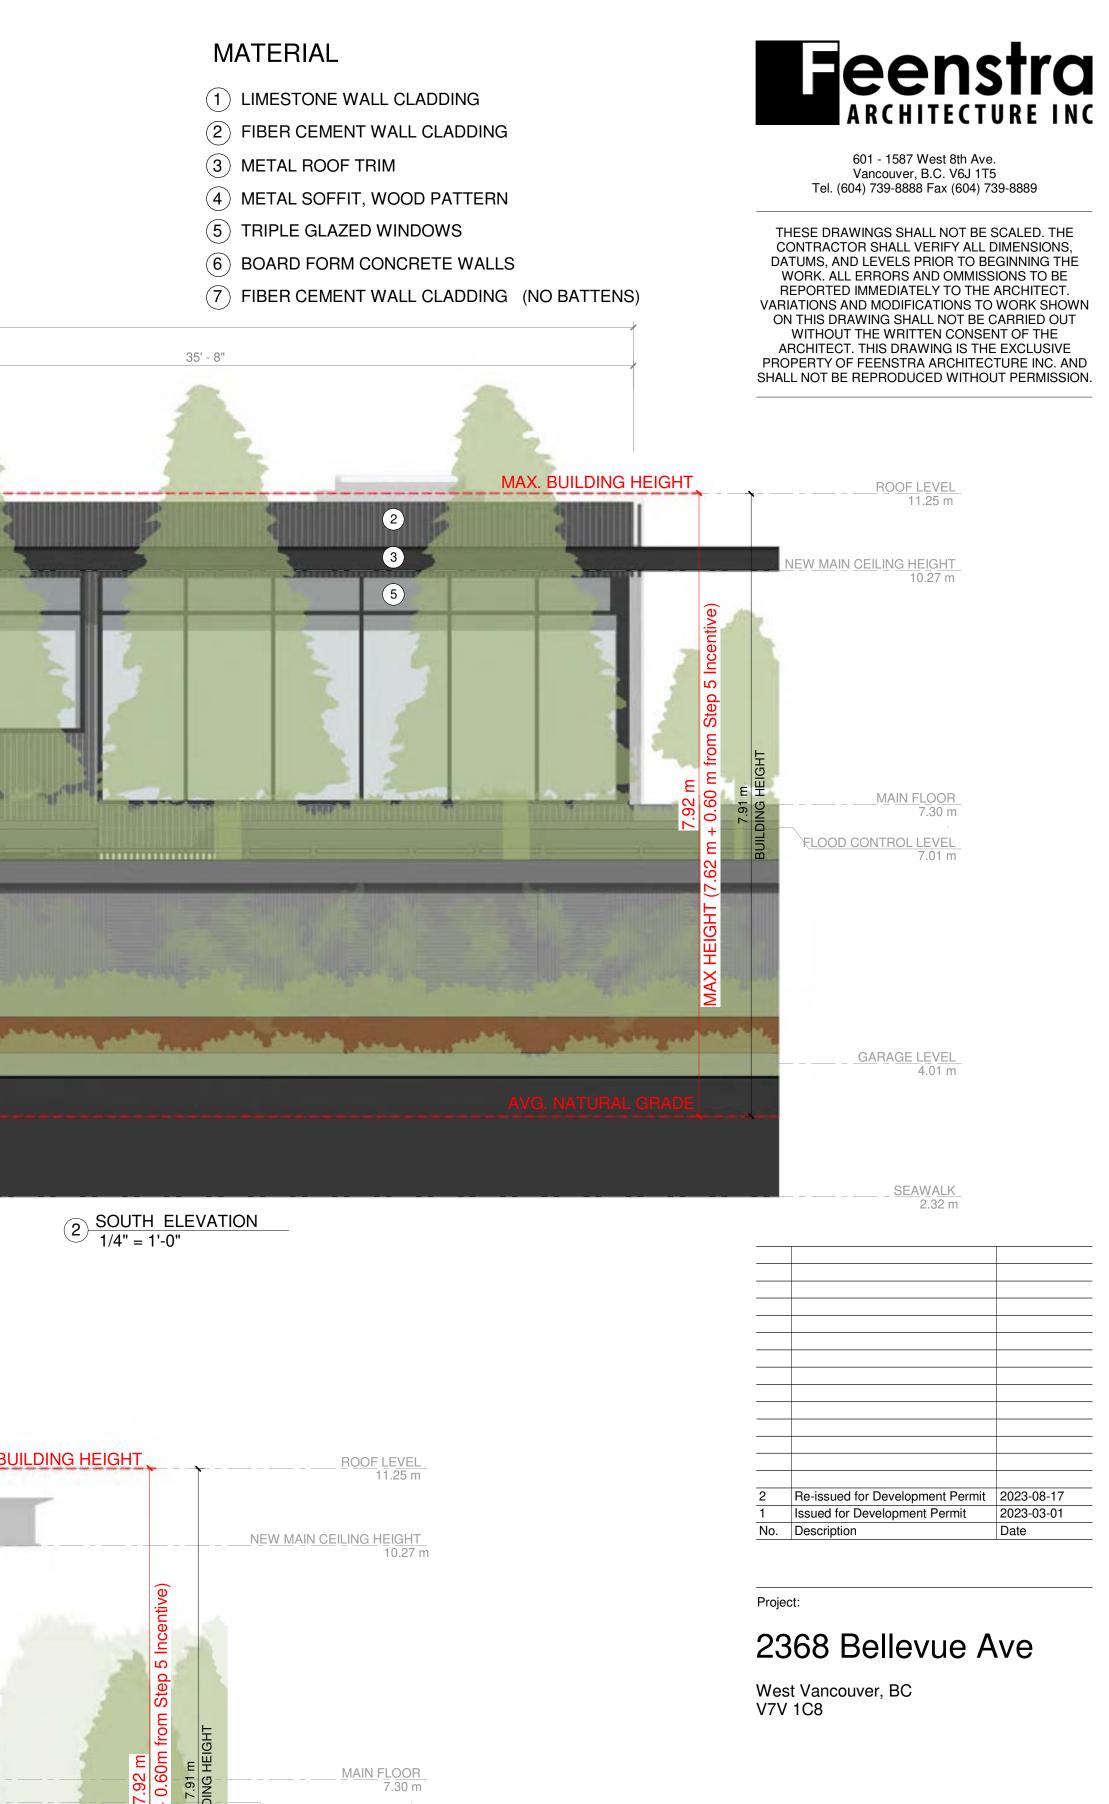
Checked by: Checker Scale: As indicated


1 EAST ELEVATION 1/4" = 1'-0"

SEAWALK

RLOOD CONTROL LEVEL 7.01 m


GARAGE LEVEL 4.01 m

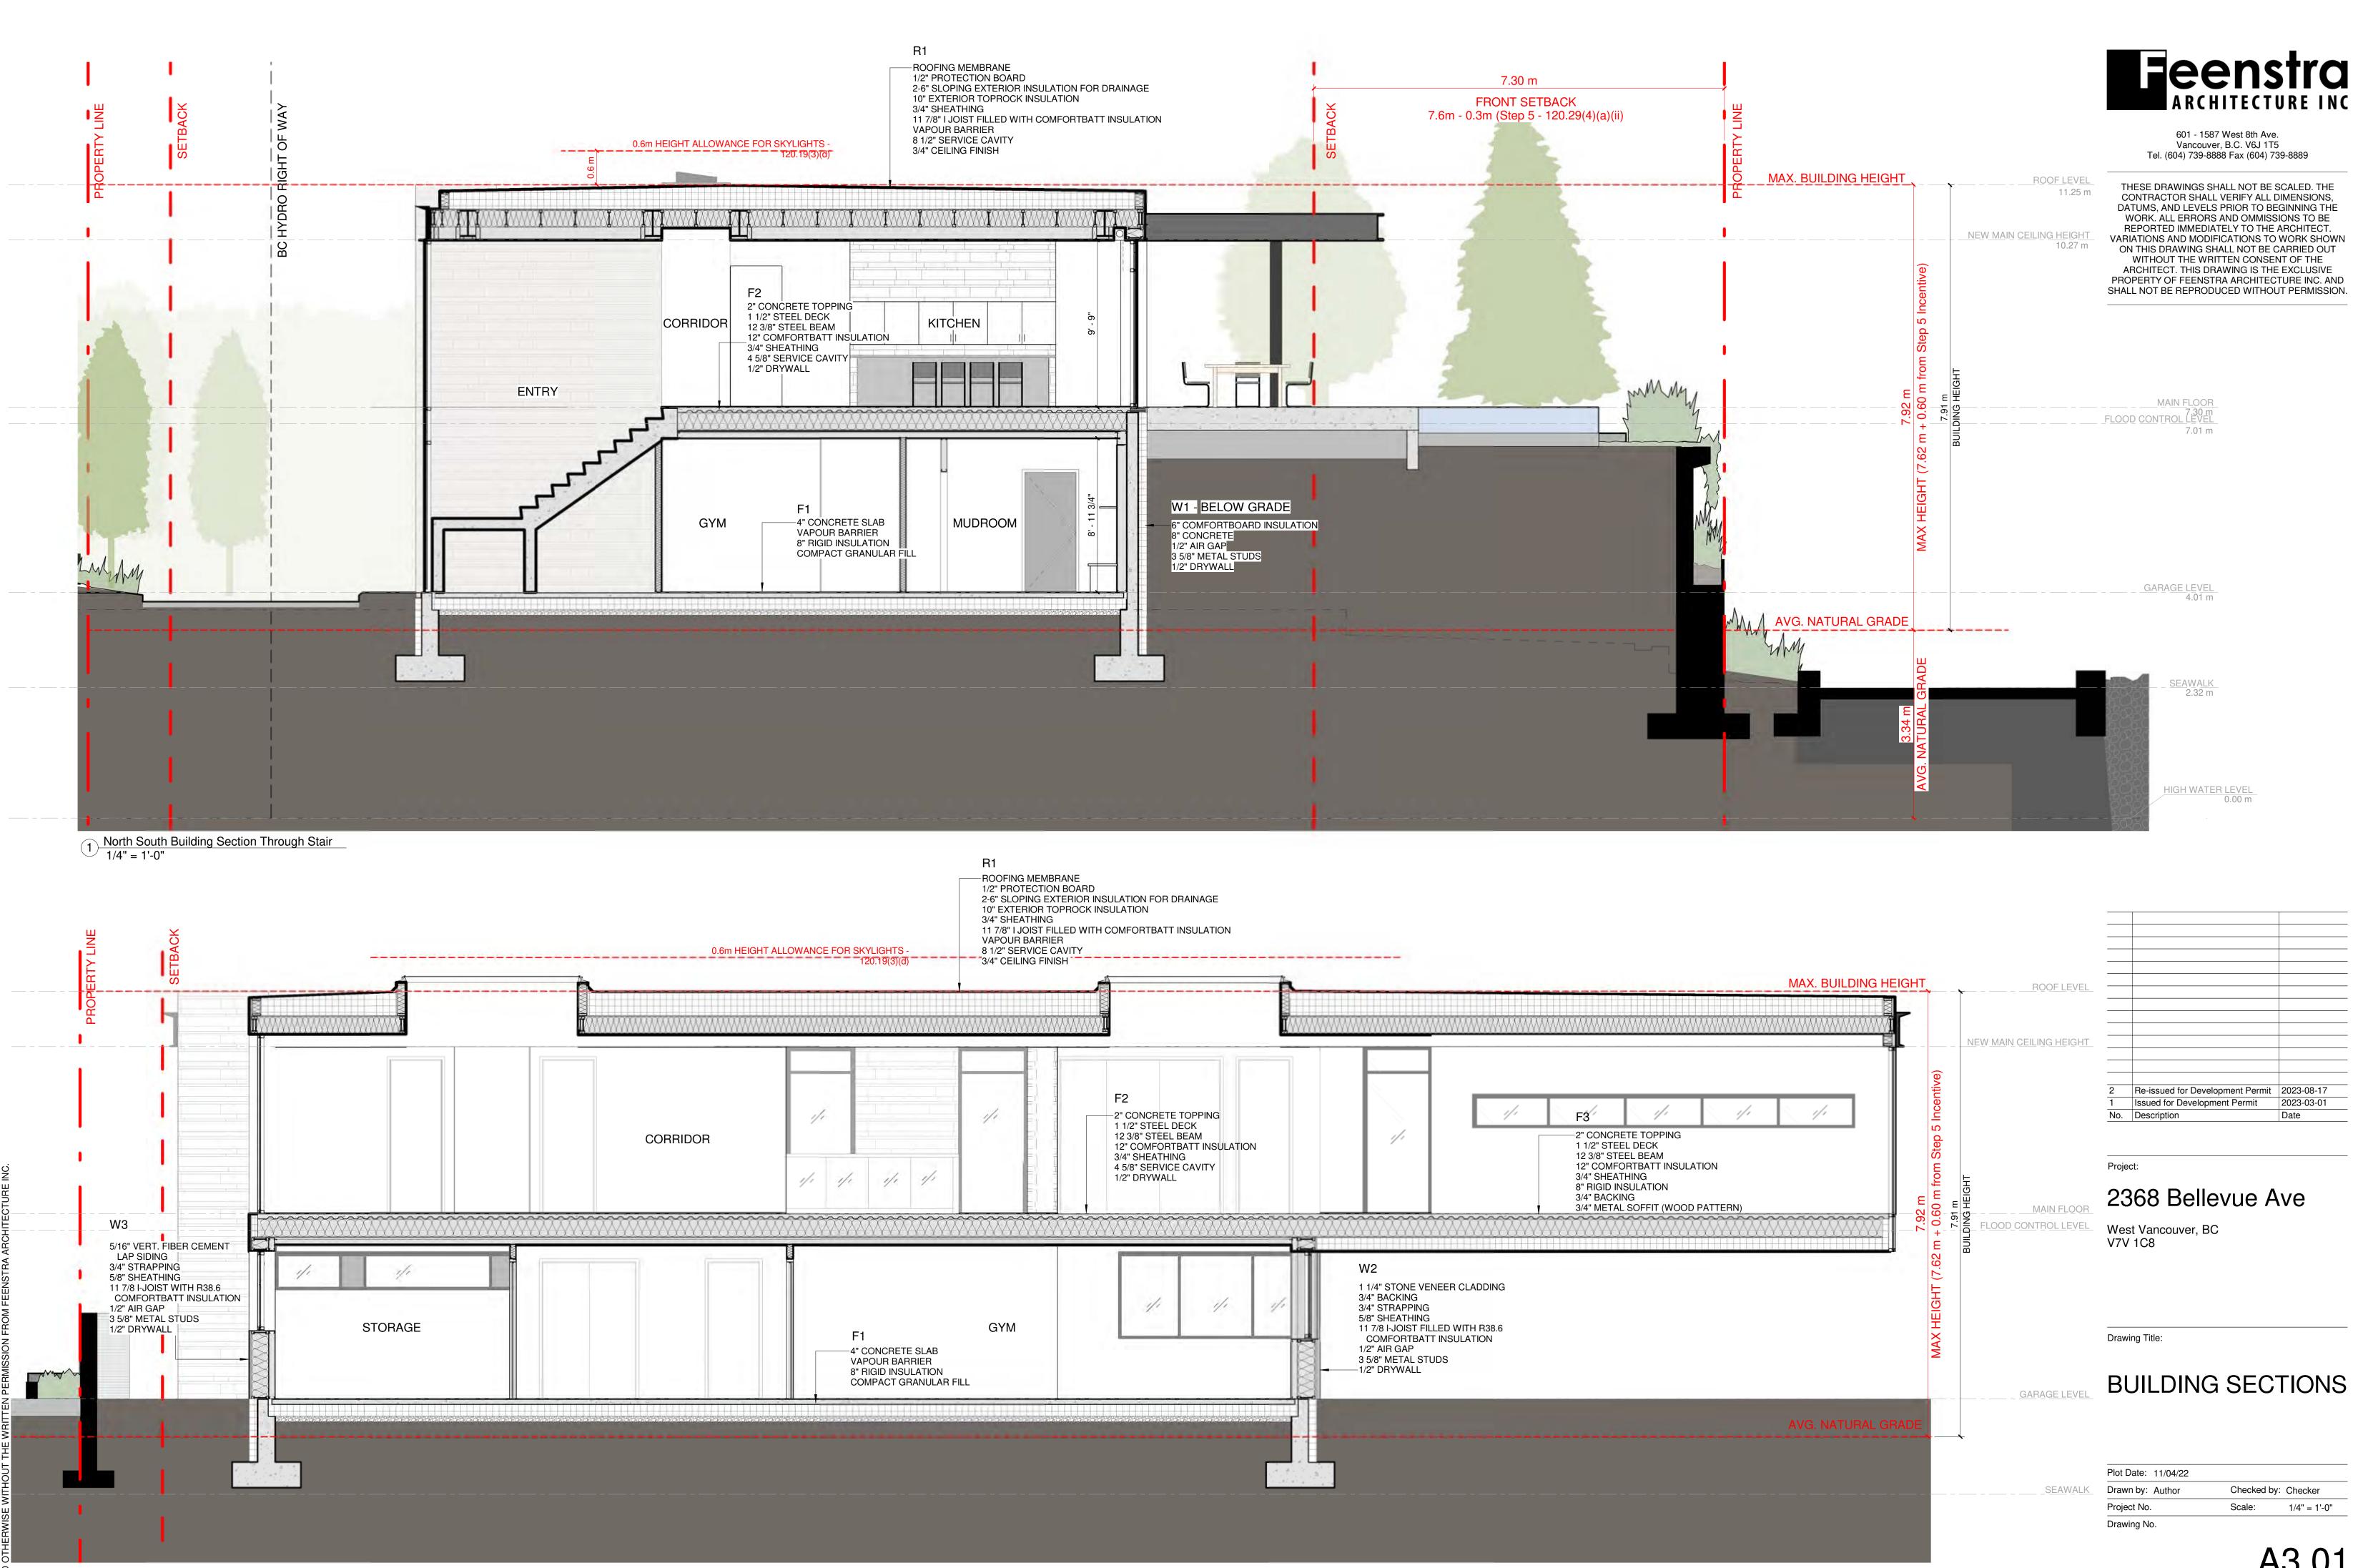

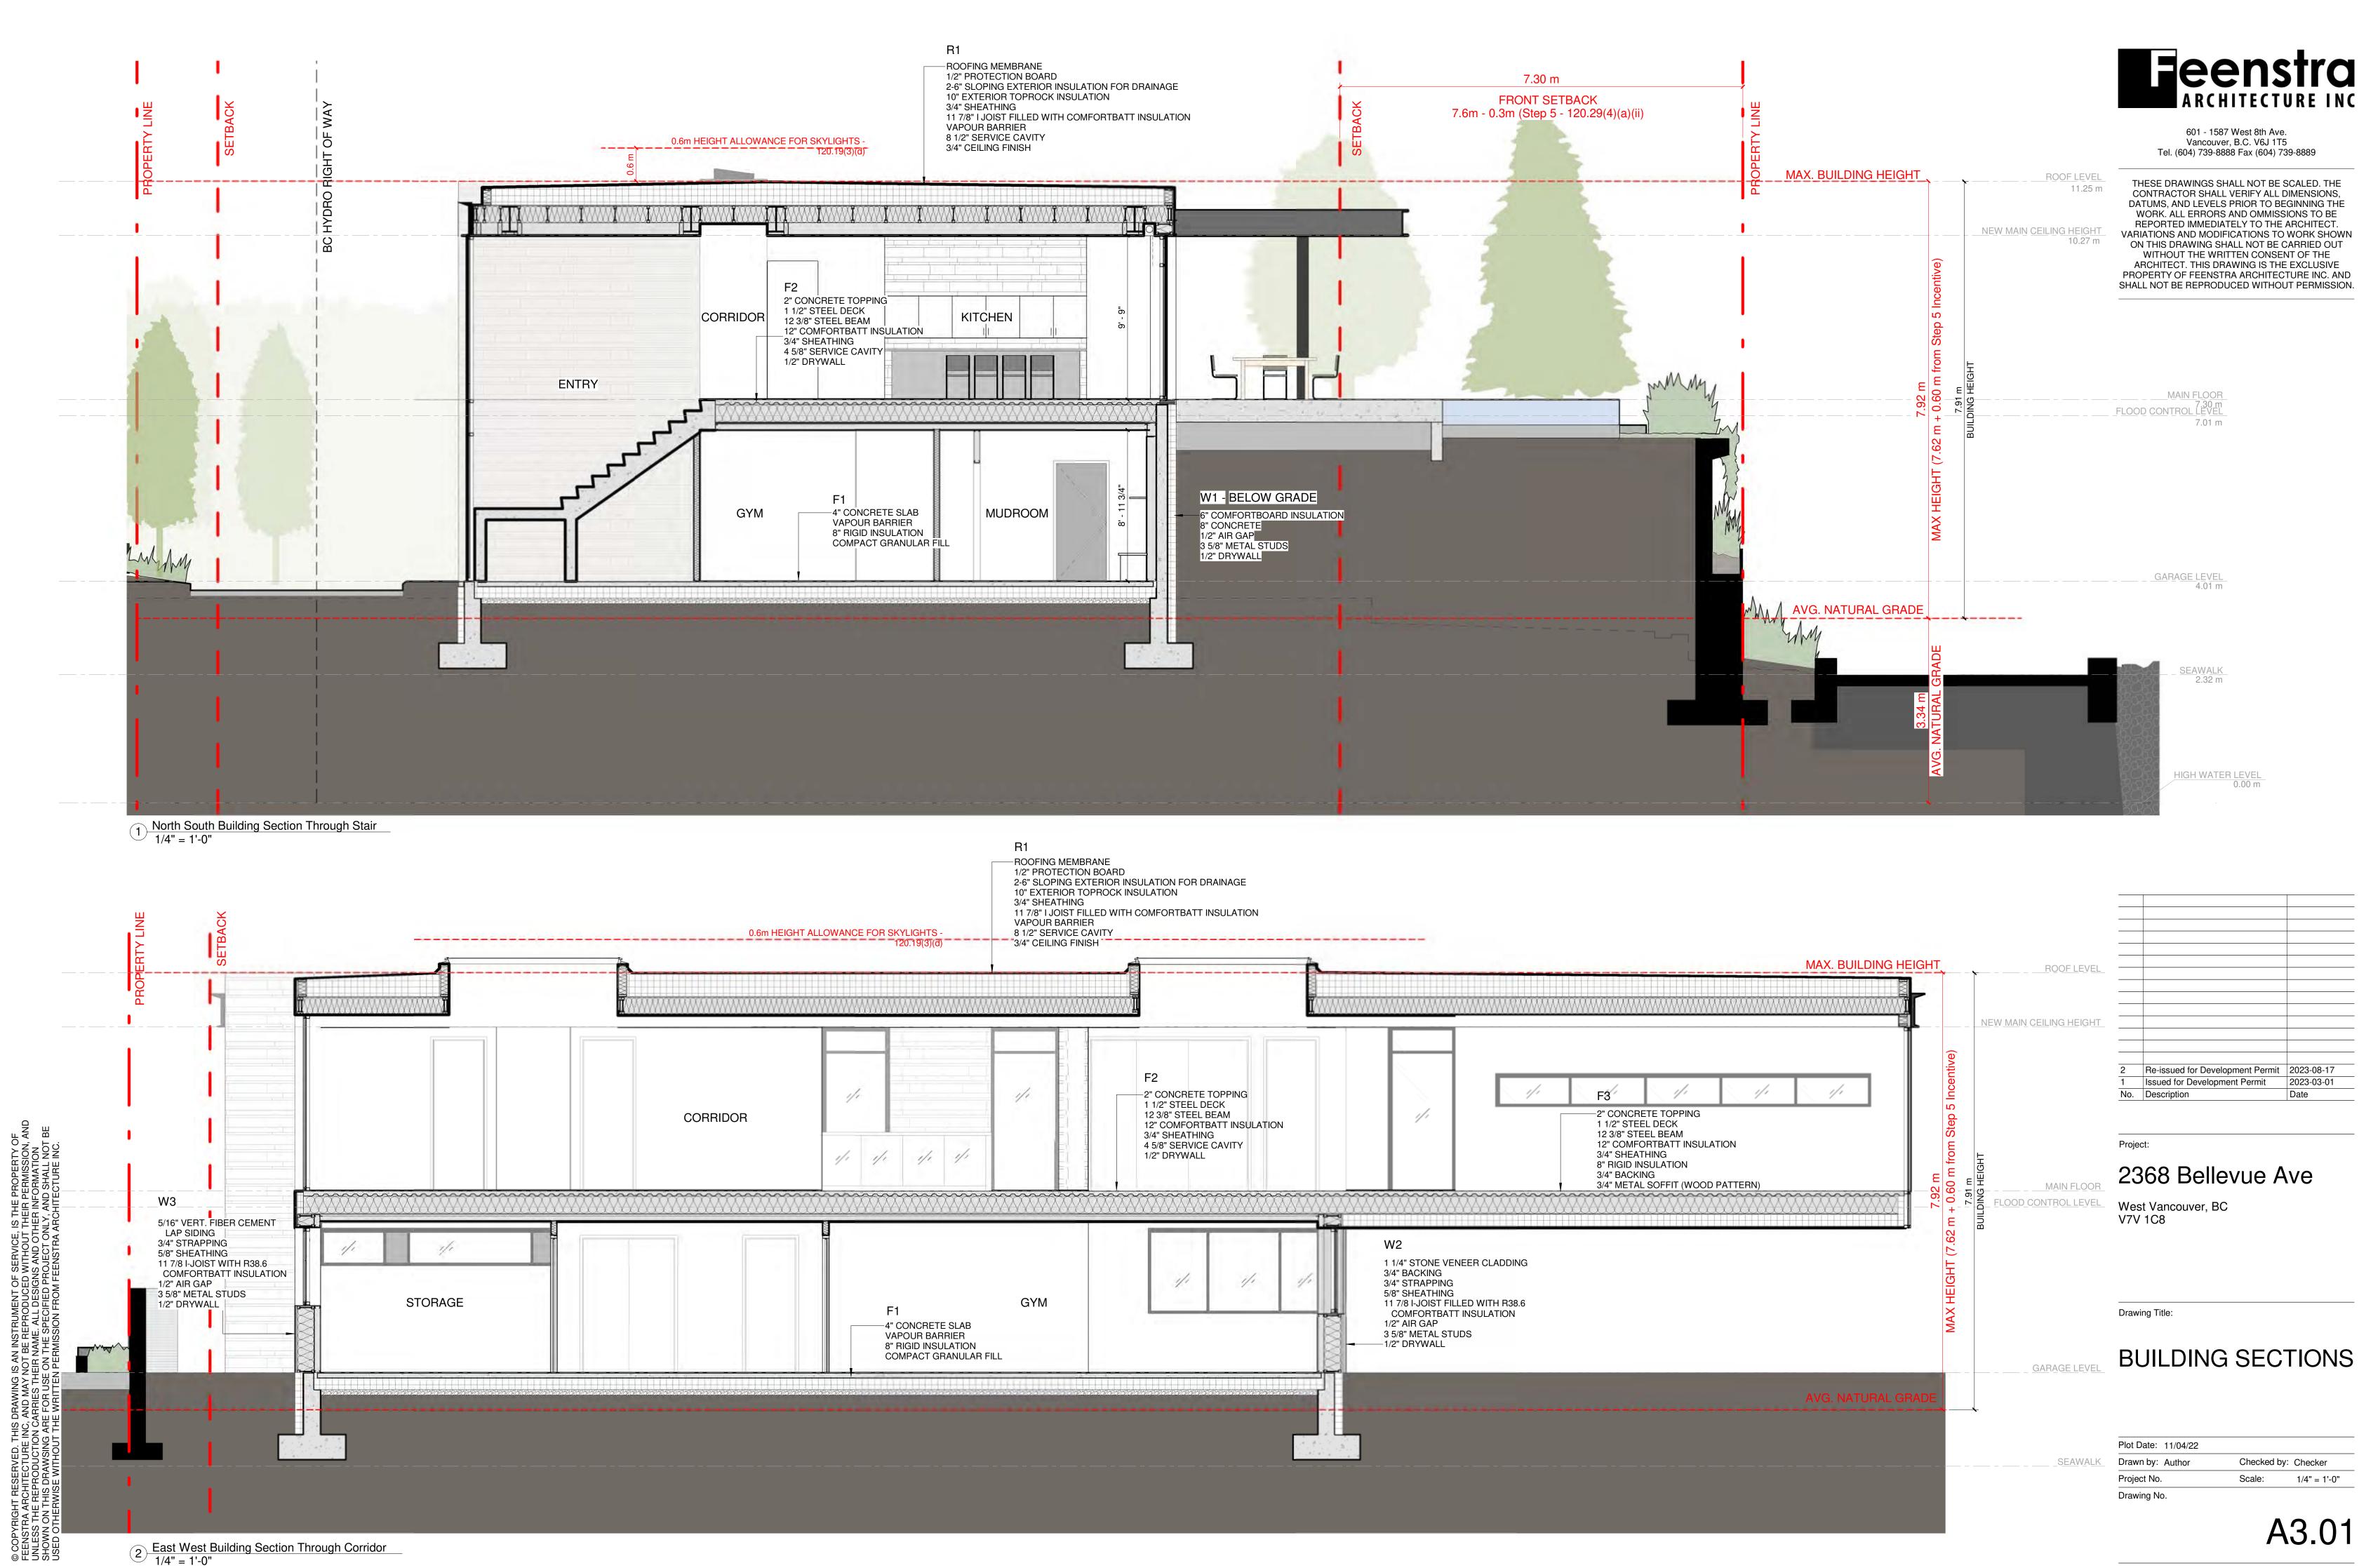





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1 SITE PLAN SHOWING CURRENT RETAINING WALL REQUIREMENTS 1/16" = 1'-0"

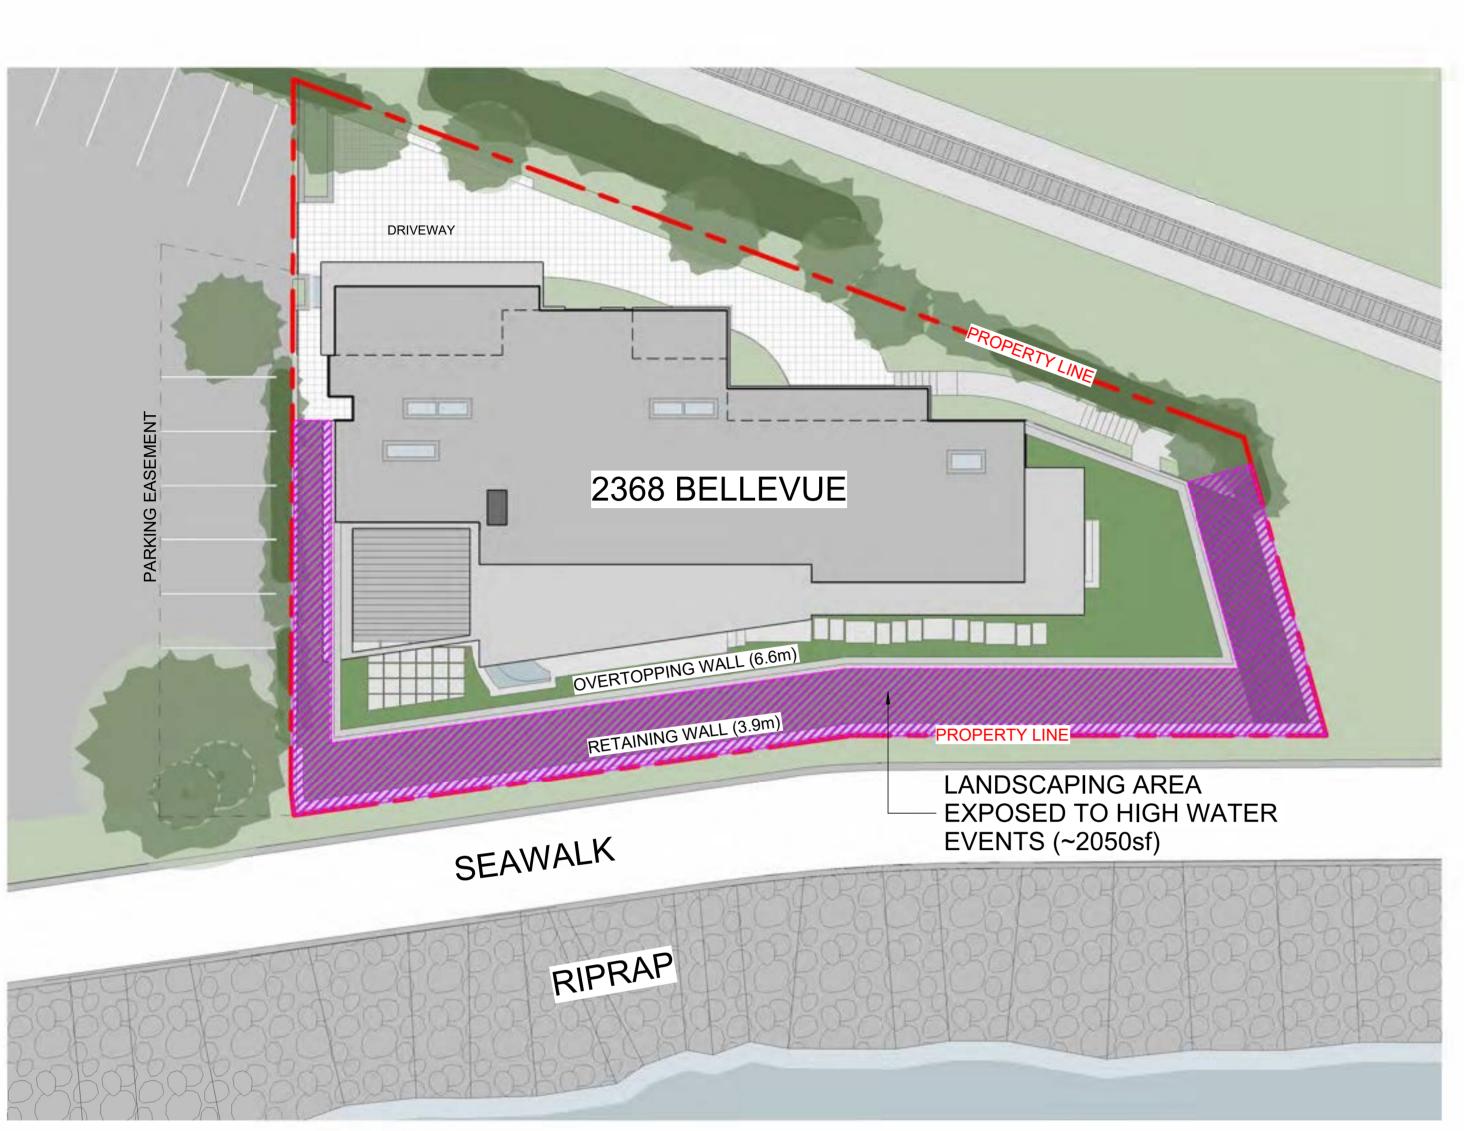

 $3 \frac{\text{CURRENT REQUIREMENTS FOR RETAINING WALLS}}{3/16" = 1'-0"}$

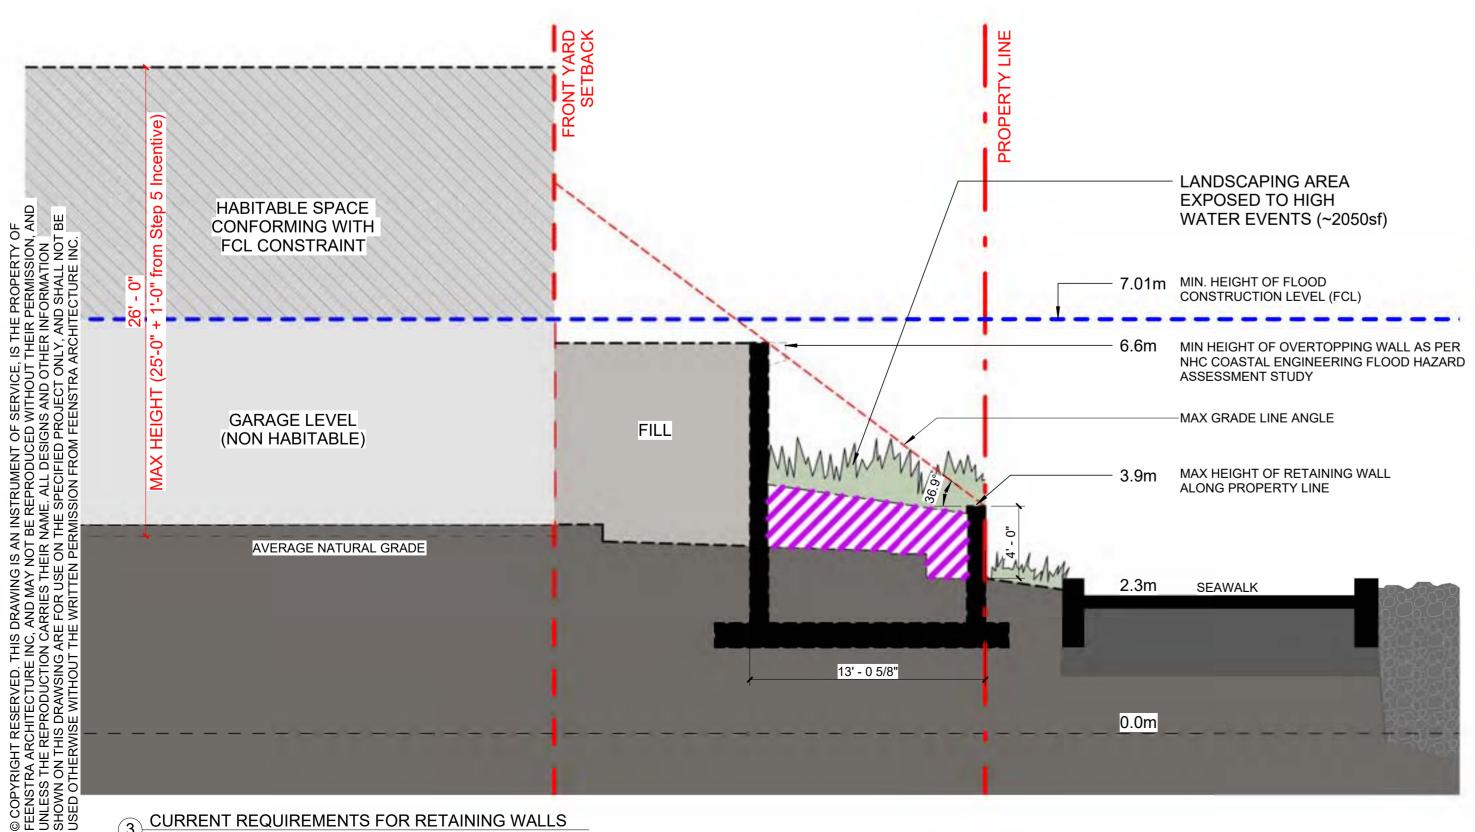

2 SITE PLAN SHOWING PROPOSED RETAINING WALL VARIANCE 1/16" = 1'-0"

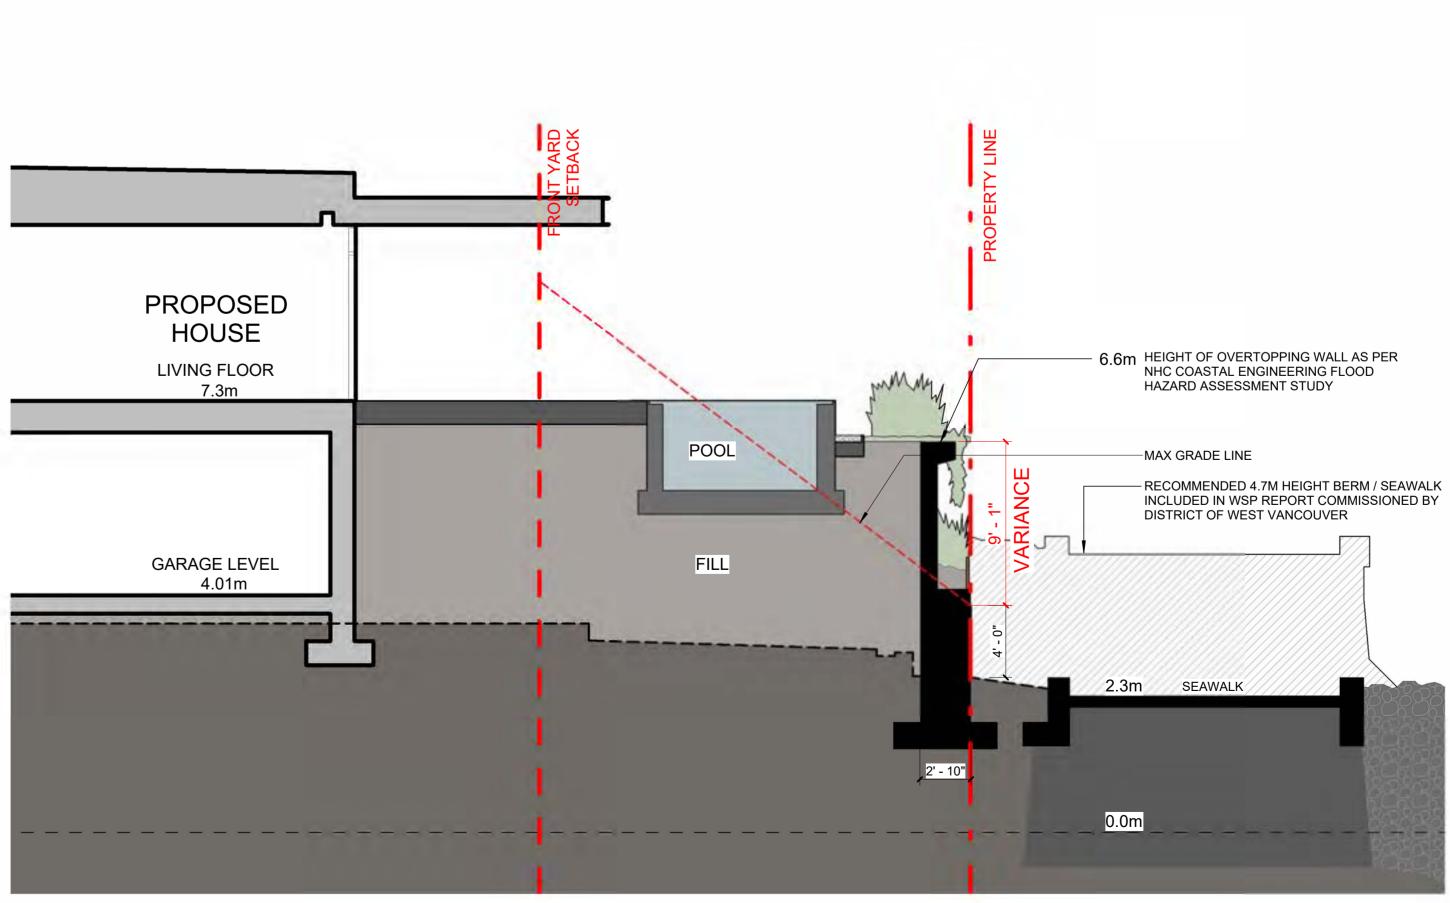


PROPOSED VARIANCE FOR RETAINING WALL HEIGHT ALONG SOUTH PROPERTY LINE
3/16" = 1'-0"



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3 2	Issued for Form and Character	2024-03-28
2	Re-issued for Development Permit	2023-08-17
1	Issued for Development Permit	2023-03-01
No.	Description	Date

Project:

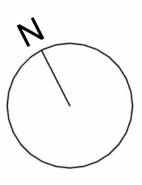2368 Bellevue Ave

West Vancouver, BC V7V 1C8

Drawing Title:

PROPOSED **RETAINING WALL** VARIANCE

Plot Date: 01/27/23	
Drawn by: Author	Checked by: Checker
Project No.	Scale: As indicated
Drawing No.	

A6.02

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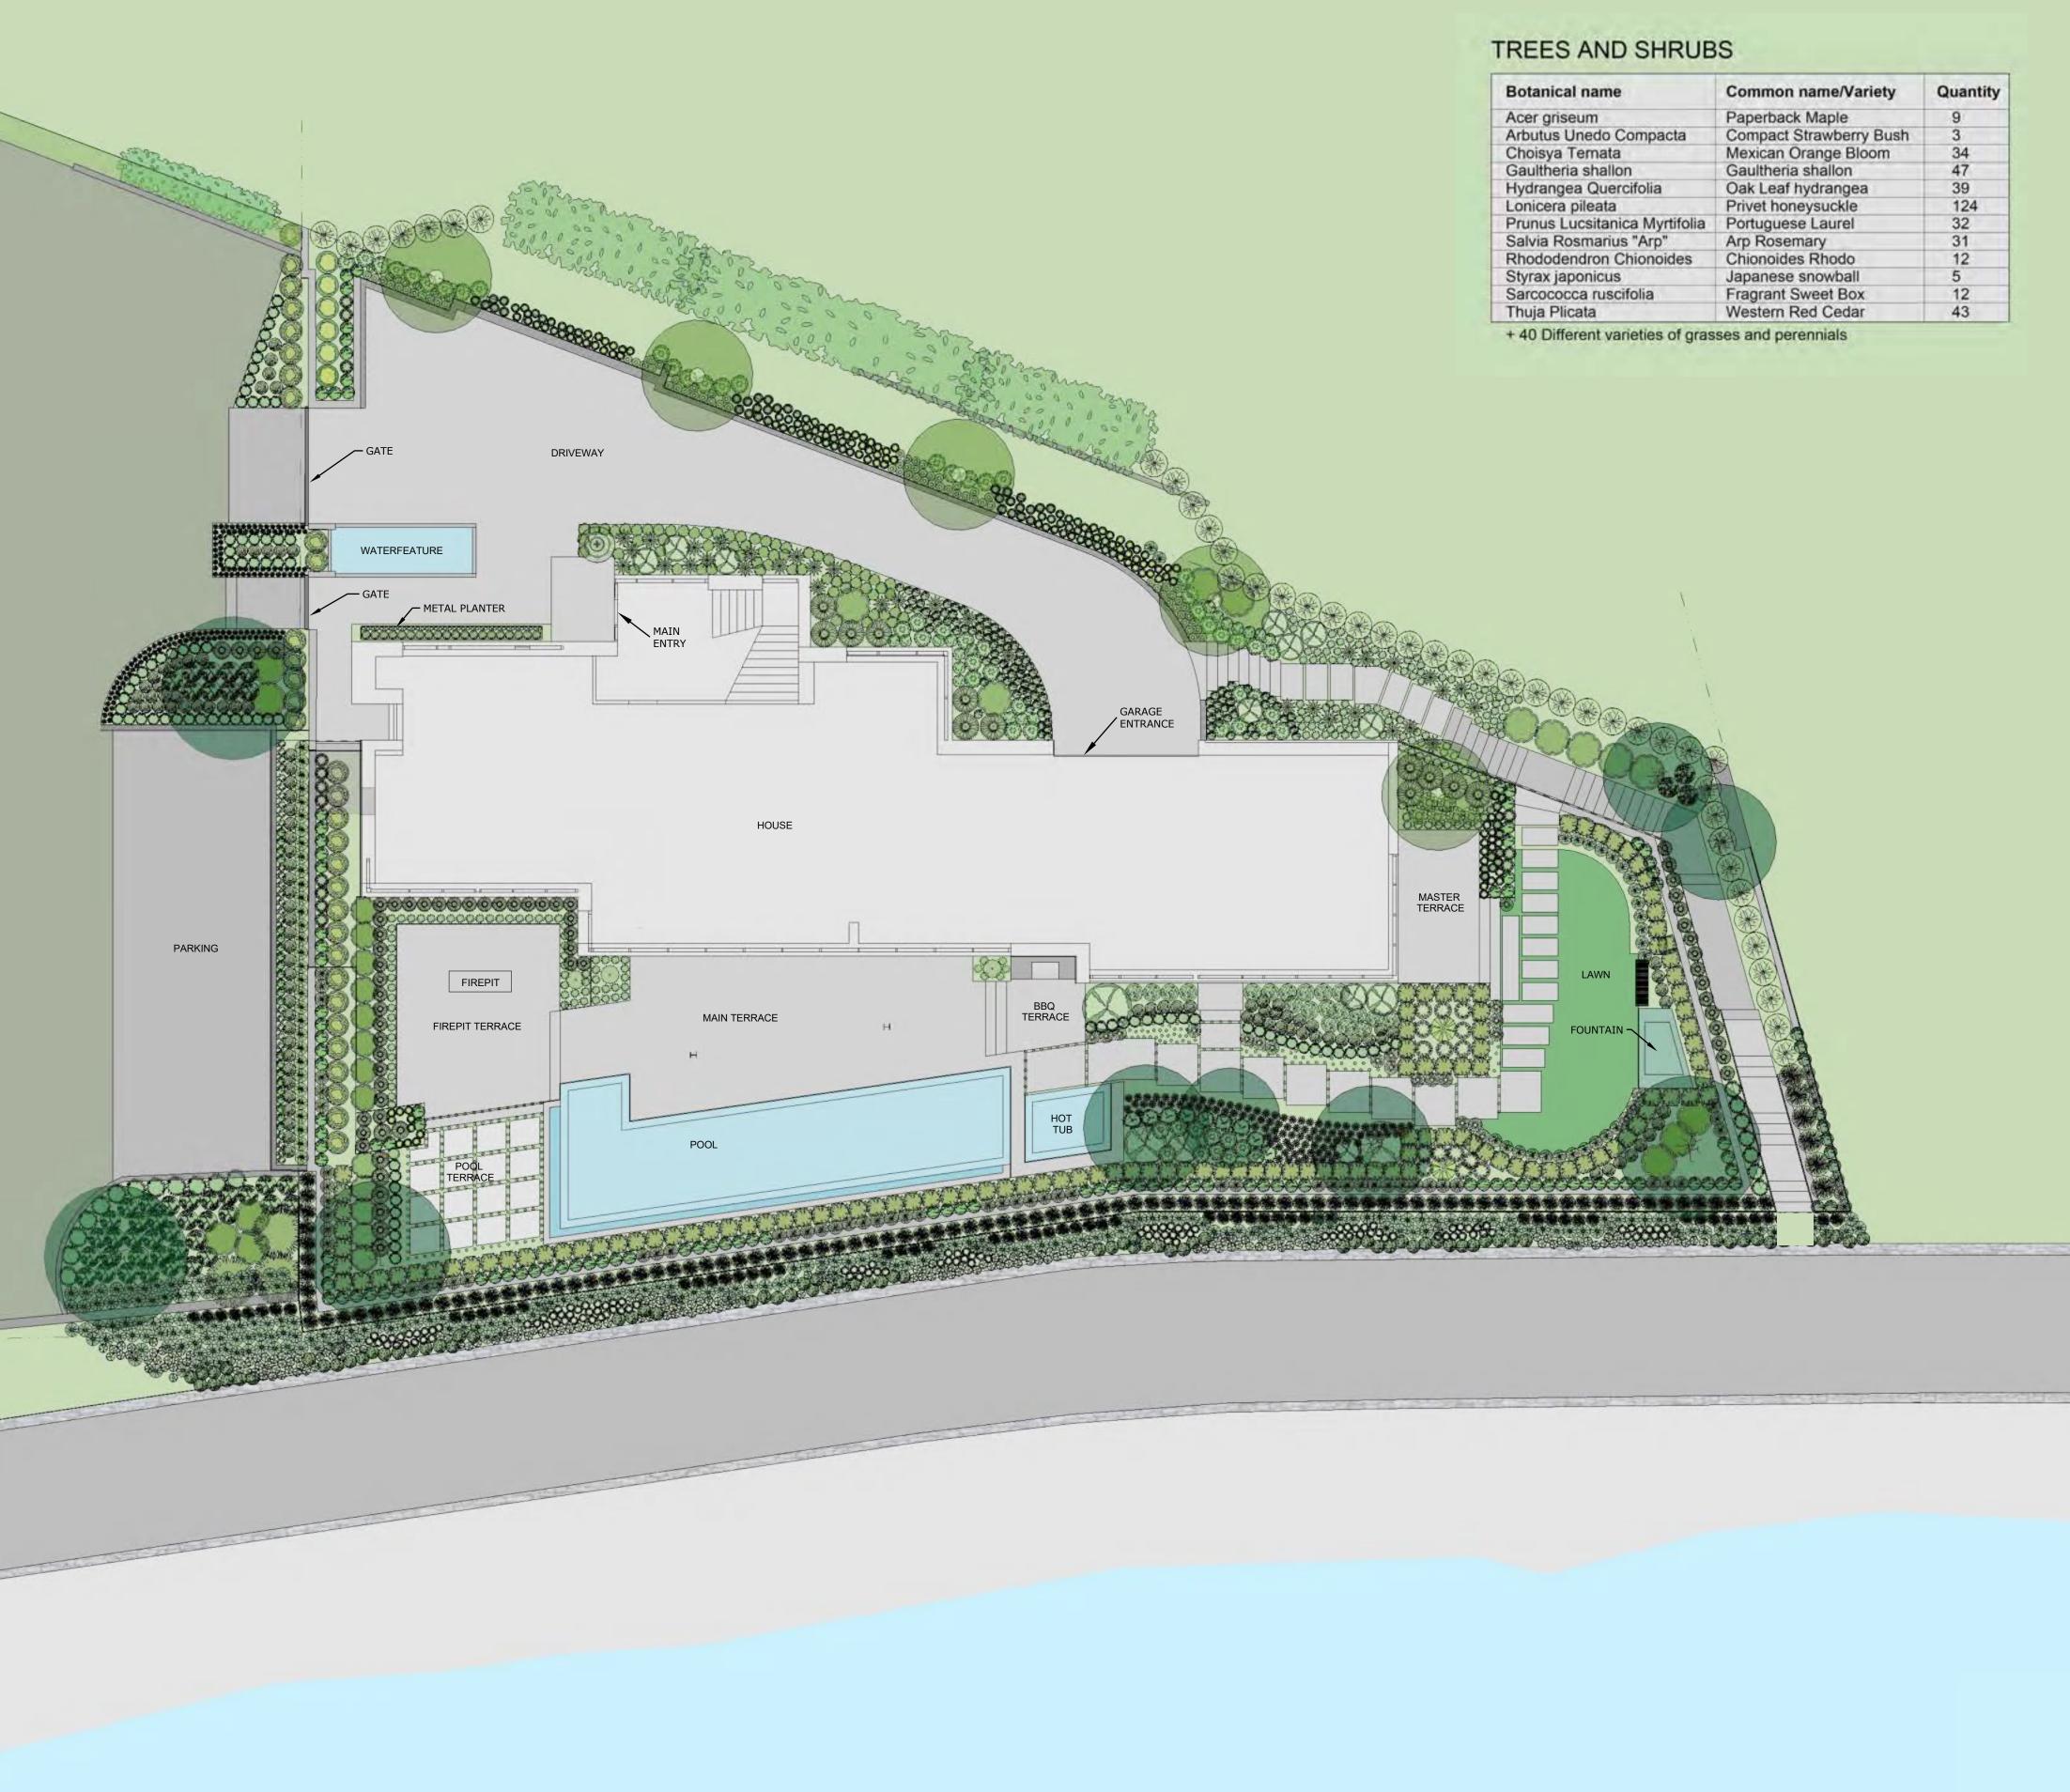








dale@waterformdesign.ca



PROJECT: 2368 Bellevue WEST VANCOUVER, BC DRAWING NAME : CONCEPT PLAN DRAWING DATE: June 19, 2023 SCALE1 1" = 10'


Botanical name	Common name/Variety	Quantity
Acer griseum	Paperback Maple	9
Arbutus Unedo Compacta	Compact Strawberry Bush	3
Choisya Ternata	Mexican Orange Bloom	34
Gaultheria shallon	Gaultheria shallon	47
Hydrangea Quercifolia	Oak Leaf hydrangea	39
Lonicera pileata	Privet honeysuckle	124
Prunus Lucsitanica Myrtifolia	Portuguese Laurel	32
Salvia Rosmarius "Arp"	Arp Rosemary	31
Rhododendron Chionoides	Chionoides Rhodo	12
Styrax japonicus	Japanese snowball	5
Sarcococca ruscifolia	Fragrant Sweet Box	12
Thuja Plicata	Western Red Cedar	43



SHEET: L1.0




RISING GLOBAL SEA LEVEL - 2368 BELLEVUE

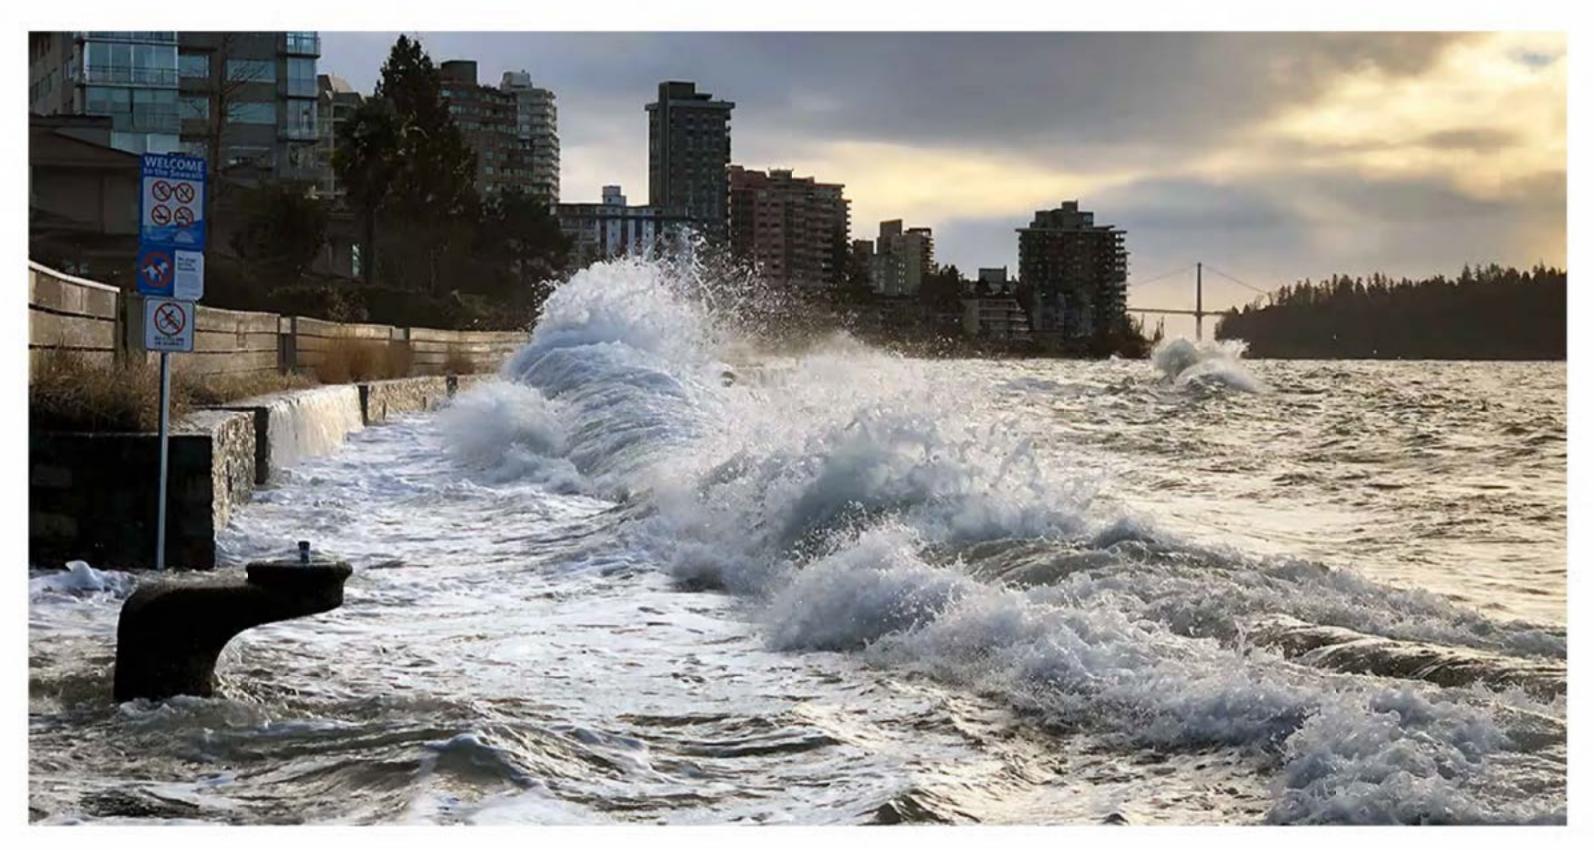

DUE TO GLOBAL WARMING, SEA LEVEL IS CONTINUOUSLY RISING CAUSING MORE FREQUENT EXTREME HIGH WATER EVENTS AND FLOODING

2368 BELLEVUE

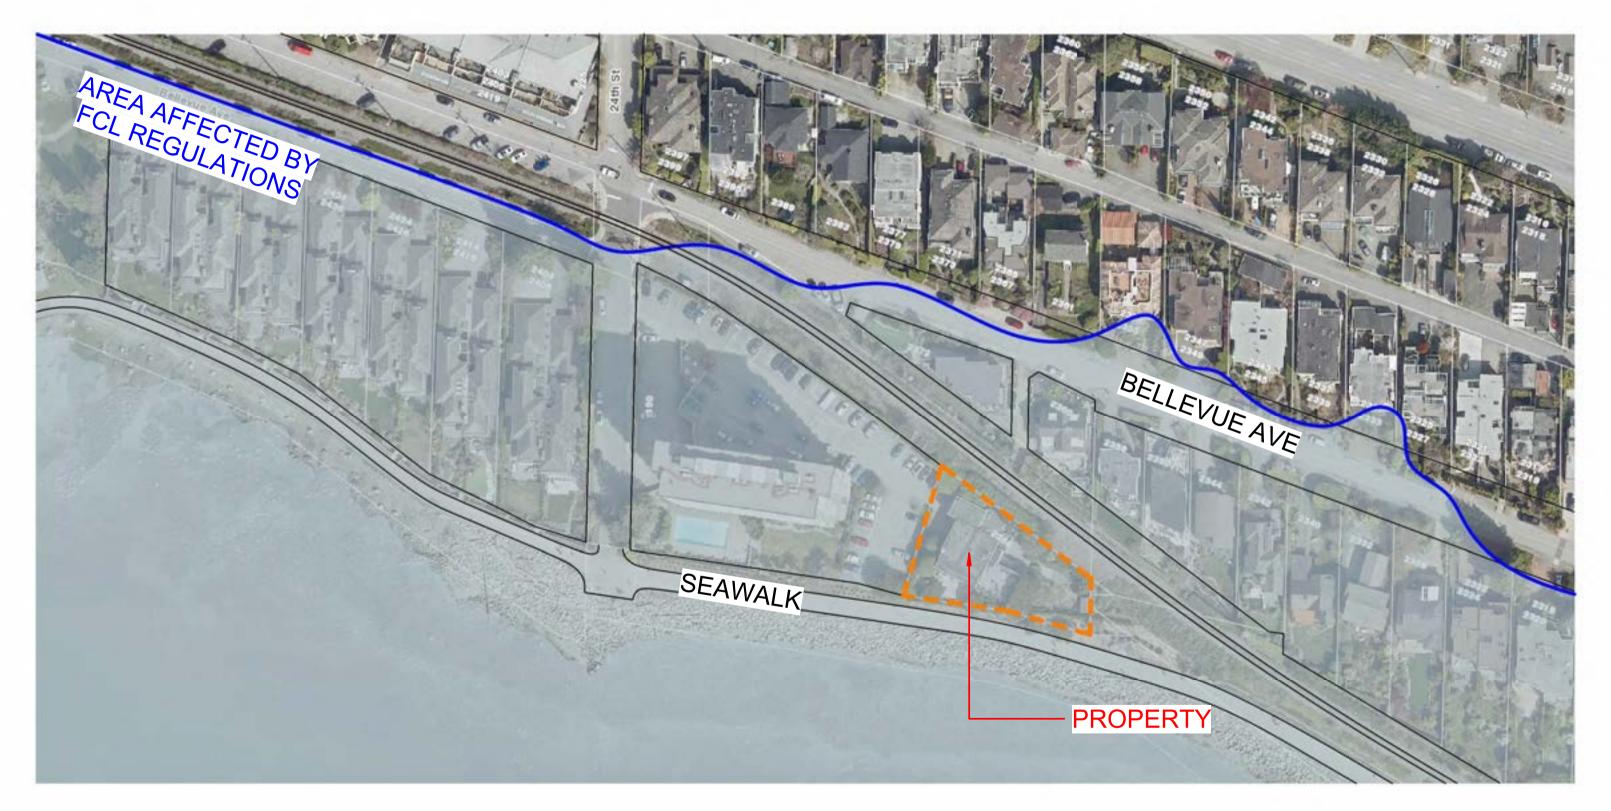


THIS PLAN ILLUSTRATES THAT 2368 BELLEVUE AND ITS ADJACENT NEIGHBOURS ARE VULNERABLE TO FLOODING AND THEREFORE SUBJECT TO WEST VANCOUVER FLOOD CONSTRUCTION LEVEL REGULATIONS

DECEMBER 27, 2022 HIGH TIDE FLOODING (NO STORM SURGE, NO WAVES)



THIS PHOTO ILLUSTRATES MAJOR FLOODING ON DECEMBER 27, 2022 (HIGH TIDE 16.4FT)

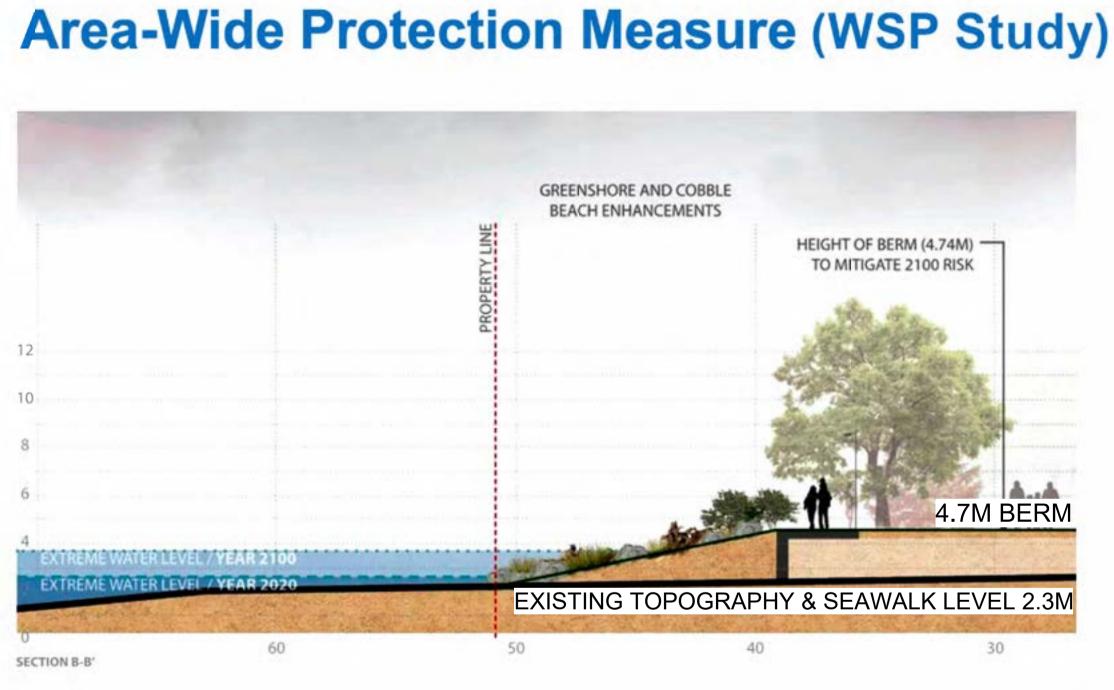


COASTAL PLANNING AND DEVELOPMENT OF FORESHORE DPA




AS PART OF THEIR STUDY, WSP COASTAL ENGINEERS MADE SEVERAL RECOMMENDATIONS INCLUDING HOW TO PROTECT RESIDENCIAL PROPERTIES AND PUBLIC PROPERTIES. THEY RECOMMENDED CREATING A BERM TO PROVIDE A SEAWALK LEVEL OF 4.7M WHICH IS APPROX 2.4M HIGHER THAN THE

CURRENT SEAWALK THAT IS SUBJECT TO FLOODING

FLOOD CONSTRUCTION LEVEL CALCULATION

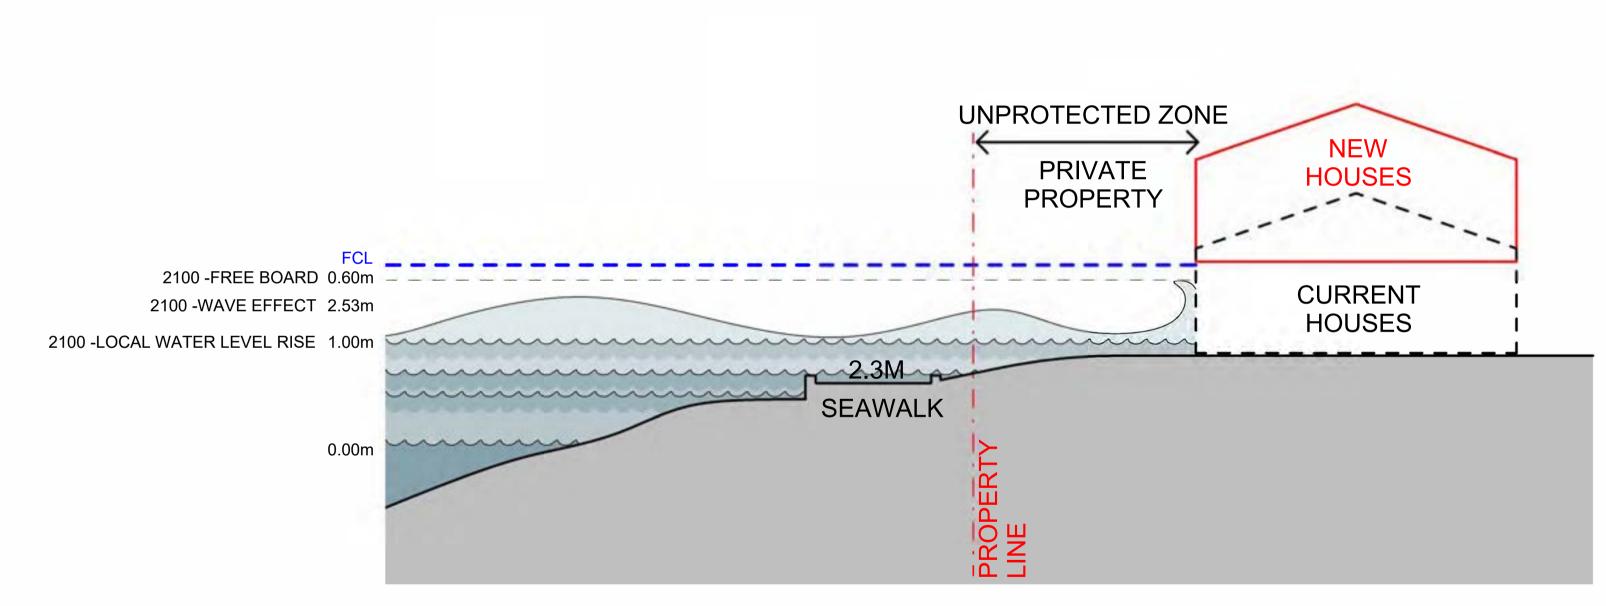


THE WSP ENGINEERING STUDY CALCULATED FLOOD CONSTRUCTION LEVELS ALONG THE WEST VANCOUVER FORESHORE REQUIRING NEW HOUSES TO BE CONSTRUCTED AT A MUCH HIGHER ELEVATION

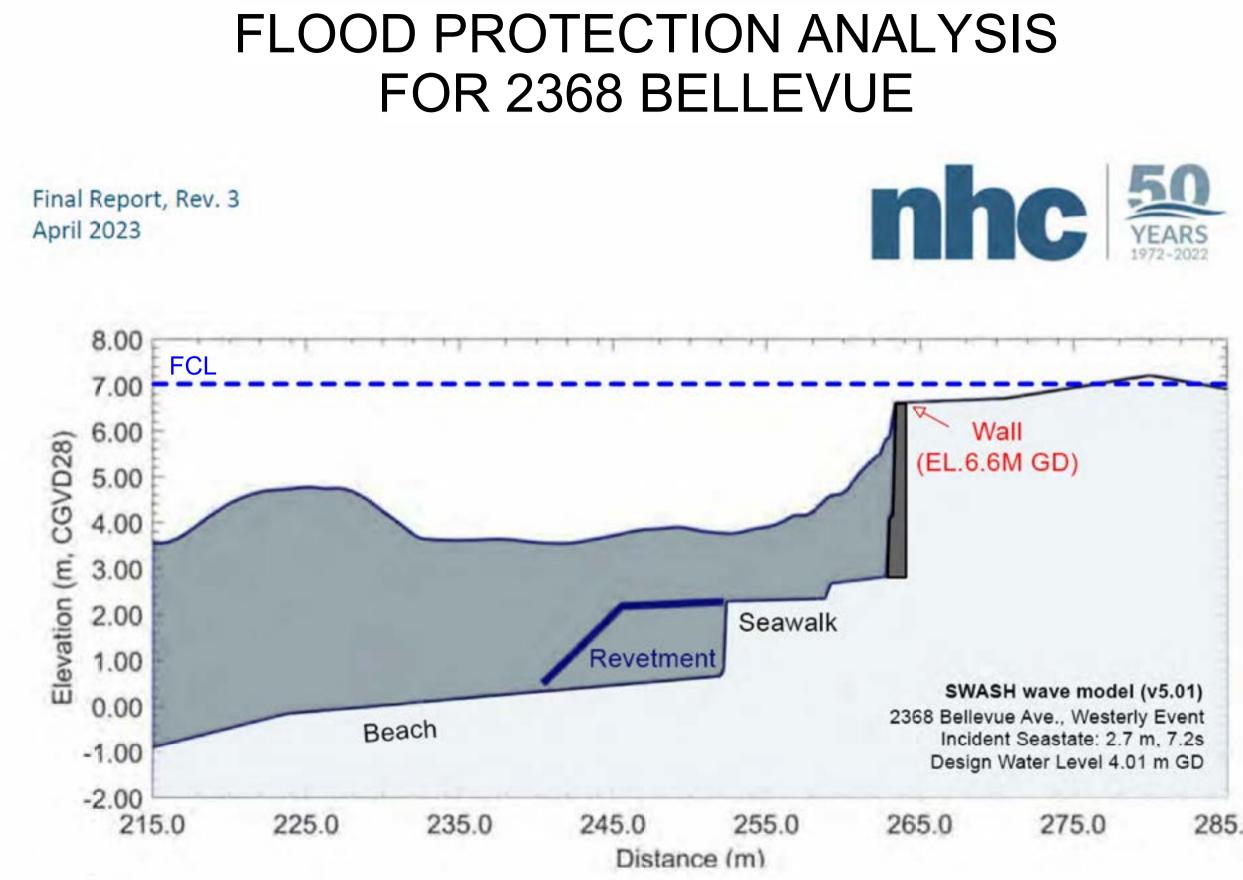


COASTAL ENGINEER DETERMINES THAT AN FCL OF 7.01M AND FLOOD PROTECTION WALL ELEVATION OF 6.6M IS REQUIRED TO PROVIDE FLOOD PROTECTION TO 2368 BELLEVUE

285.0

FLOOD PROTECTION WALL

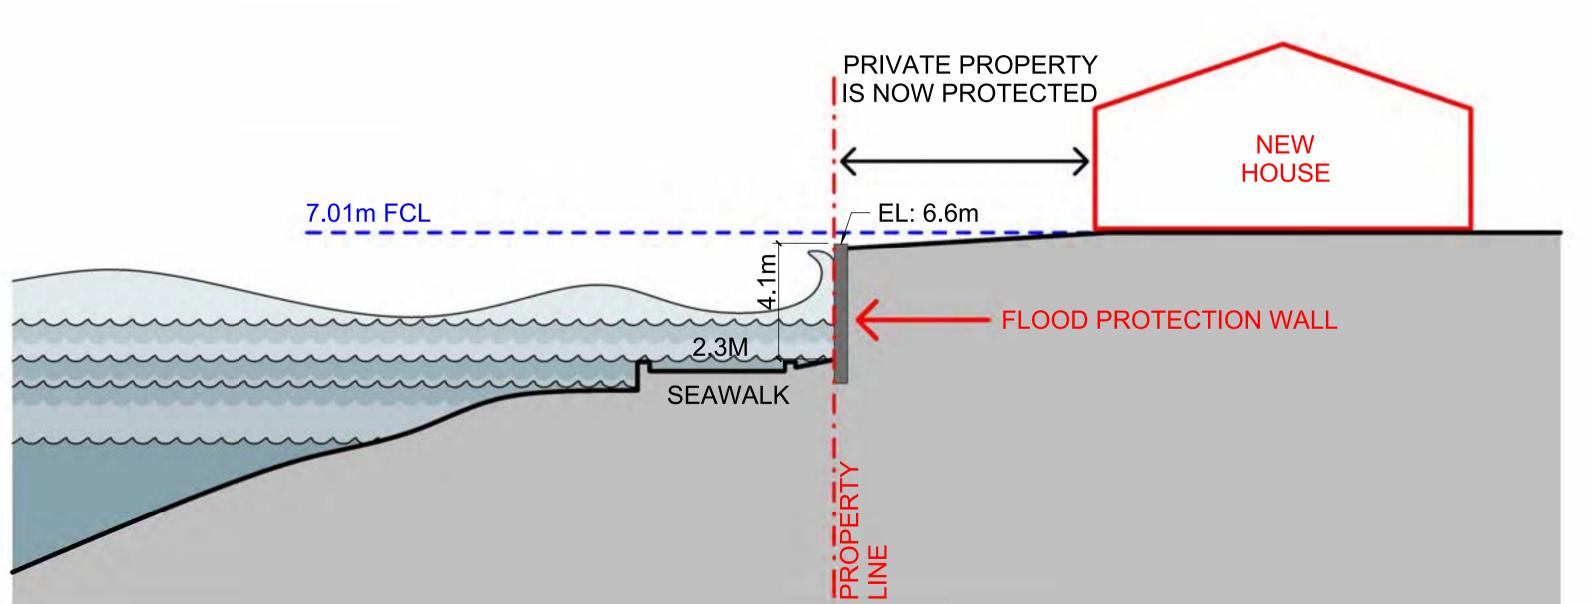


THE FLOOD PROTECTION WALL ADJACENT TO EXISTING SEAWALK **PROVIDES FLOOD PROTECTION**

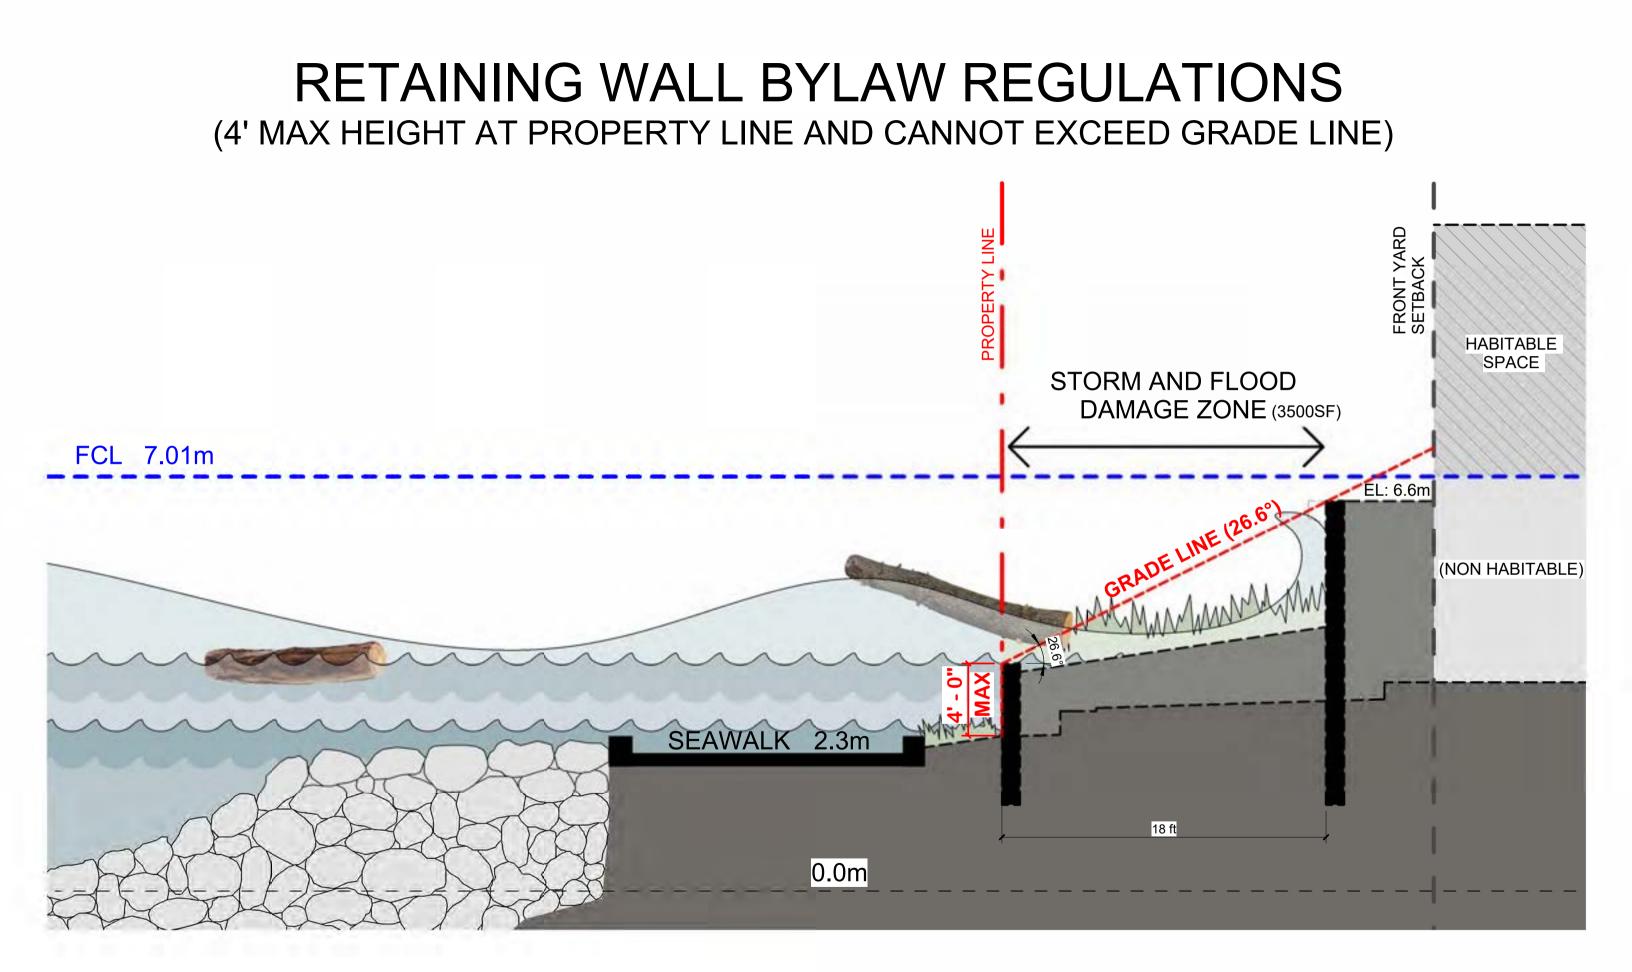


WHEN APPLYING THE CURRENT BYLAW FOR RETAINING WALLS TO FORESHORE PROPERTIES, LARGE AREAS BELOW THE FLOOD LEVEL ARE UNPROTECTED

STORM AND FLOOD DAMAGE / RISK AND LIABILITY

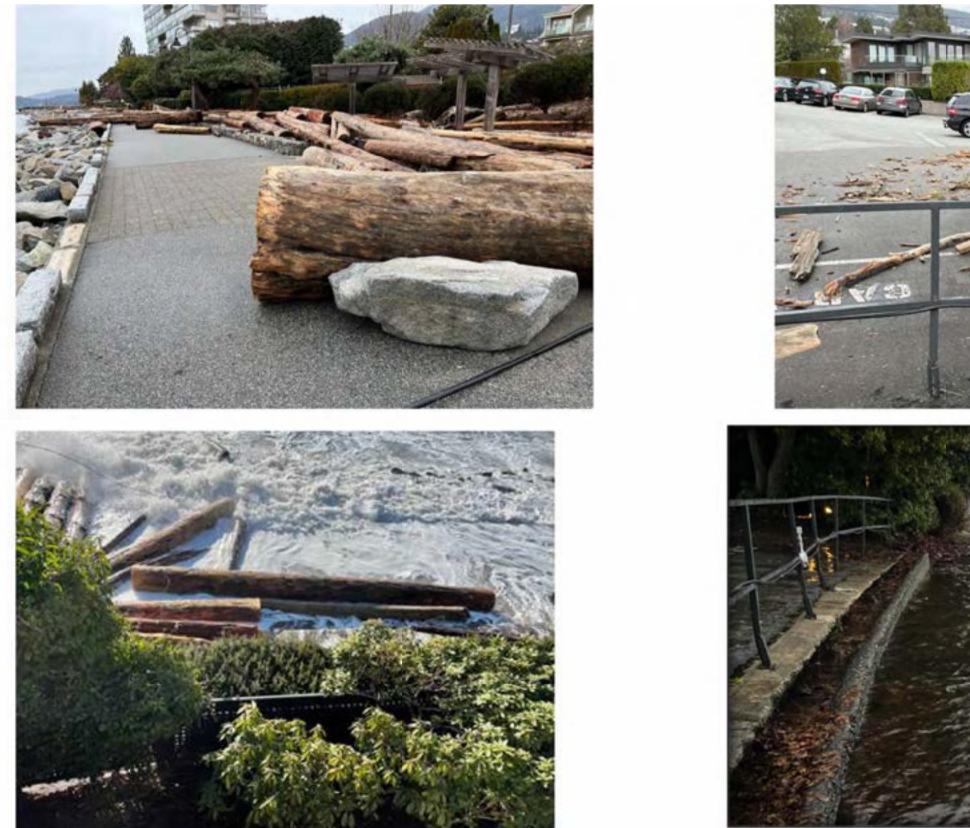

DAMAGE AFTER STORMS EXPECTED TO GET WORSE AS SEA LEVEL CONTINUES TO RISE YEAR AFTER YEAR RECURRING HIGH WATER EVENTS AND STORMS WILL CREATE SIGNIFICANT DAMAGE AND PUBLIC SAFETY RISKS. THE ABUNDANCE OF LOGS PRESENT A REAL RISK!



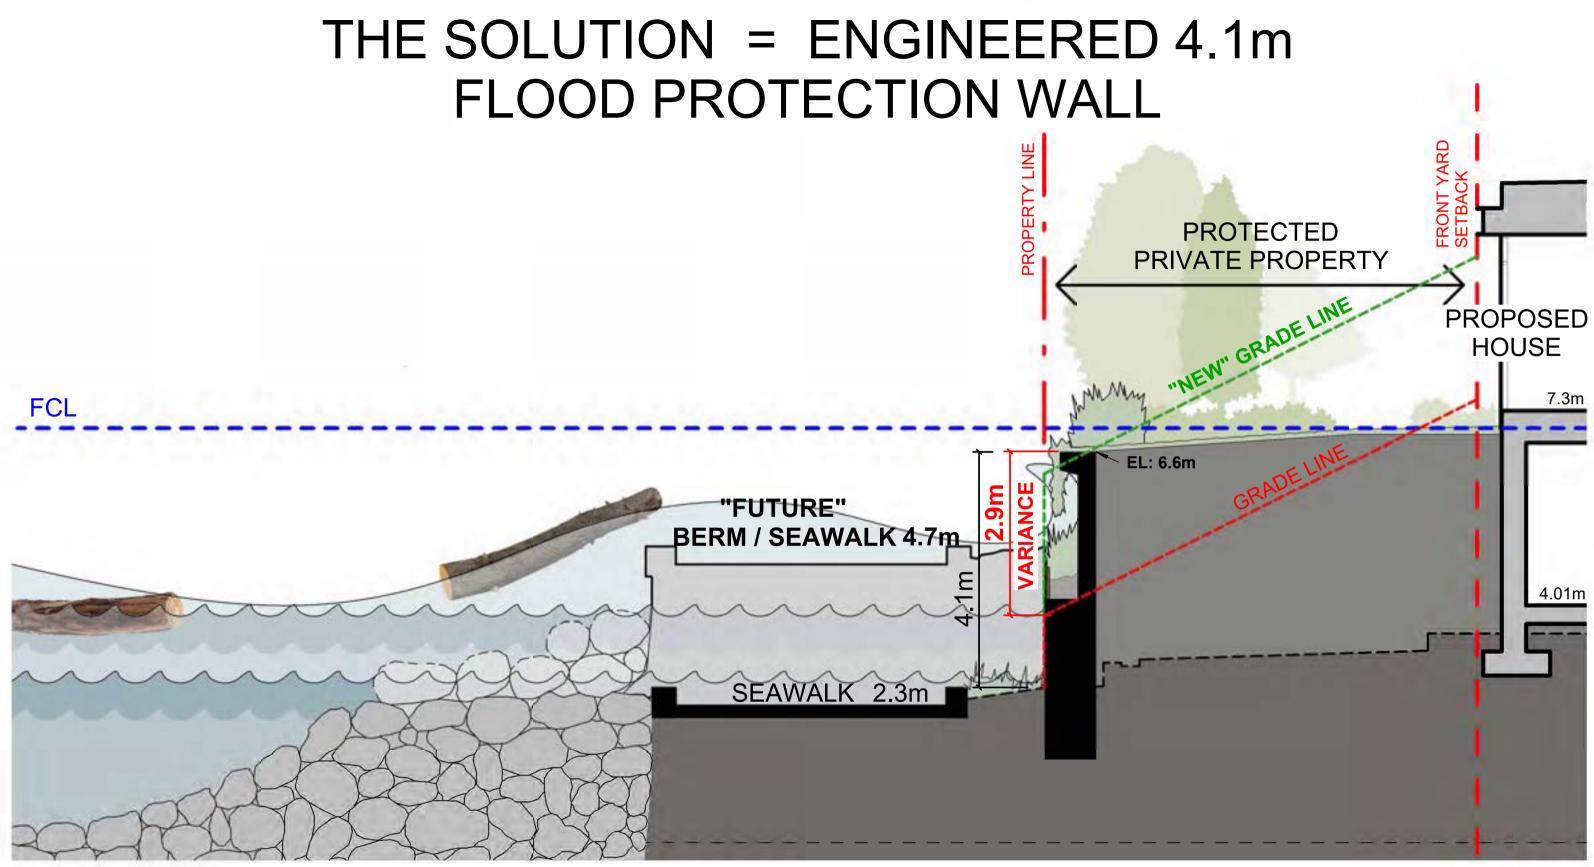

THE ENGINEERED FLOOD PROTECTION WALL THAT COMPLIES WITH WEST VANCOUVER FCL BY-LAWS REQUIRES A RETAINING WALL HEIGHT VARIANCE. IF WSP COASTAL ENGINEERING RECOMMENDATIONS FOR THE FUTURE SEAWALK WERE ALREADY IN PLACE, A RETAINING WALL HEIGHT VARIANCE WOULD NOT BE REQUIRED

PROPOSED FLOOD PROTECTION WALL



THE PROPOSED FLOOD PROTECTION WALL (RETAINING WALL) IS DESIGNED TO INCORPORATE LANDSCAPING AND CREATE A SAFE PEDESTRIAN EXPERIENCE



NOTES:


CONCRETE PUMPING AND EXCAVATOR LOADING AREA.

2 NO PARKING WHEN CONCRETE PUMPING AND EXCAVATOR LOADING IN PROCESS.

FIRE TRUCKS, DUMP TRUCKS AND EXCAVATOR ROUTE.

(4) EXISTING ON-STREET PARKING.

6 ACCESS ROUTE FOR ALL CONSTRUCTION VEHICLES.

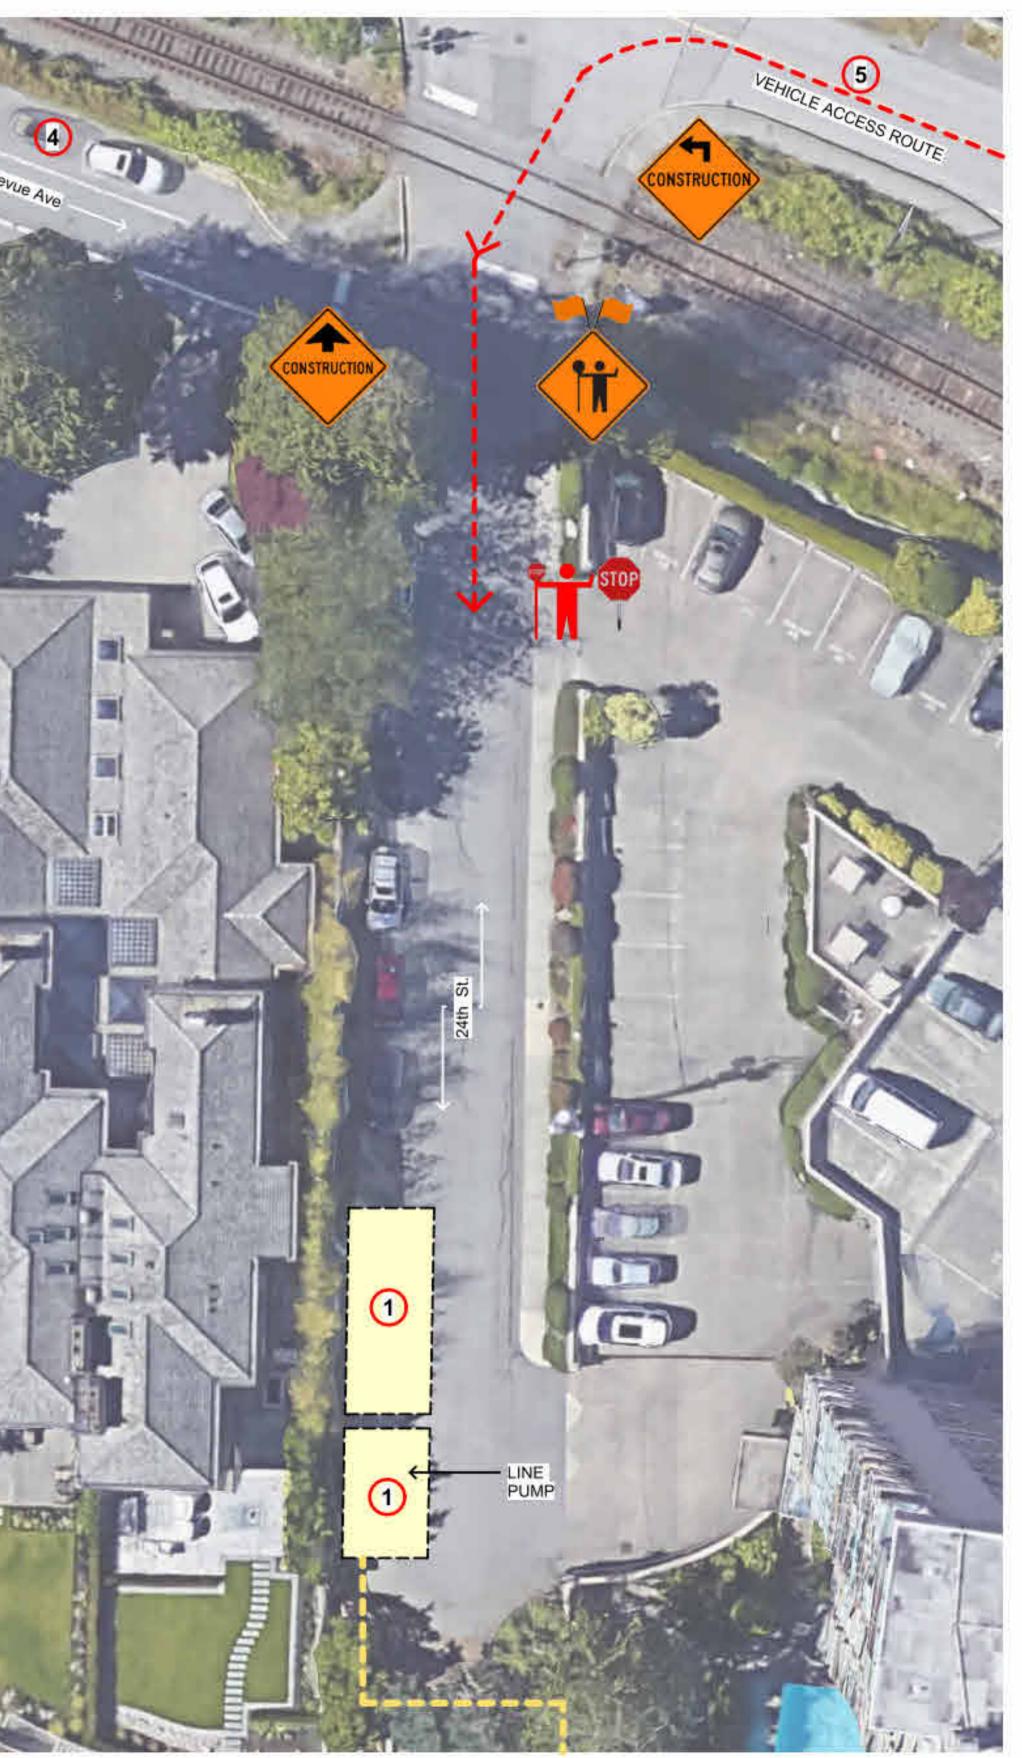

CONSTRUCTION SITE ACCESS / TRAFFIC PLAN

Contact Information

Applicant's Contact Information

Feenstra Architecture Inc. / Ted Feenstra / 604 739-8888 / ted@feenstra.ca Link to comment form for public input: www.2368bellevueinformation.ca Email address for comment form for public input: ted@feenstra.ca

West Vancouver Planning Contract Information

To ask questions or provide comments to the District, please contact the File Planner: Hanna Demyk / hdemyk@westvancouver.ca / 604 913-2750