

District of West Vancouver

Heritage Alteration Permit No. 19-097

CURRENT OWNERS: JODI HORN

THIS HERITAGE ALTERATION PERMIT APPLIES TO:

CIVIC ADDRESS: 4841 The Dale

LEGAL DESCRIPTION: PID No. 015-048-829

LOT 17 BLOCK 1 DISTRICT LOT 811 PLAN 967

(the 'LANDS')

1. This Heritage Alteration Permit:

- imposes requirements and conditions for the development of the Lands, which are designated by the Official Community Plan as Lower Caulfeild Heritage Conservation Area to provide for the protection of the special heritage character of the Lower Caulfeild Area and subject to Guidelines HE6 specified in the Official Community Plan;
- (b) is issued subject to the Owner's compliance with all of the Bylaws of the District applicable to the Lands, except as varied or supplemented by this Permit; and
- (c) allows for construction of a new single-family dwelling on the Lands.
- 2. The following requirements and conditions shall apply to the Lands:
 - 2.1 Buildings, structures, on-site parking, driveways and site development shall take place in accordance with the attached Schedule A.
 - 2.2 On-site and off-site landscaping shall be installed at the cost of the Owner in accordance with the attached Schedule B.
 - 2.3 For clarity:
 - (i) This Heritage Alteration Permit allows a 3.1 m (10.2 ft.) front yard setback variance for the single-family dwelling as outlined in Schedule A from 9.1 m (29.9 ft.) to 6 m (19.7 ft.);
 - (ii) This Heritage Alteration Permit allows for removal of trees in the west 'side yard' and south 'front yard' setback;
 - (iii) Any other tree removal on-site or within the boulevard must be compliant with Tree Bylaw No. 4892, 2016; and
 - (iv) All tree removal on site shall commence under the supervision of a professional arborist at the sole cost of the property owners.
 - 2.4 Sprinklers must be installed in all areas as required under the Fire Protection and Emergency Response Bylaw No. 4366, 2004.
 - 2.5 All balconies, decks and patios are to remain fully open and unenclosed in compliance with Schedule A.

Page: 2 HAP No. 19-097

3. Prior to commencing site work or Building Permit issuance, whichever occurs first, the Owner must:

- 3.1 Install protective tree fencing, in compliance with Tree Bylaw No. 4892, 2016, along the entire western property line adjacent to the unopened municipal road to the satisfaction of the District's Environmental Protection Officer.
- 3.2 Install protective tree fencing, in compliance with Tree Bylaw No. 4892, 2016, along the entire eastern property line to the satisfaction of the District's Environmental Protection Officer.
- 3.3 Provide and implement a plan for traffic management during construction, to the satisfaction of the District's Manager of Land Development.
- 3.4 Submit a "Sediment and Erosion Plan" to the District's Environmental Protection Officer for approval, and the owner shall be responsible for maintaining, repairing and implementing the sediment control measures.
- 3.5 Submit a letter from a qualified professional regarding the amount of rock removal required to allow for the development permitted through this Heritage Alteration Permit, to the satisfaction of the District's Manager of Land Development.
- 4. Prior to Building Permit issuance, the following must be provided:
 - 4.1 Engineering civil drawings detailing works, including but not limited to: (a) storm water management measures; (b) site service connections; and (c) any boulevard works along the frontage of the site, must be submitted for acceptance, and security provided for the due and proper completion of the engineering works, all to the satisfaction of the District's Manager of Land Development.
 - 4.2 A landscape cost estimate, for the landscape works outlined in Schedule B, to the Director of Planning and Development Services (or designate).
 - 4.3 A Landscaping Deposit, for the monetary amount determined in section 4.2 of this Heritage Alteration Permit, shall be provided to the District in the form of cash or an unconditional, irrevocable auto-renewing letter of credit issued by a Canadian chartered bank or credit union and:
 - (a) a minimum 20% of the initial value of the Landscaping Deposit shall be retained by the District for one year after installation of the landscaping, as a warranty deposit to ensure successful installation of the landscaping; and
 - (b) the initial value of the Landscaping Deposit may only be reduced to the warranty level and the warranty shall only be released when the registered member of the BSCLA for the project provides a field report to the District confirming successful installation of the on-site landscaping in accordance with Schedule B to this Heritage Alteration Permit.
 - 4.4 Plans indicating the location and measures to buffer all mechanical equipment must be submitted to the Director of Planning and Development Services (or designate).

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5. This Heritage Alteration Permit lapses if the work authorized herein is not commenced within 24 months of the date this permit is issued.

THE DIRECTOR OF PLANNING AND DEVELOPMENT SERVICES APPROVED THIS HERITAGE ALTERATION PERMIT OMNOVEMBER 29, 2021.

DIRECTOR OF PLANNING AND DEVELOPMENT SERVICES

THE REQUIREMENTS AND CONDITIONS UPON WHICH THIS PERMIT IS ISSUED ARE ACKNOWLEDGED AND AGREED TO BY THE CURRENT OWNER. IT IS UNDERSTOOD:

- THAT OTHER PERMITS / APPROVALS MAY BE REQUIRED INCLUDING PERMITS / APPROVALS FOR BUILDING CONSTRUCTION, SOIL AND ROCK REMOVAL OR DEPOSIT, AND BOULEVARD WORKS; AND
- THE DEVELOPMENT MUST ATTAIN REQUIREMENTS OF THE BC BUILDING CODE AND ANY VARIANCES TO THE ZONING BYLAW ARE THE RESPONSIBILITY OF THE OWNER AND MUST BE RECTIFED AT THE BUILDING PERMIT STAGE.

FOR THE PURPOSES OF SECTION 5, THIS PERMIT IS ISSUED ON NOVEMBER 29, 2021.

Schedules:

A – Architectural Plans from Alex Voth Design Consulting (dated August 6, 2021).

B – Landscape Plans from Forma Design Inc. (last revision date August 6, 2021).





October 23, 2019 Issued for Lower Caufield Design Panel

June 18, 2021 Issued to Consultants

July 12, 2021 Revisions to Capture Energy

4841 The Dale West Vancouver R (

New Residence

Address: 4841 The Dale, West Vancouver, B.C.

August 6, 2021

A-0.0	Title Sheet - Drawing Legend	-
A-2.0	Site Plan - Calculations	1/8" = 1'-0"
A-3.0	Lower Floor Plan	1/4" = 1'-0"
A-3.1	Main Floor Plan	1/4" = 1'-0"
A-3.1	Upper Floor Plan	1/4" = 1'-0"
A-3.3	Roof Plan	1/4" = 1'-0"
A-3.4	Garage Plans	1/4" = 1'-0"
A-4.0	South Elevation	1/4" = 1'-0"
A-4.1	East Elevation	1/4" = 1'-0"
A-4.2	North Elevation	1/4" = 1'-0"
A-4.3	West Elevation	1/4" = 1'-0"
A-4.4	Garage Elevations	1/4" = 1'-0"
A-5.0	Section	1/4" = 1'-0"
A-5.1	Section	1/4" = 1'-0"
A-5.2	Section	1/4" = 1'-0"
A-5.3	Garage Sections	1/4" = 1'-0"

New Residence 4841 The Dale West Vancouver, British Columbia

Title sheet


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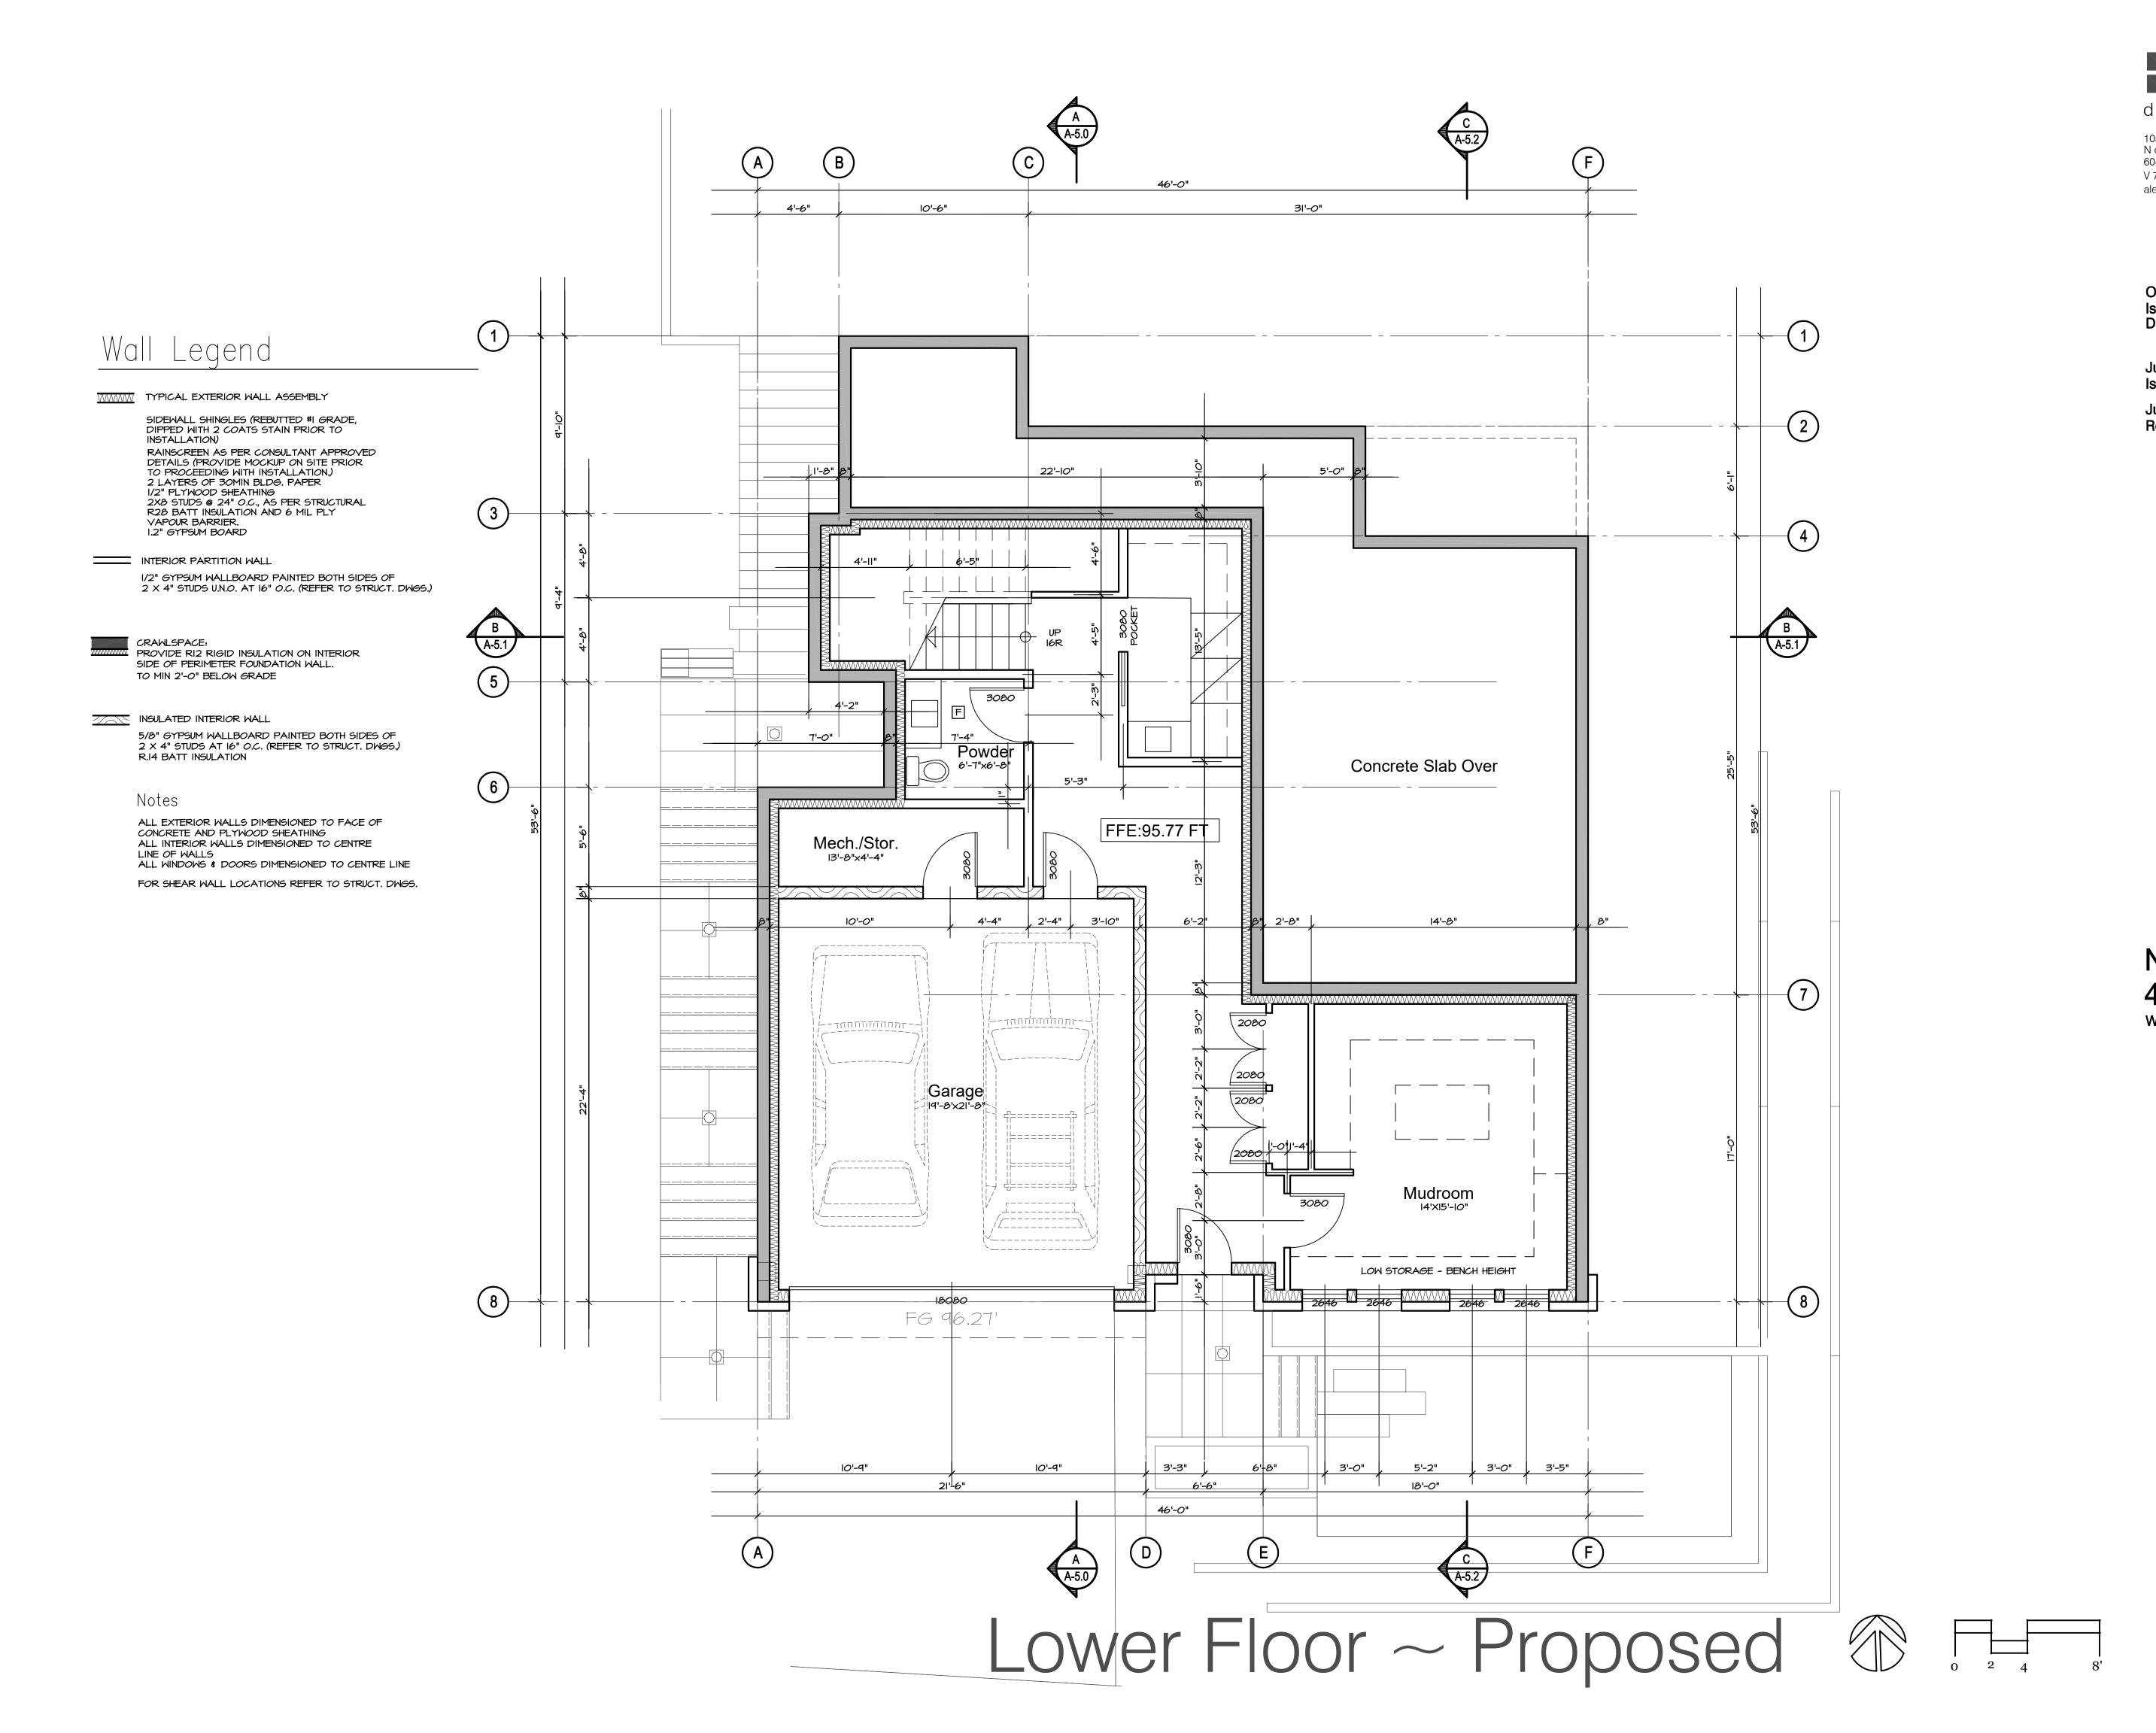
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Checked

Date JULY 12, 2021
Scale 1/4" = 1'-0"

Sheet Number





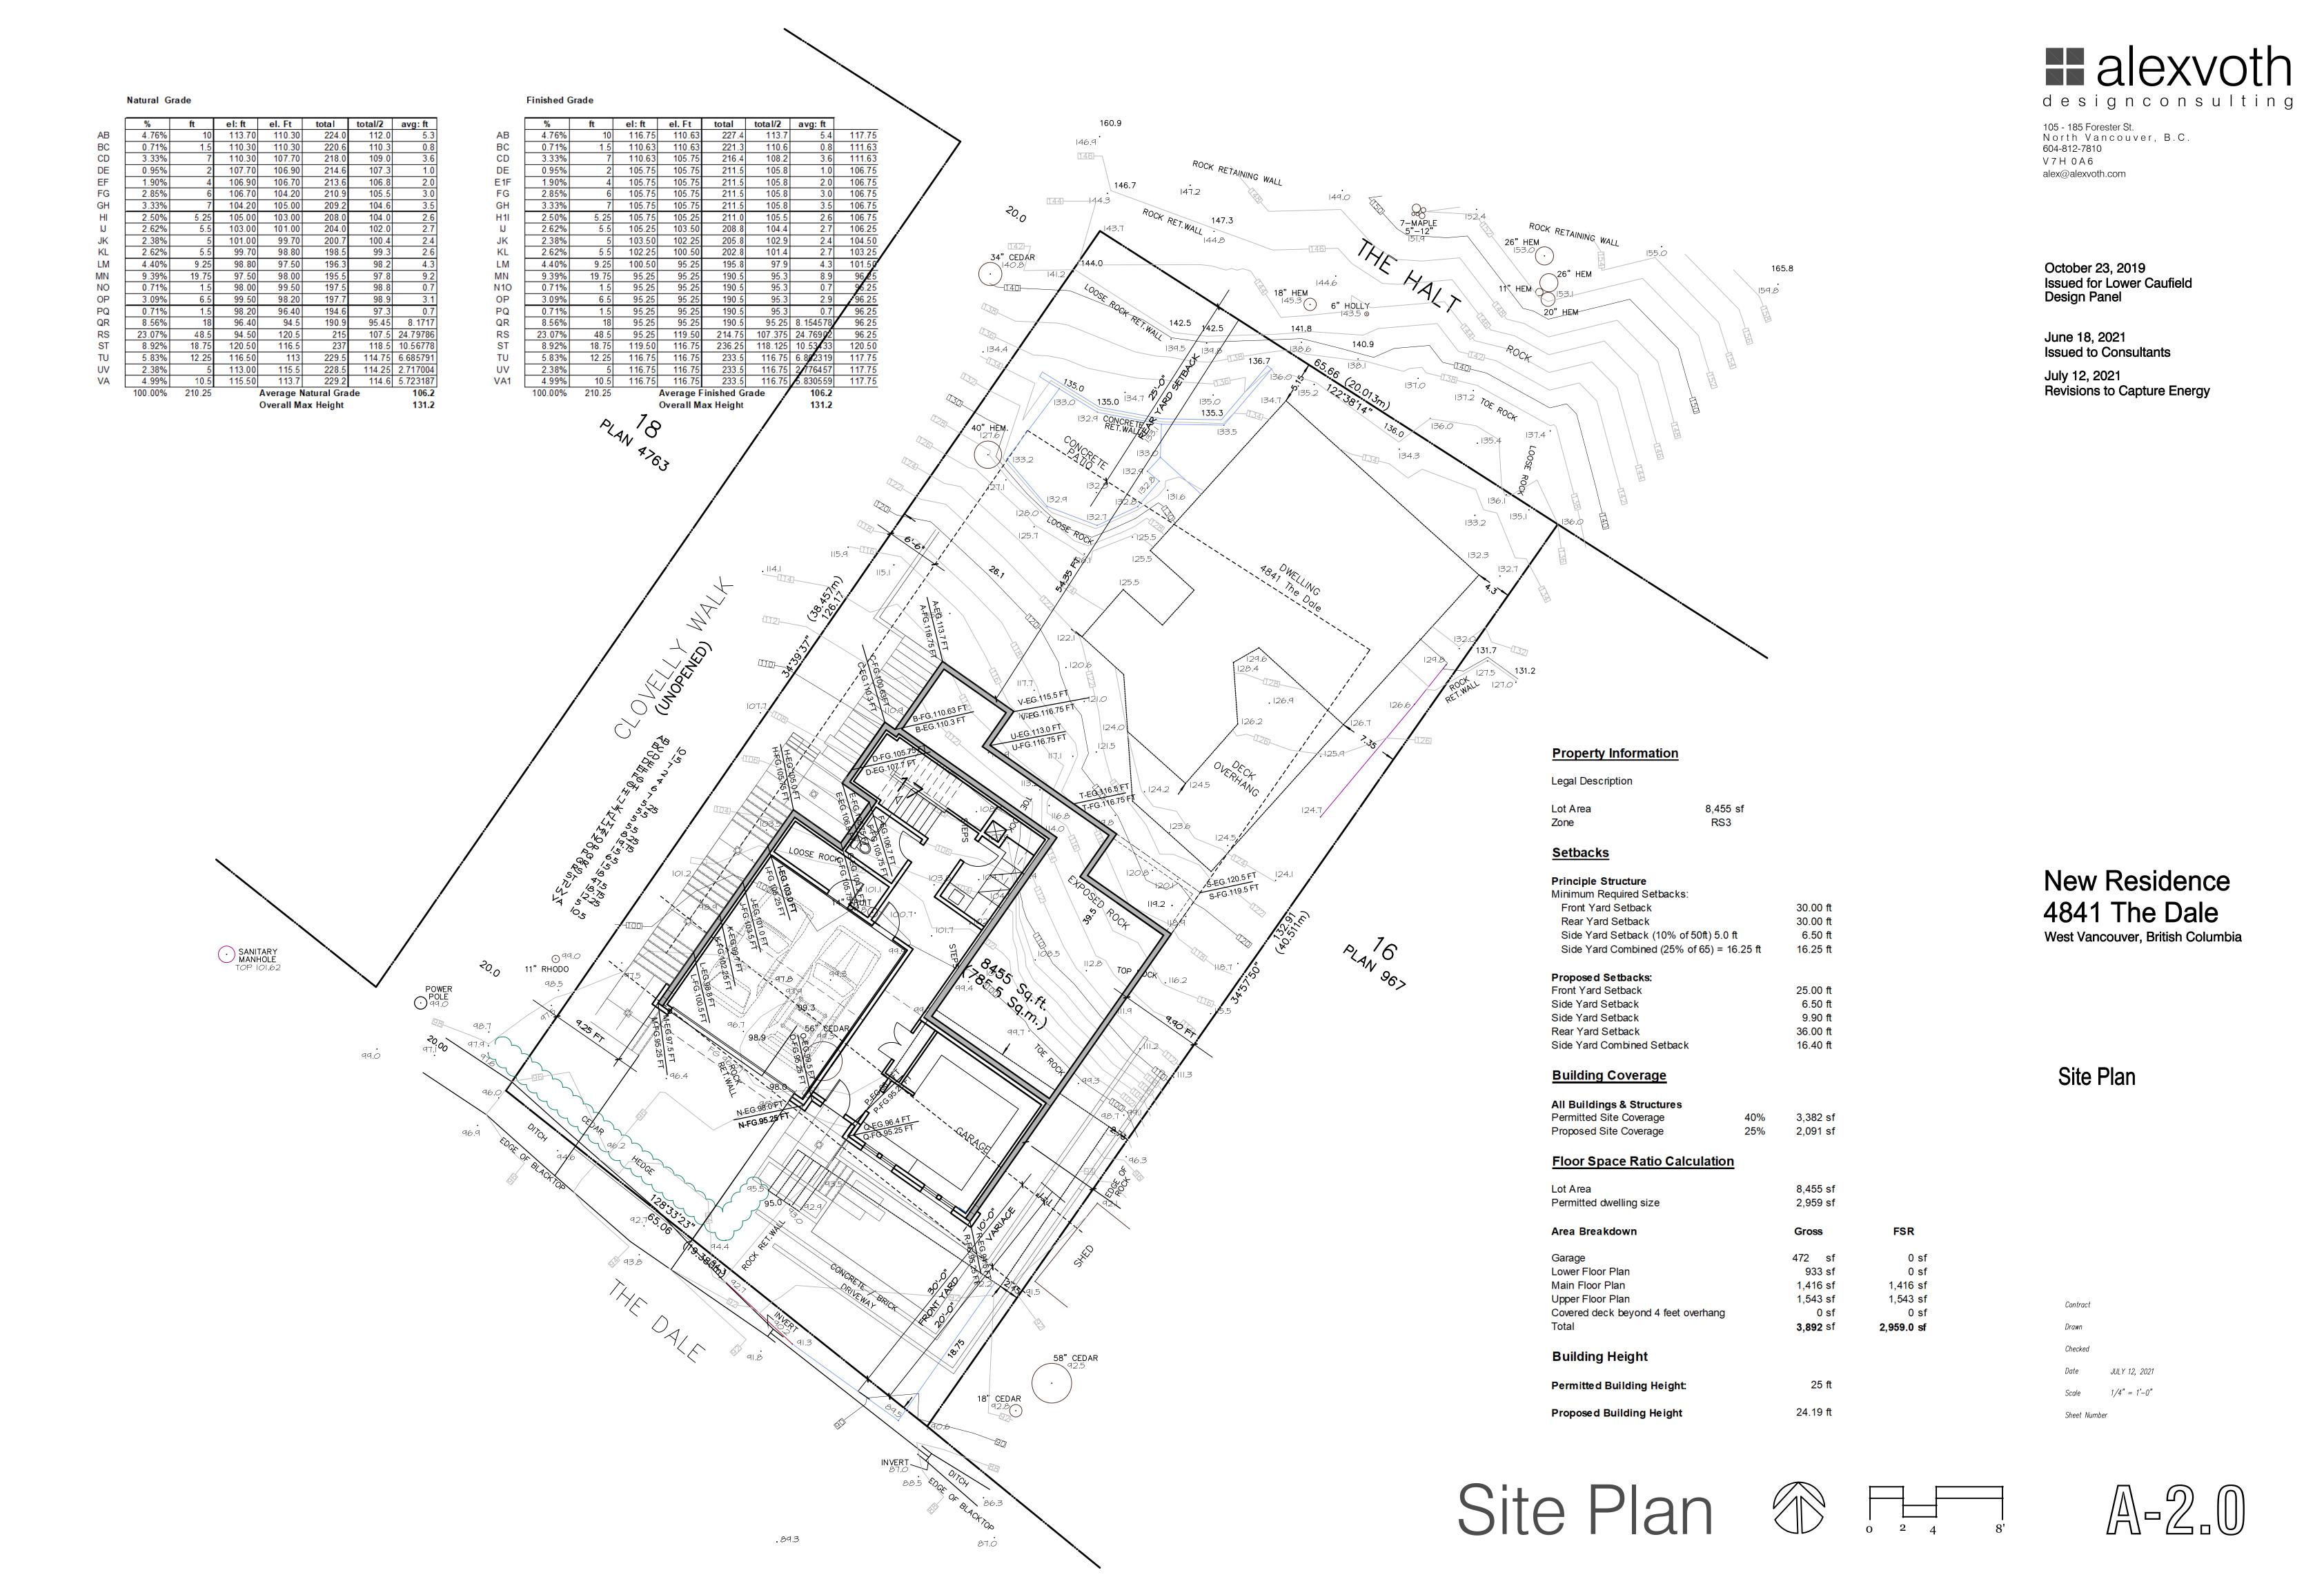

October 23, 2019 Issued for Lower Caufield Design Panel

June 18, 2021 Issued to Consultants July 12, 2021 Revisions to Capture Energy

New Residence 4841 The Dale West Vancouver, British Columbia

Lower Floor

Contract


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Checked

Date JULY 12,

Sheet Number

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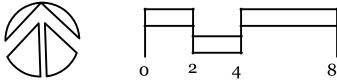


October 23, 2019 Issued for Lower Caufield **Design Panel**

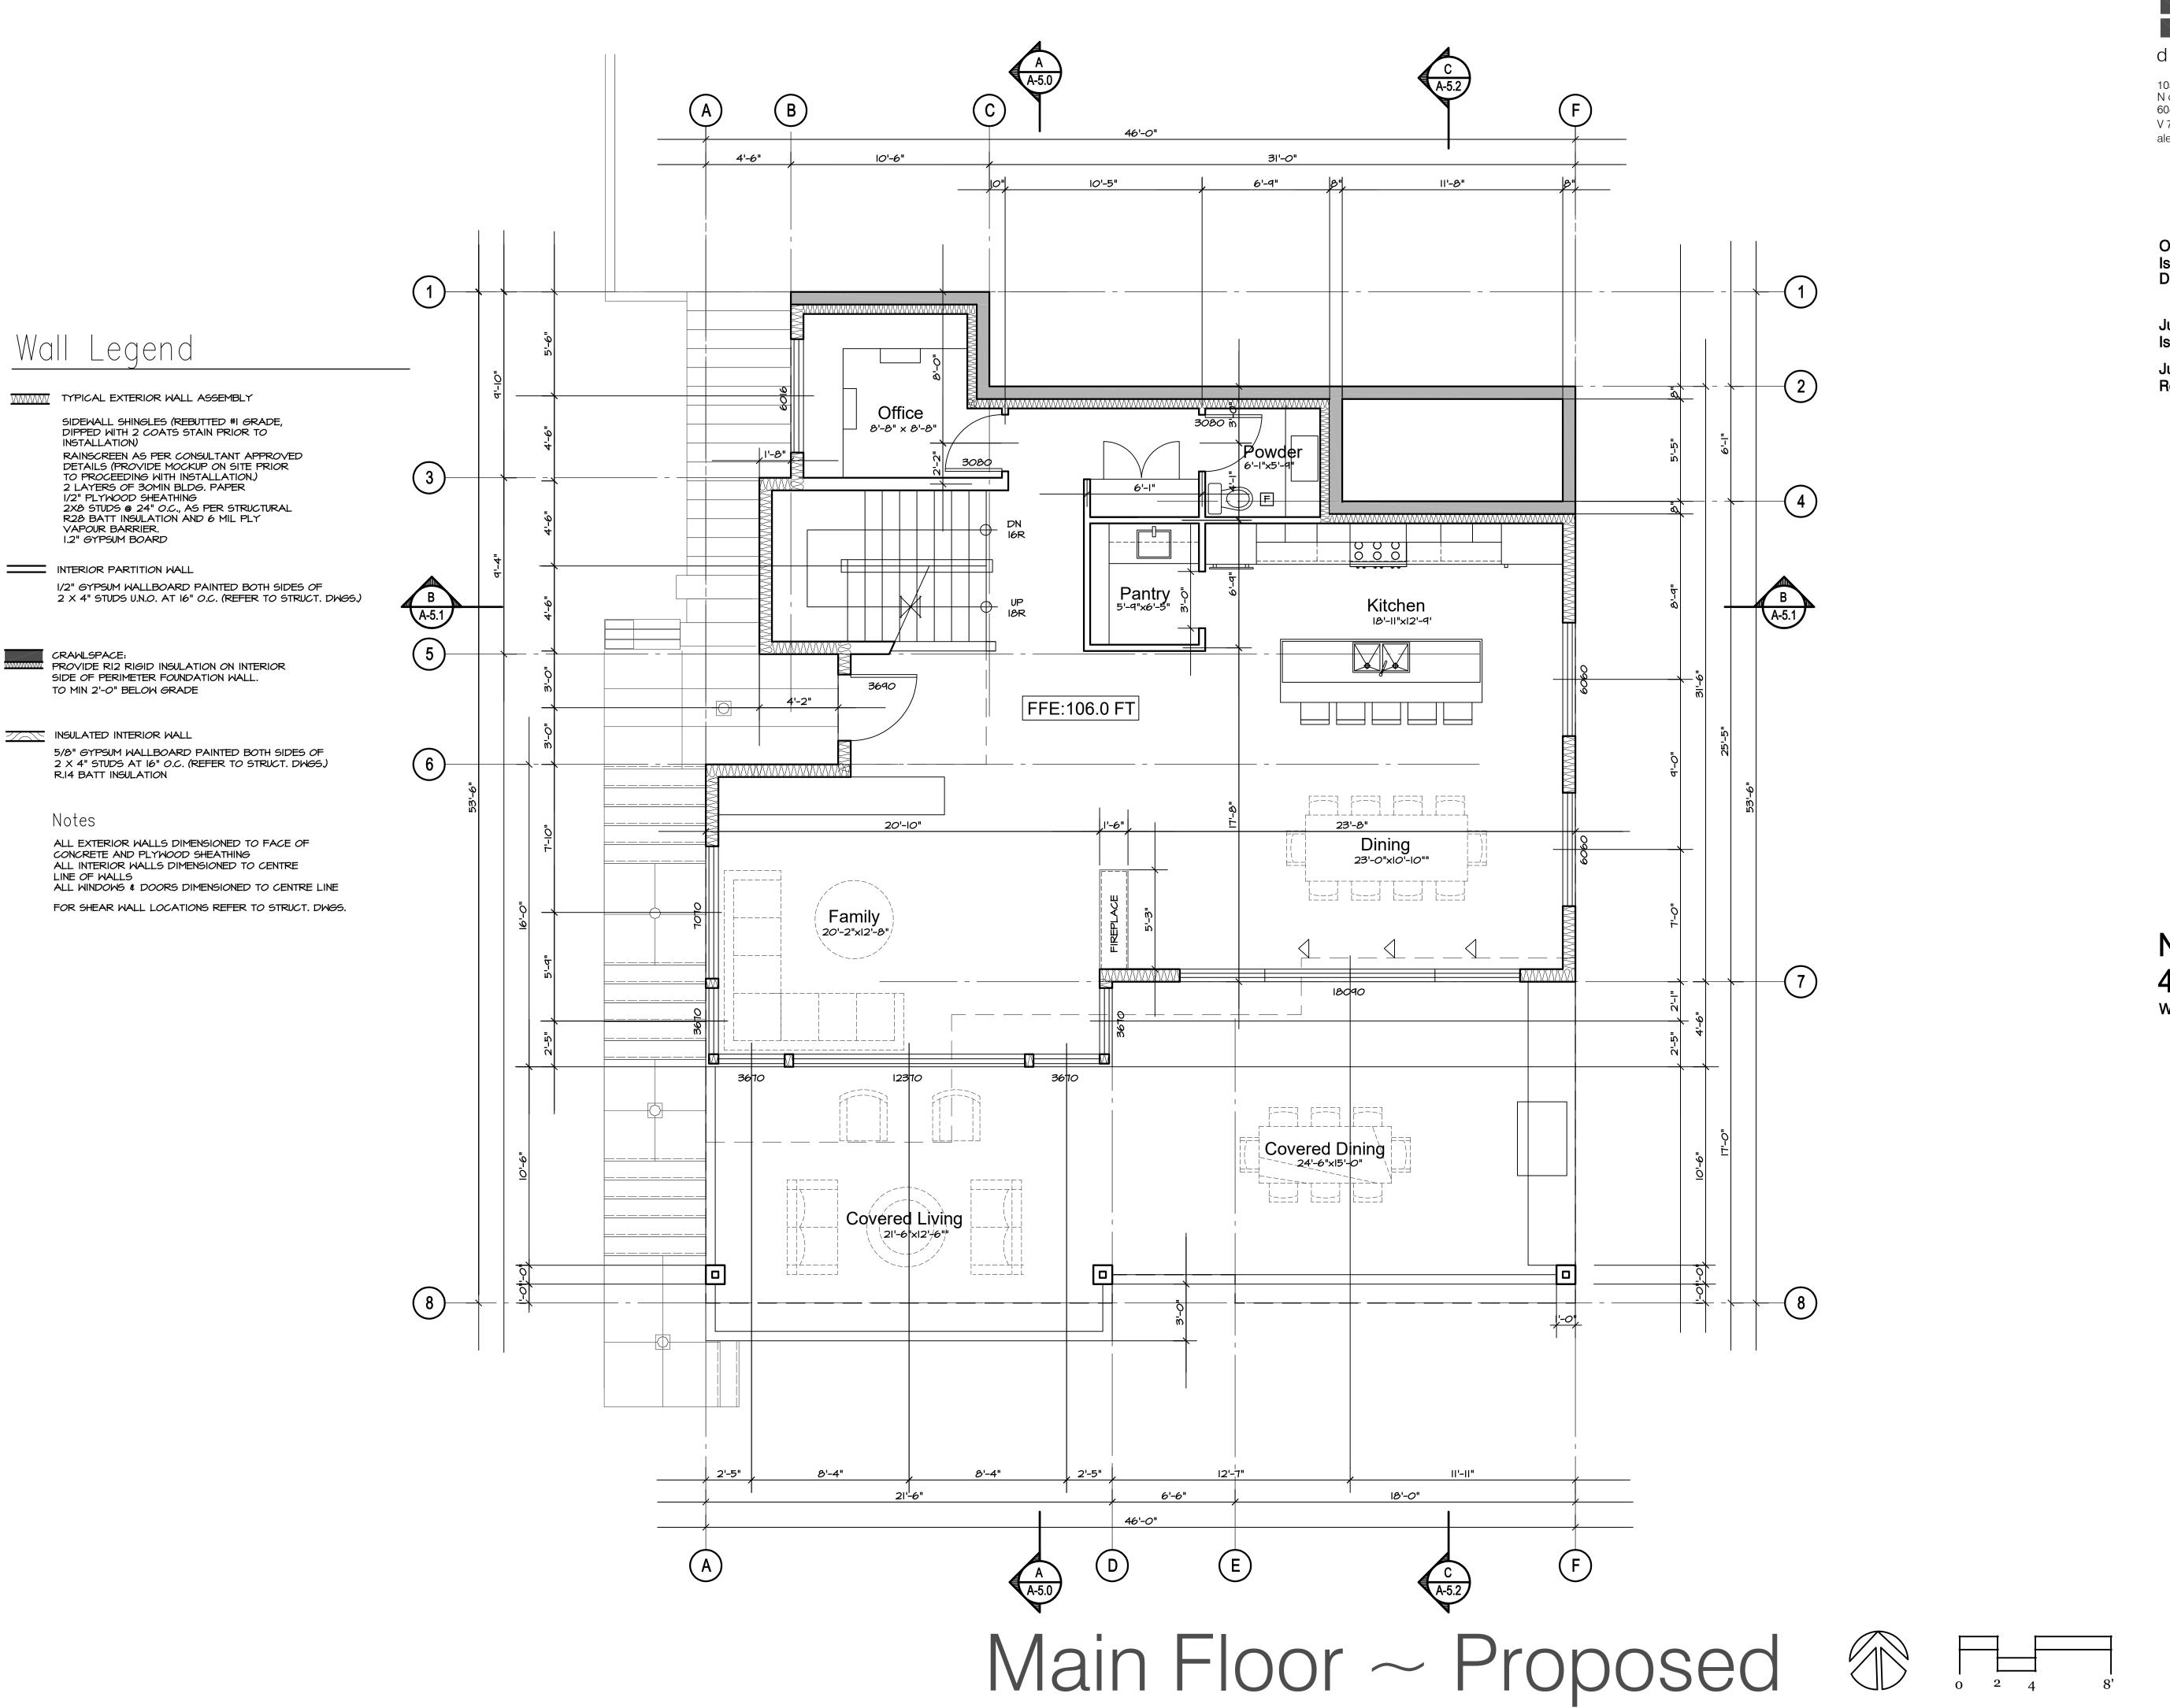
June 18, 2021 Issued to Consultants July 12, 2021 **Revisions to Capture Energy**

New Residence 4841 The Dale West Vancouver, British Columbia

Main Floor



A-3.1

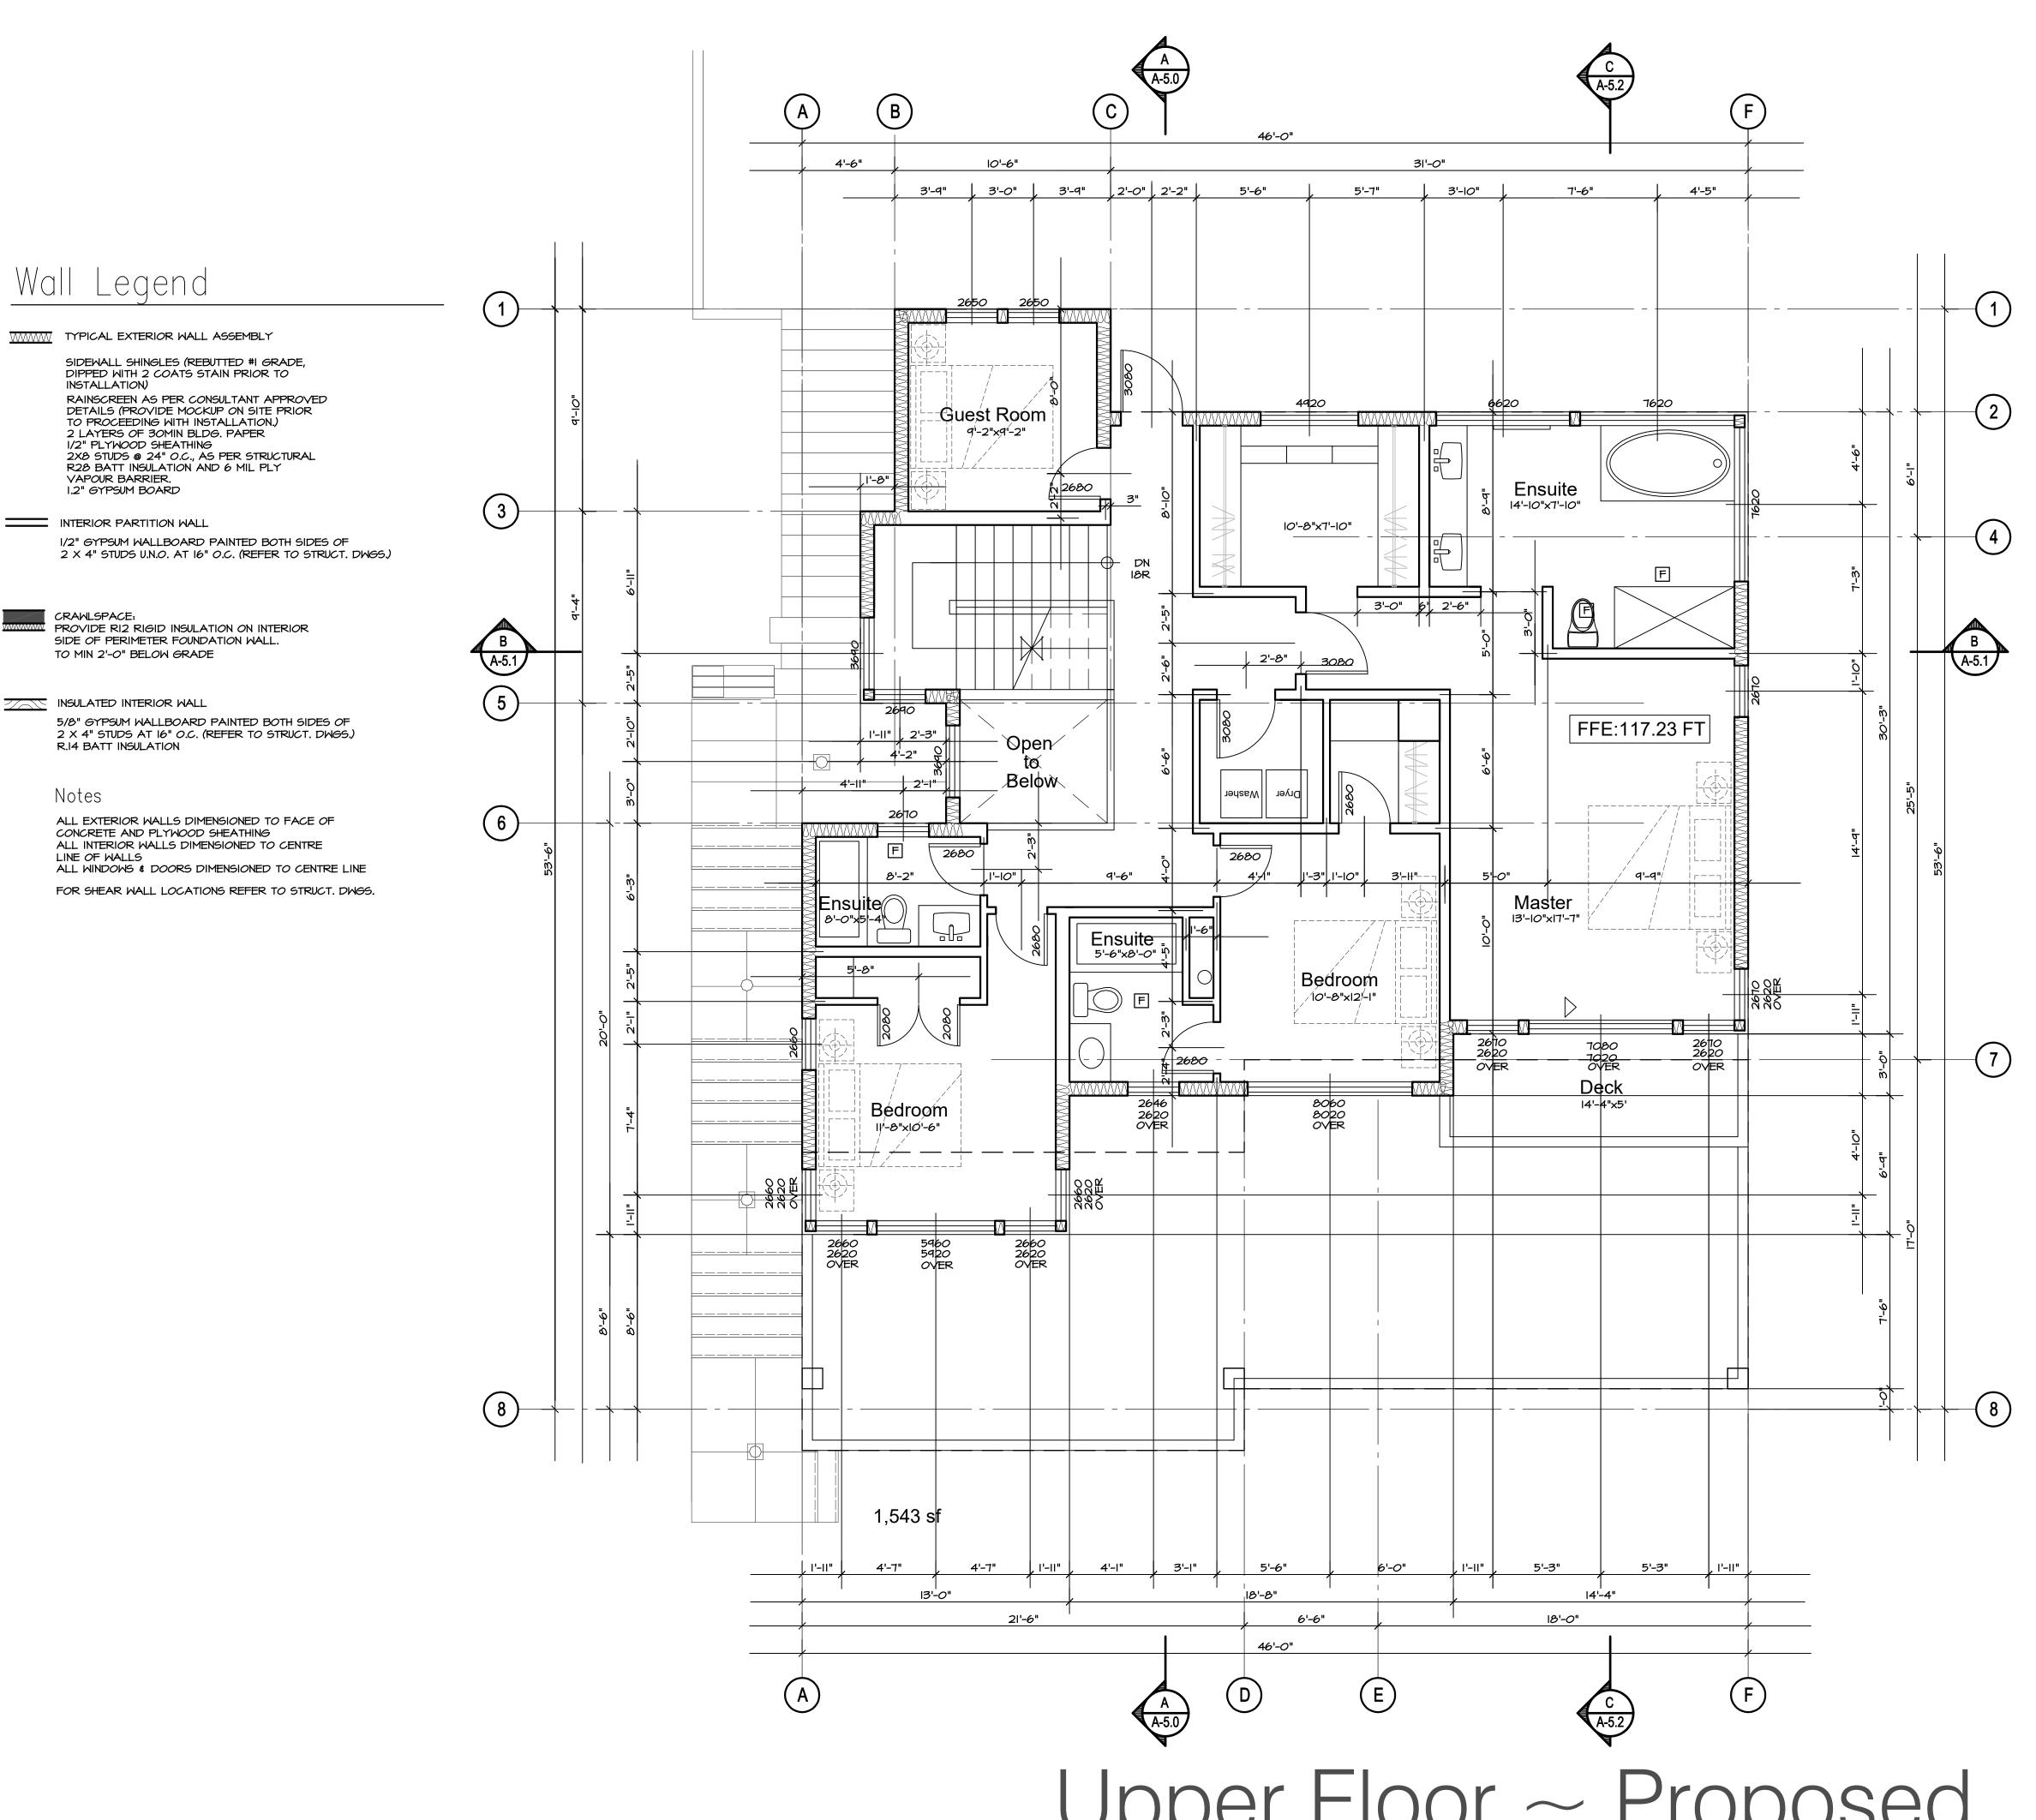




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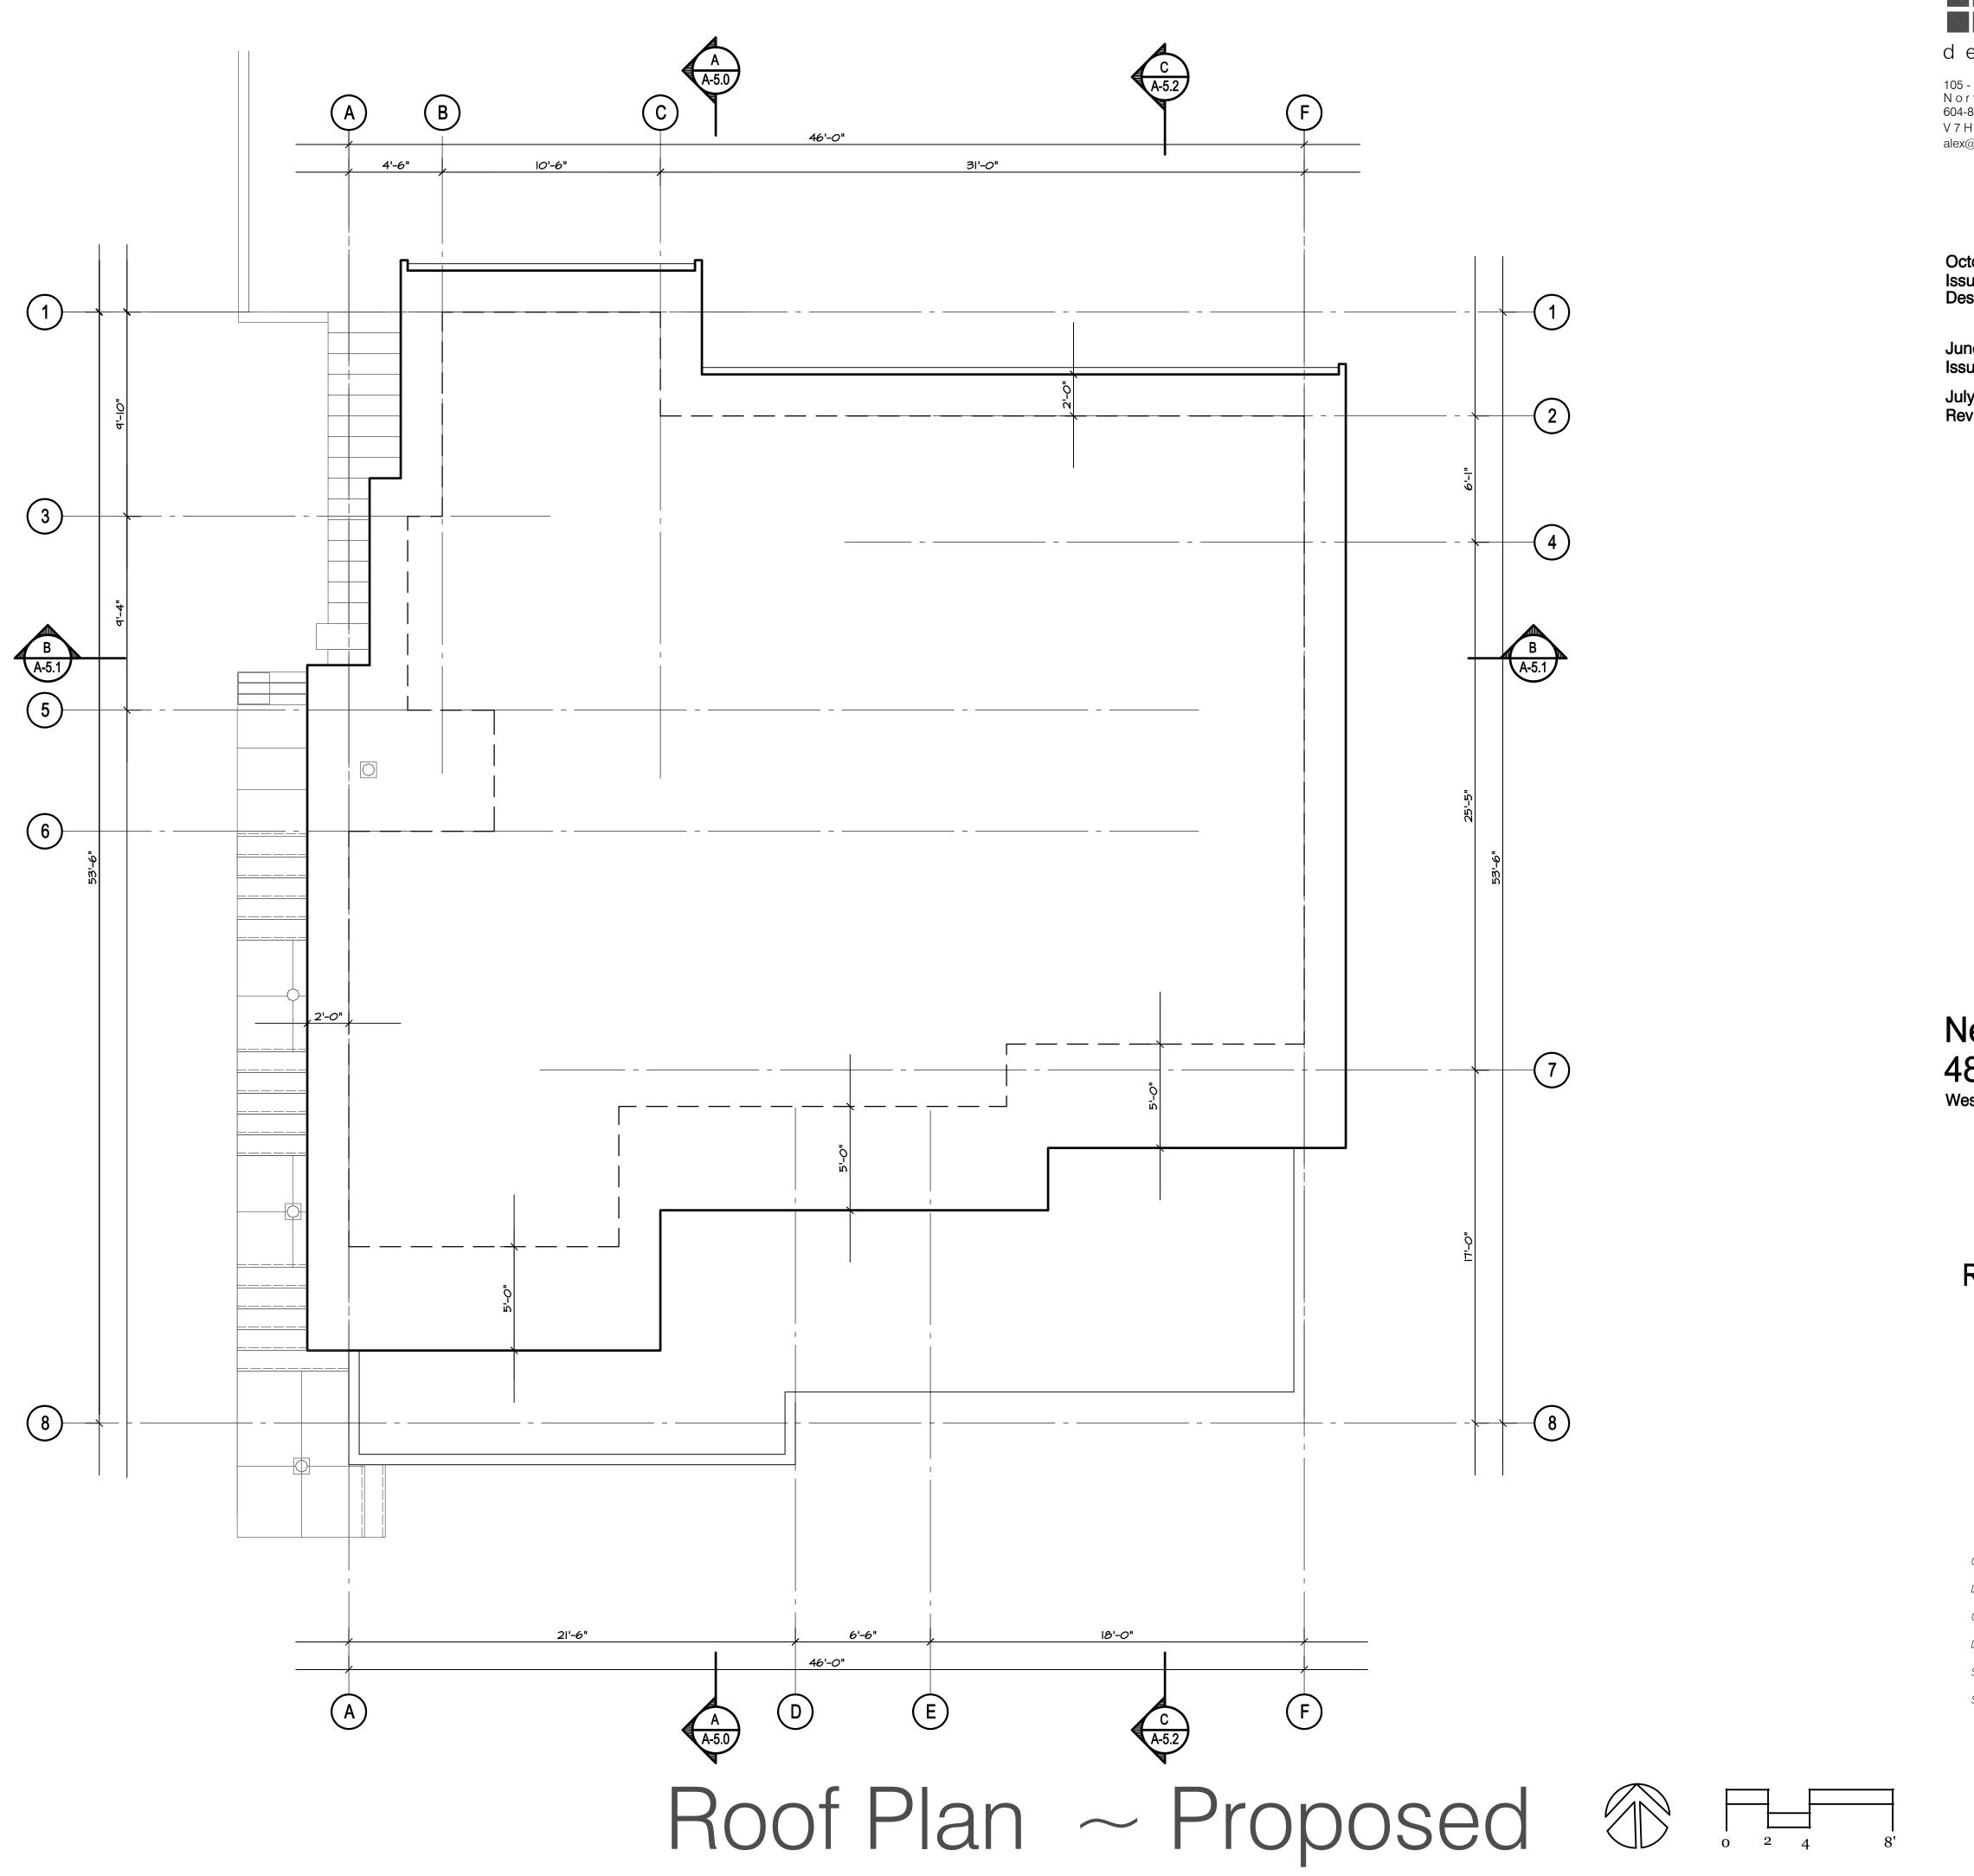
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Upper Floor

Upper Floor ~ Proposed © 1 8





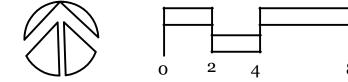

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New Residence 4841 The Dale West Vancouver, British Columbia

Roof Plan





October 23, 2019 Issued for Lower Caufield Design Panel

June 18, 2021

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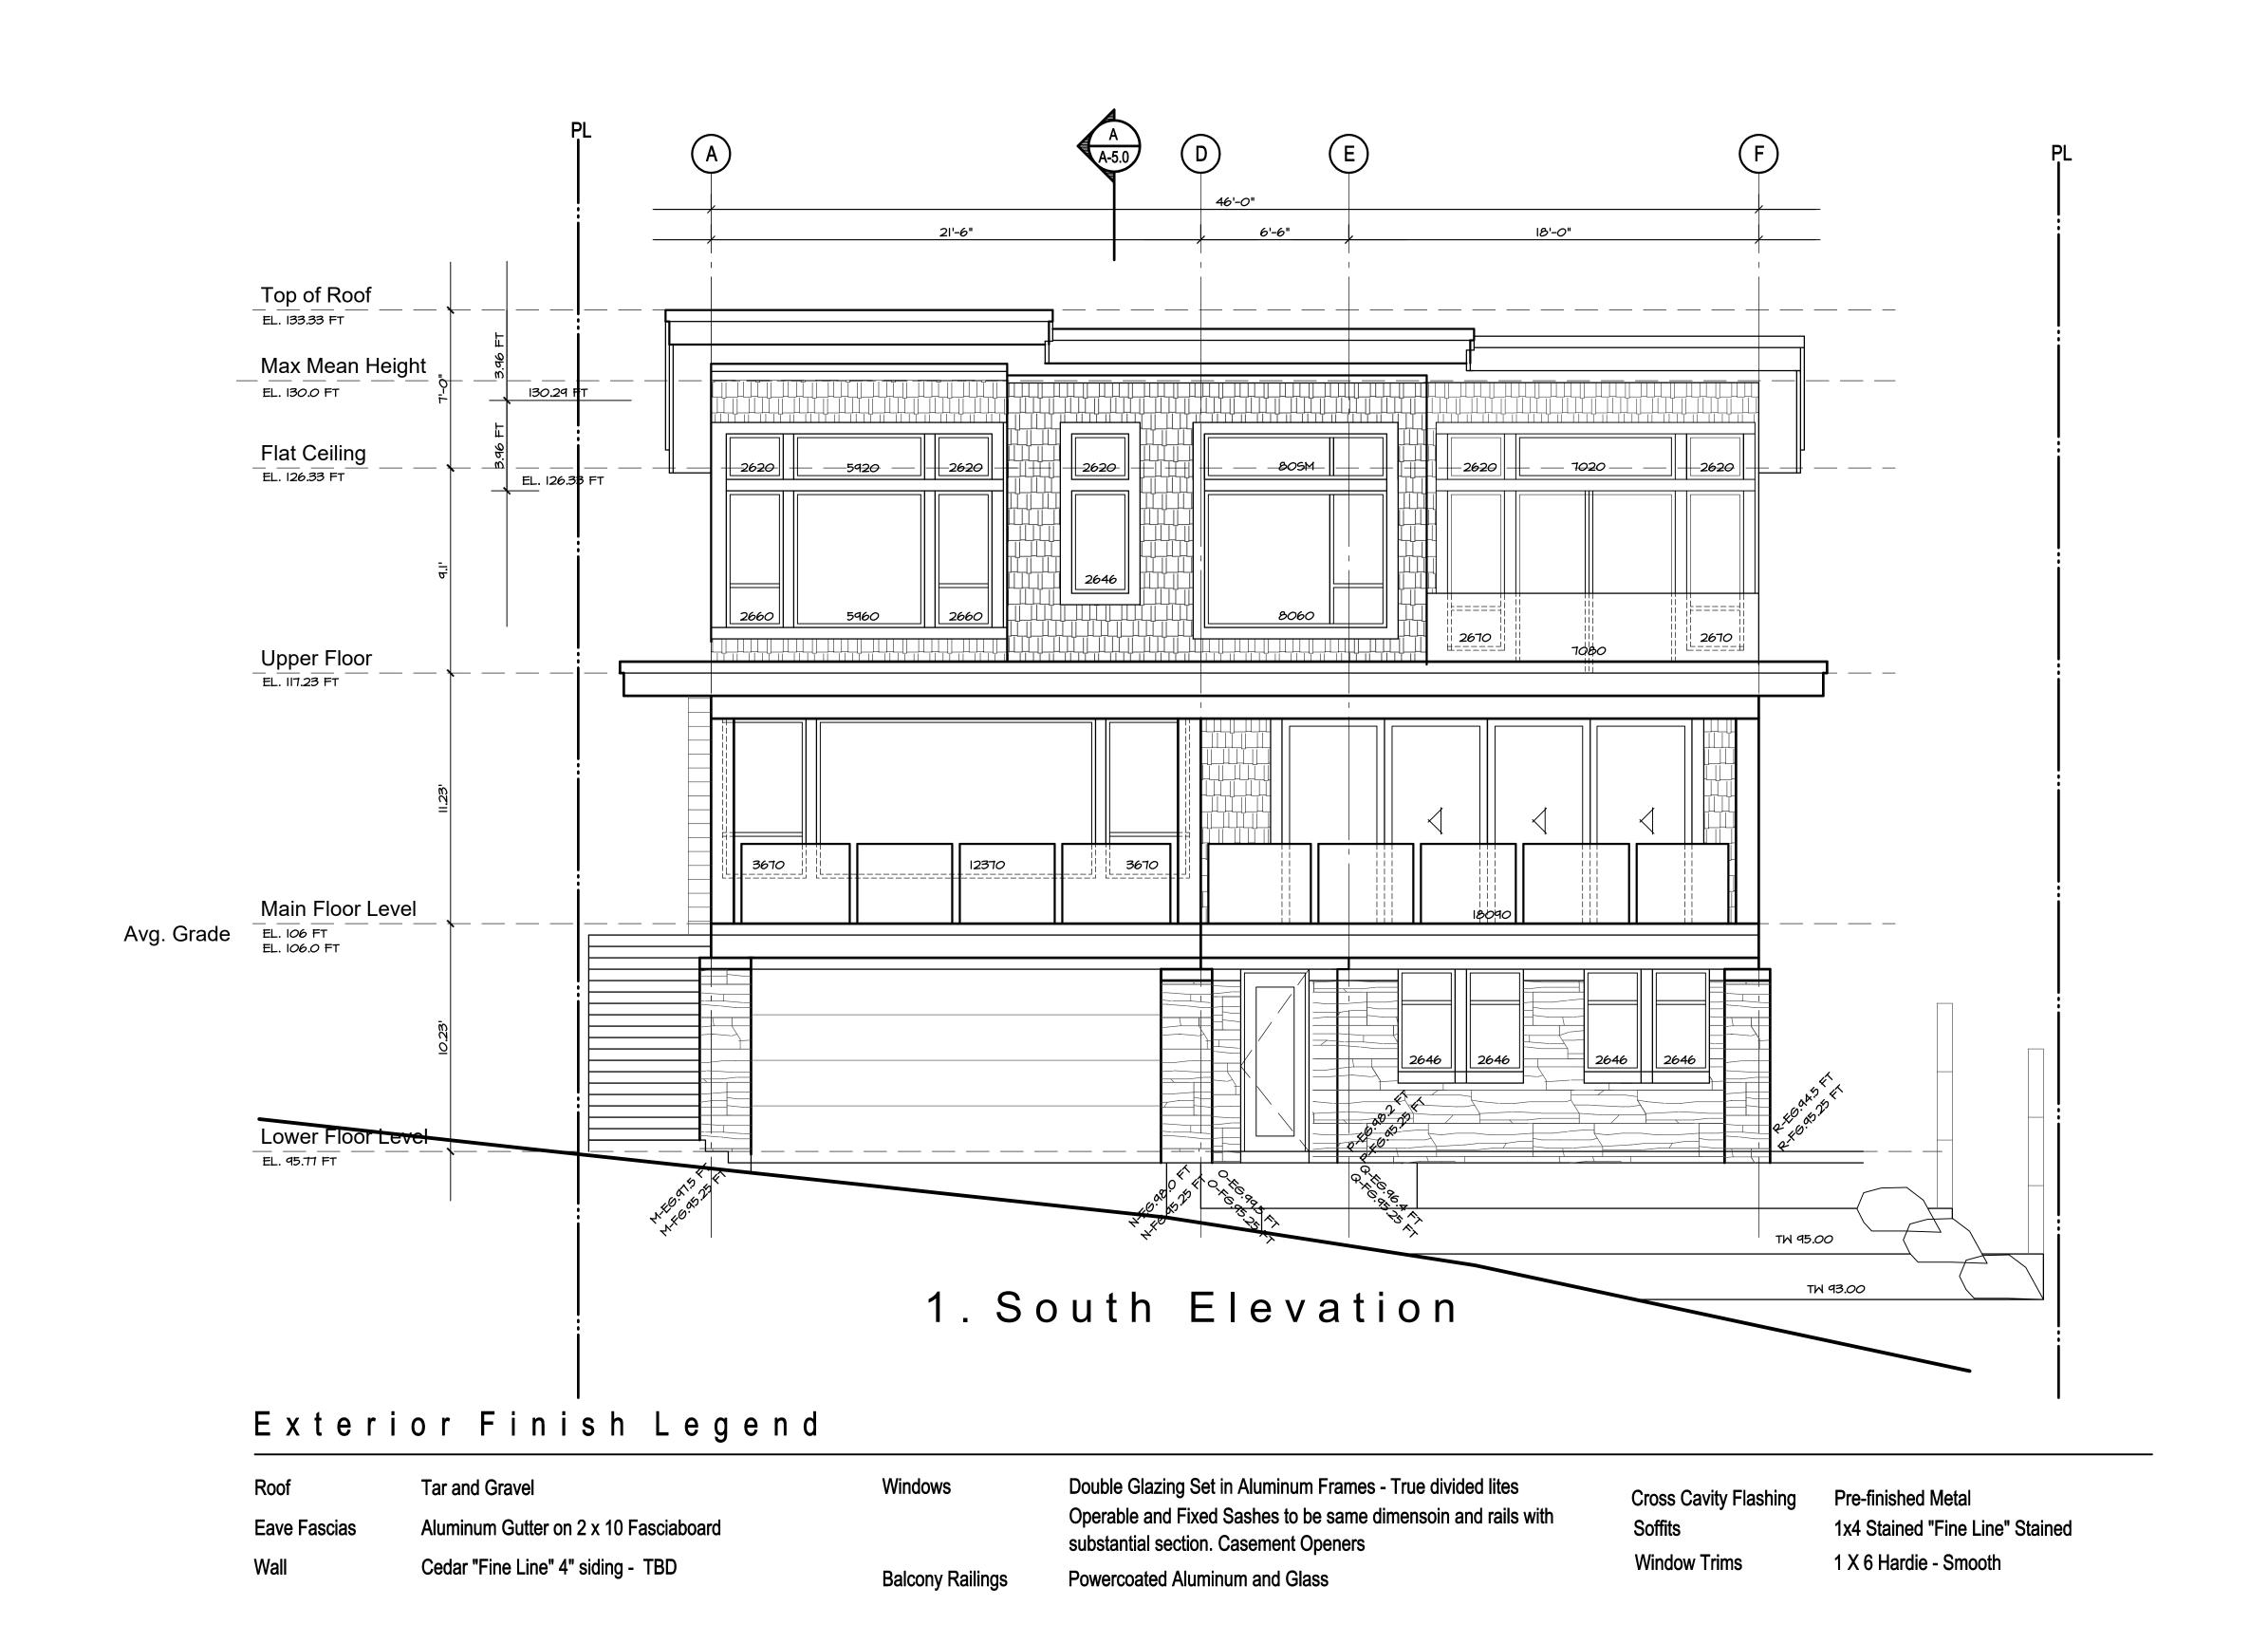
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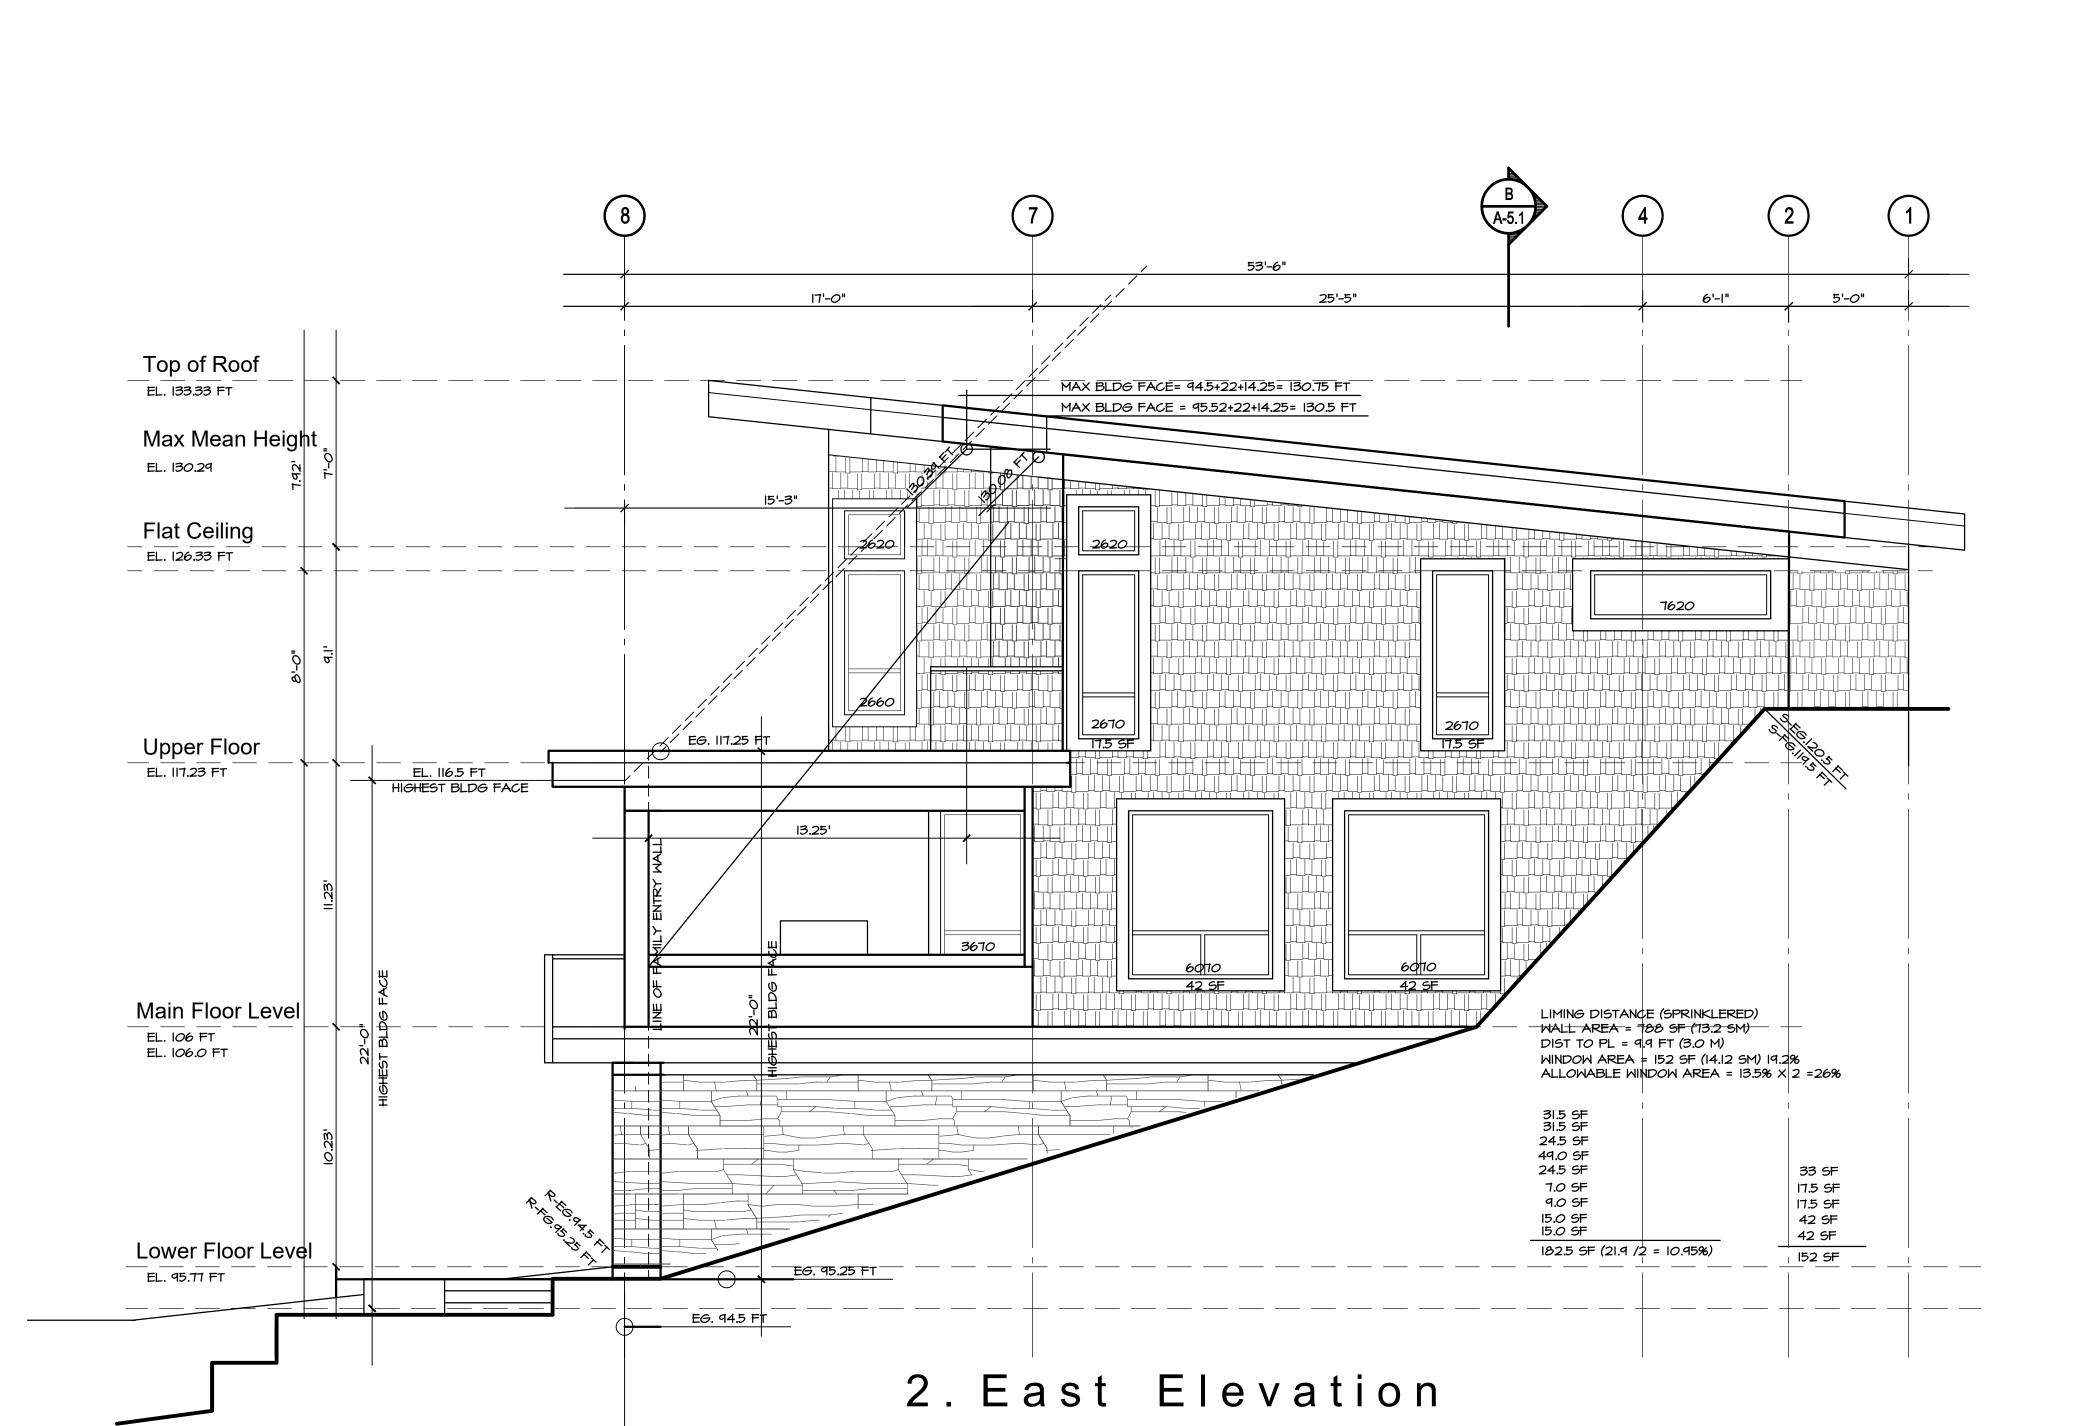
Sheet Number

0 2 4 8'

Elevation







Exterior Finish Legend

Roof Eave Fascias	Tar and Gravel Aluminum Gutter on 2 x 10 Fasciaboard	Windows	Double Glazing Set in Aluminum Frames - True divided lites Operable and Fixed Sashes to be same dimensoin and rails with substantial section. Casement Openers	Cross Cavity Flashing Soffits Window Trims	Pre-finished Metal 1x4 Stained "Fine Line" Stained
Wall	Cedar "Fine Line" 4" siding - TBD	Balcony Railings	Powercoated Aluminum and Glass	Window Trims	1 X 6 Hardie - Smooth



105 - 185 Forester St.
North Vancouver, B.C.
604-812-7810
V7H0A6
alex@alexvoth.com

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June 18, 2021 Issued to Consultants July 12, 2021 Revisions to Capture Energy

New Residence 4841 The Dale West Vancouver, British Columbia


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Contract Drawn Checked


Date JULY 12, 202
Scale 1/4" = 1'-0

Sheet Number

Elevation



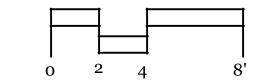

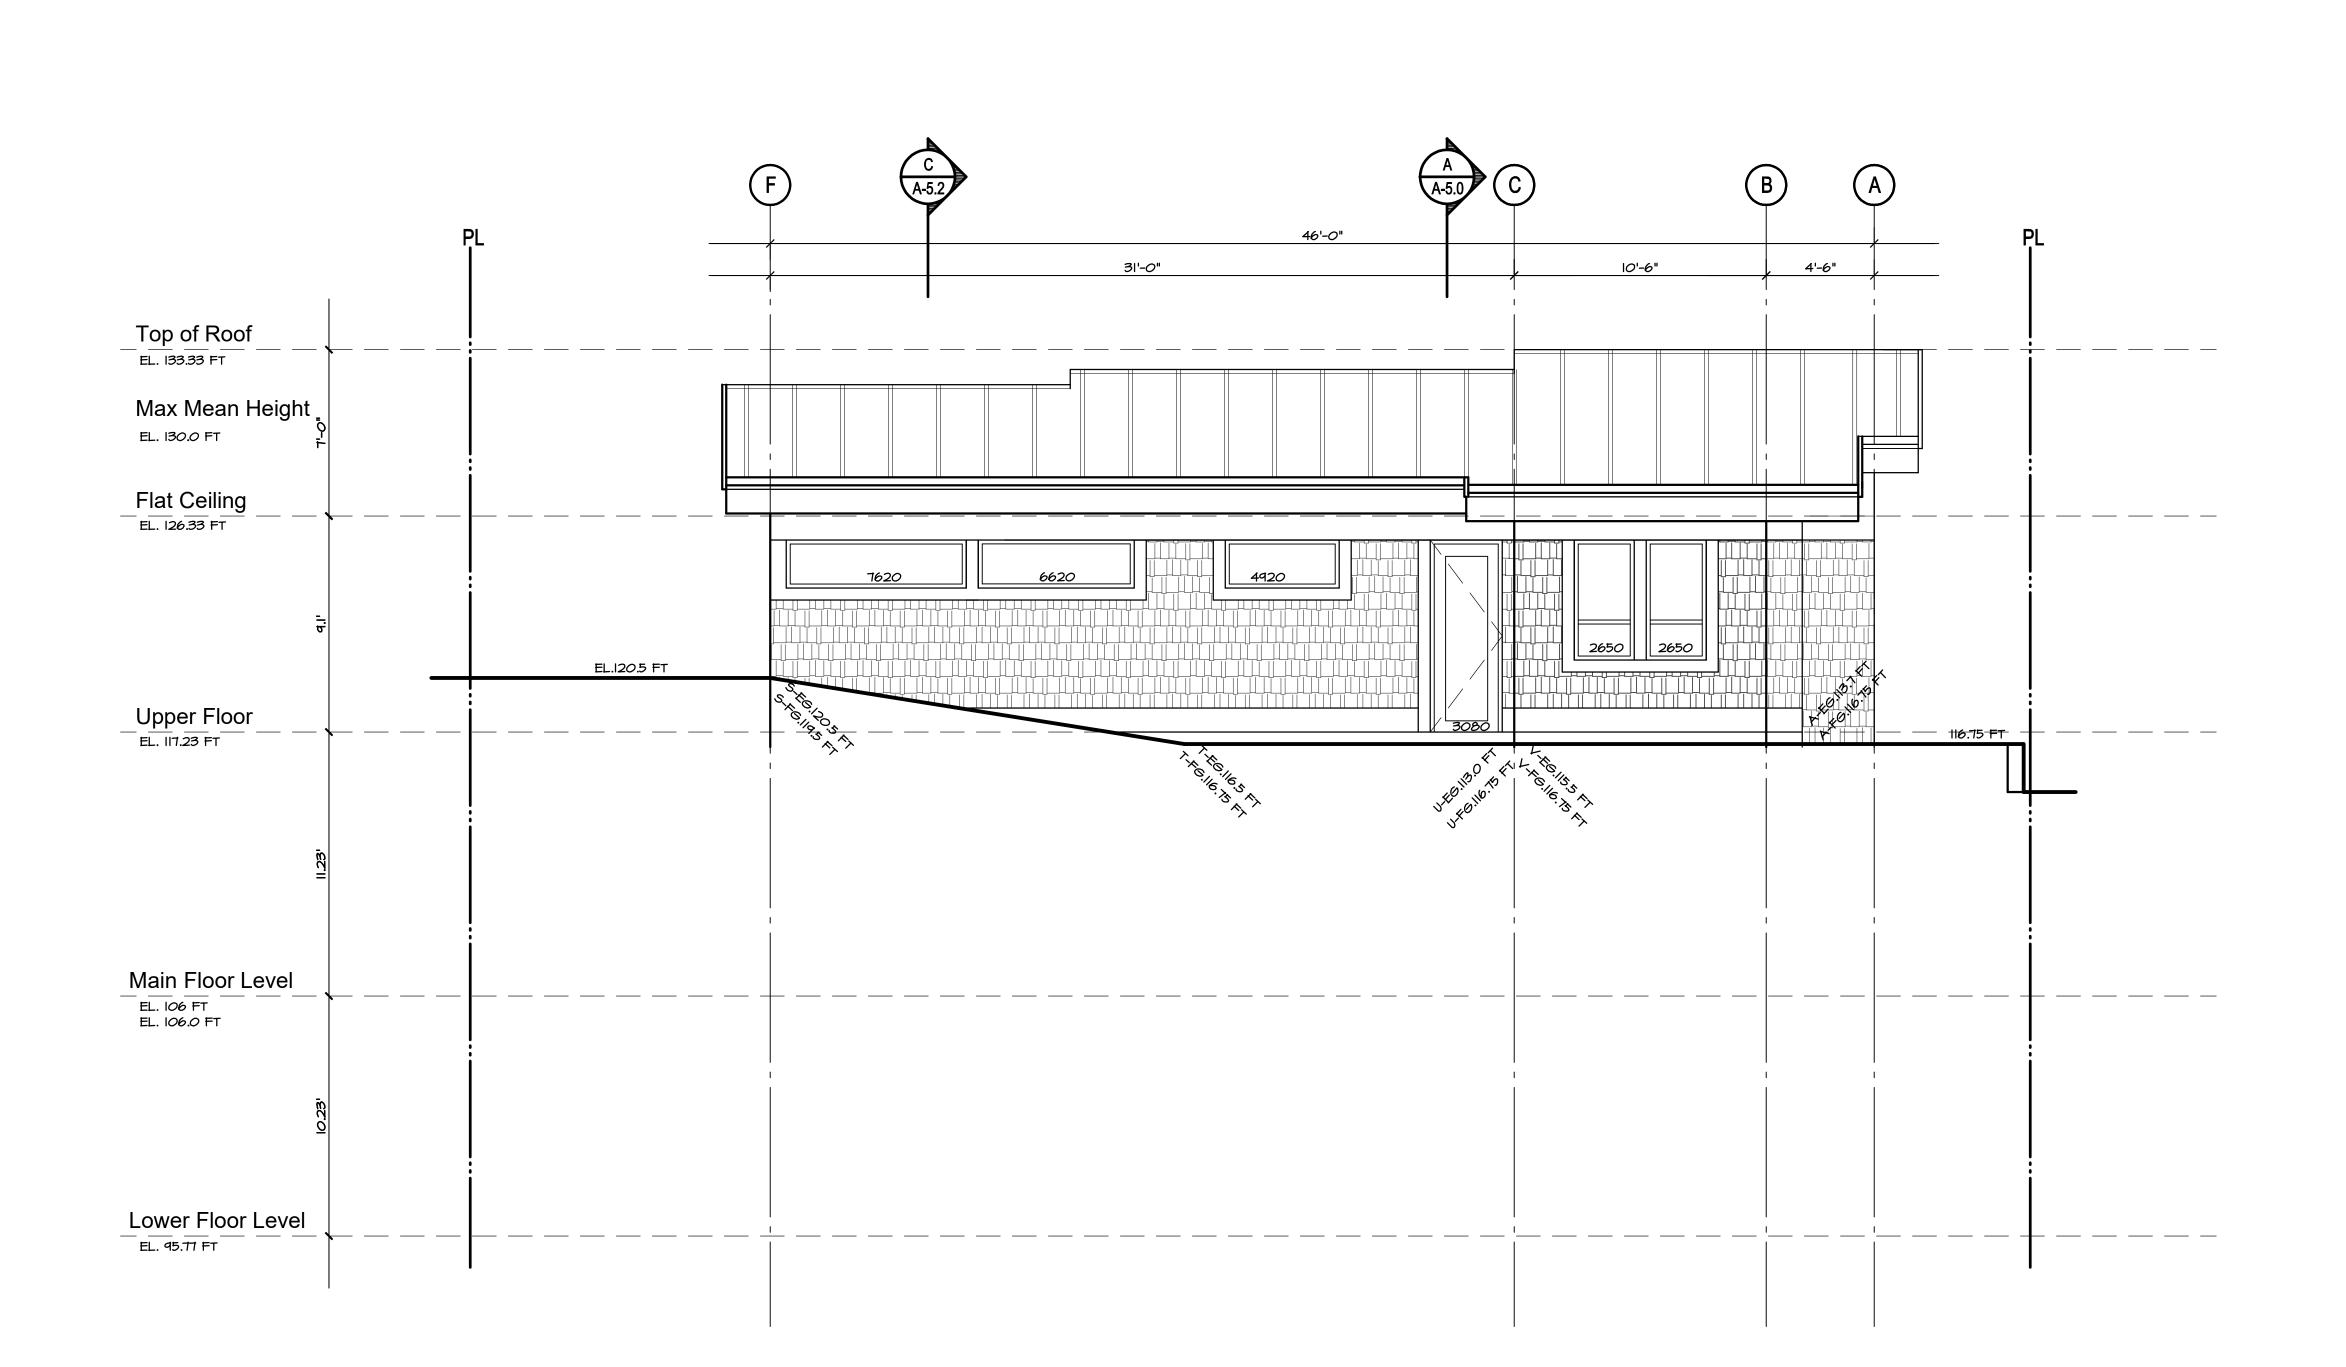

3. North Elevation

Exterior Finish Legend

Roof	Tar and Gravel	Windows	Double Glazing Set in Aluminum Frames - True divided lites	Cross Cavity Flashing	Pre-finished Metal
Eave Fascias	Aluminum Gutter on 2 x 10 Fasciaboard		Operable and Fixed Sashes to be same dimensoin and rails with substantial section. Casement Openers	Soffits	1x4 Stained "Fine Line
Wall	Cedar "Fine Line" 4" siding - TBD	Balcony Railings	Powercoated Aluminum and Glass	Window Trims	1 X 6 Hardie - Smooth

alexvoth designconsulting

105 - 185 Forester St. North Vancouver, B.C. 604-812-7810 V7H0A6 alex@alexvoth.com

October 23, 2019 Issued for Lower Caufield Design Panel


June 18, 2021 Issued to Consultants July 12, 2021 Revisions to Capture Energy

New Residence 4841 The Dale West Vancouver, British Columbia

Elevation

Elevation

1x4 Stained "Fine Line" Stained

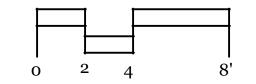






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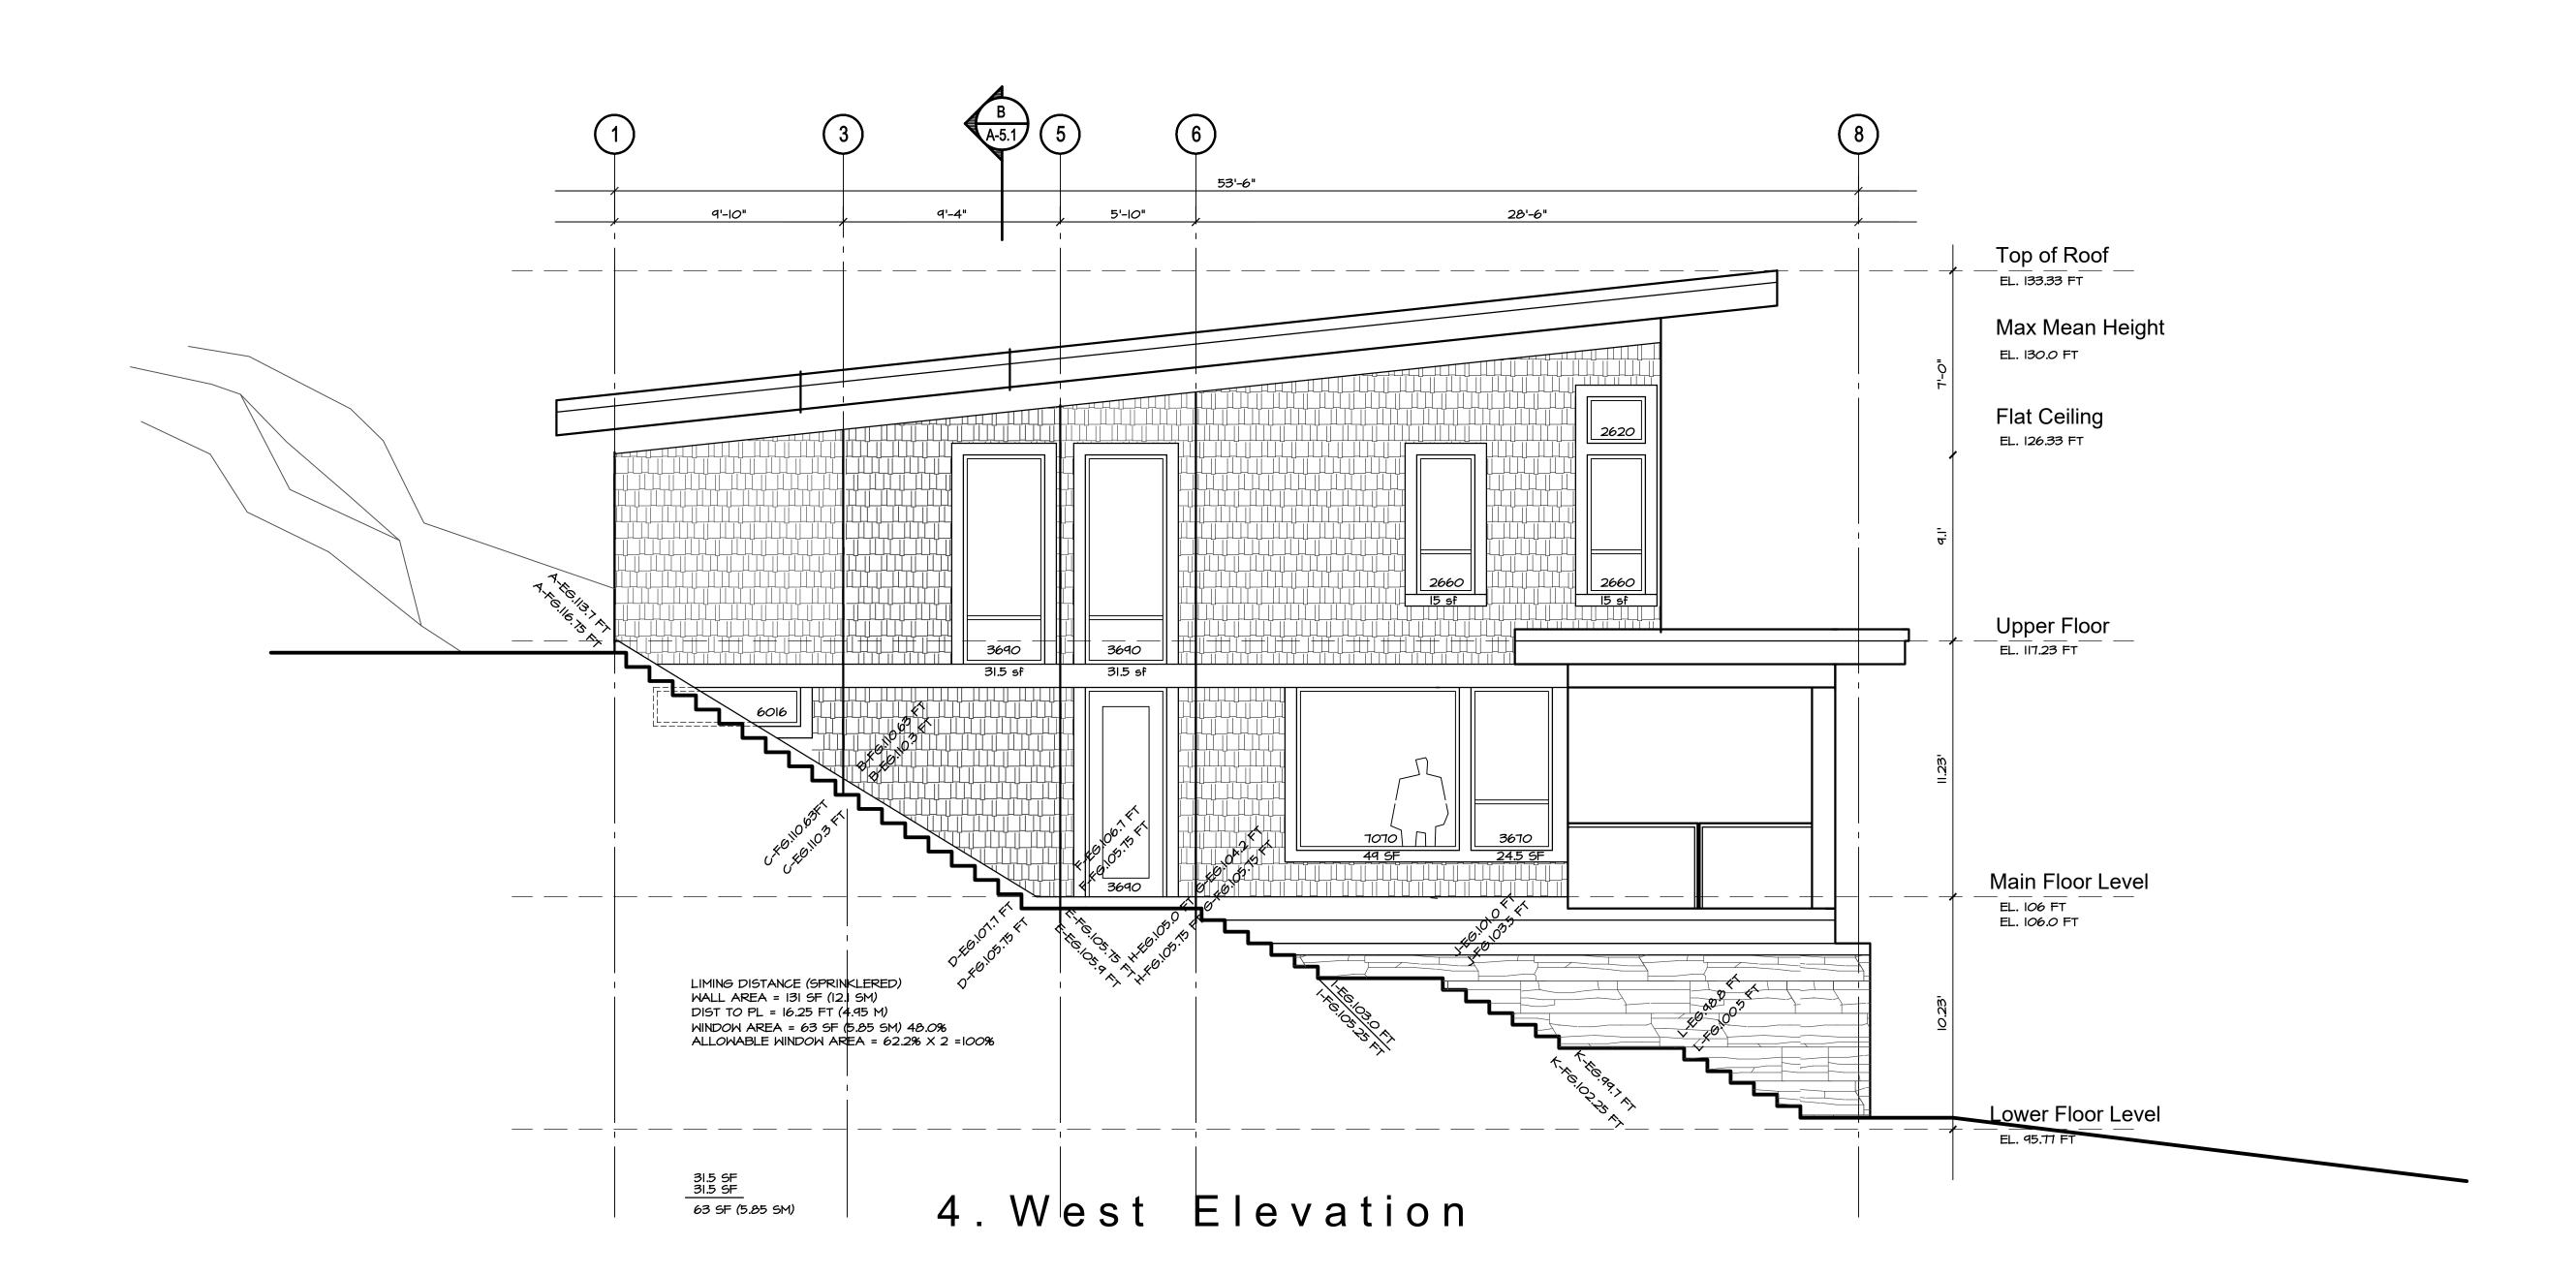
Issued to Consultants
July 12, 2021
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June 18, 2021

New Residence 4841 The Dale West Vancouver, British Columbia

Elevation




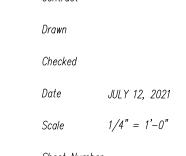

Exterior Finish Legend

Roof Eave Fascias	Tar and Gravel Aluminum Gutter on 2 x 10 Fasciaboard	Windows	Double Glazing Set in Aluminum Frames - True divided lites Operable and Fixed Sashes to be same dimensoin and rails with substantial section. Casement Openers	Cross Cavity Flashing Soffits	Pre-finished Metal 1x4 Stained "Fine Line" Stained
Wall	Cedar "Fine Line" 4" siding - TBD	Balcony Railings	Powercoated Aluminum and Glass	Window Trims	1 X 6 Hardie - Smooth



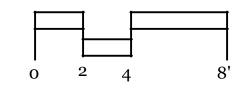




October 23, 2019 Issued for Lower Caufield Design Panel

June 18, 2021 Issued to Consultants July 12, 2021 Revisions to Capture Energy

New Residence 4841 The Dale West Vancouver, British Columbia

Section A

Sheet Number

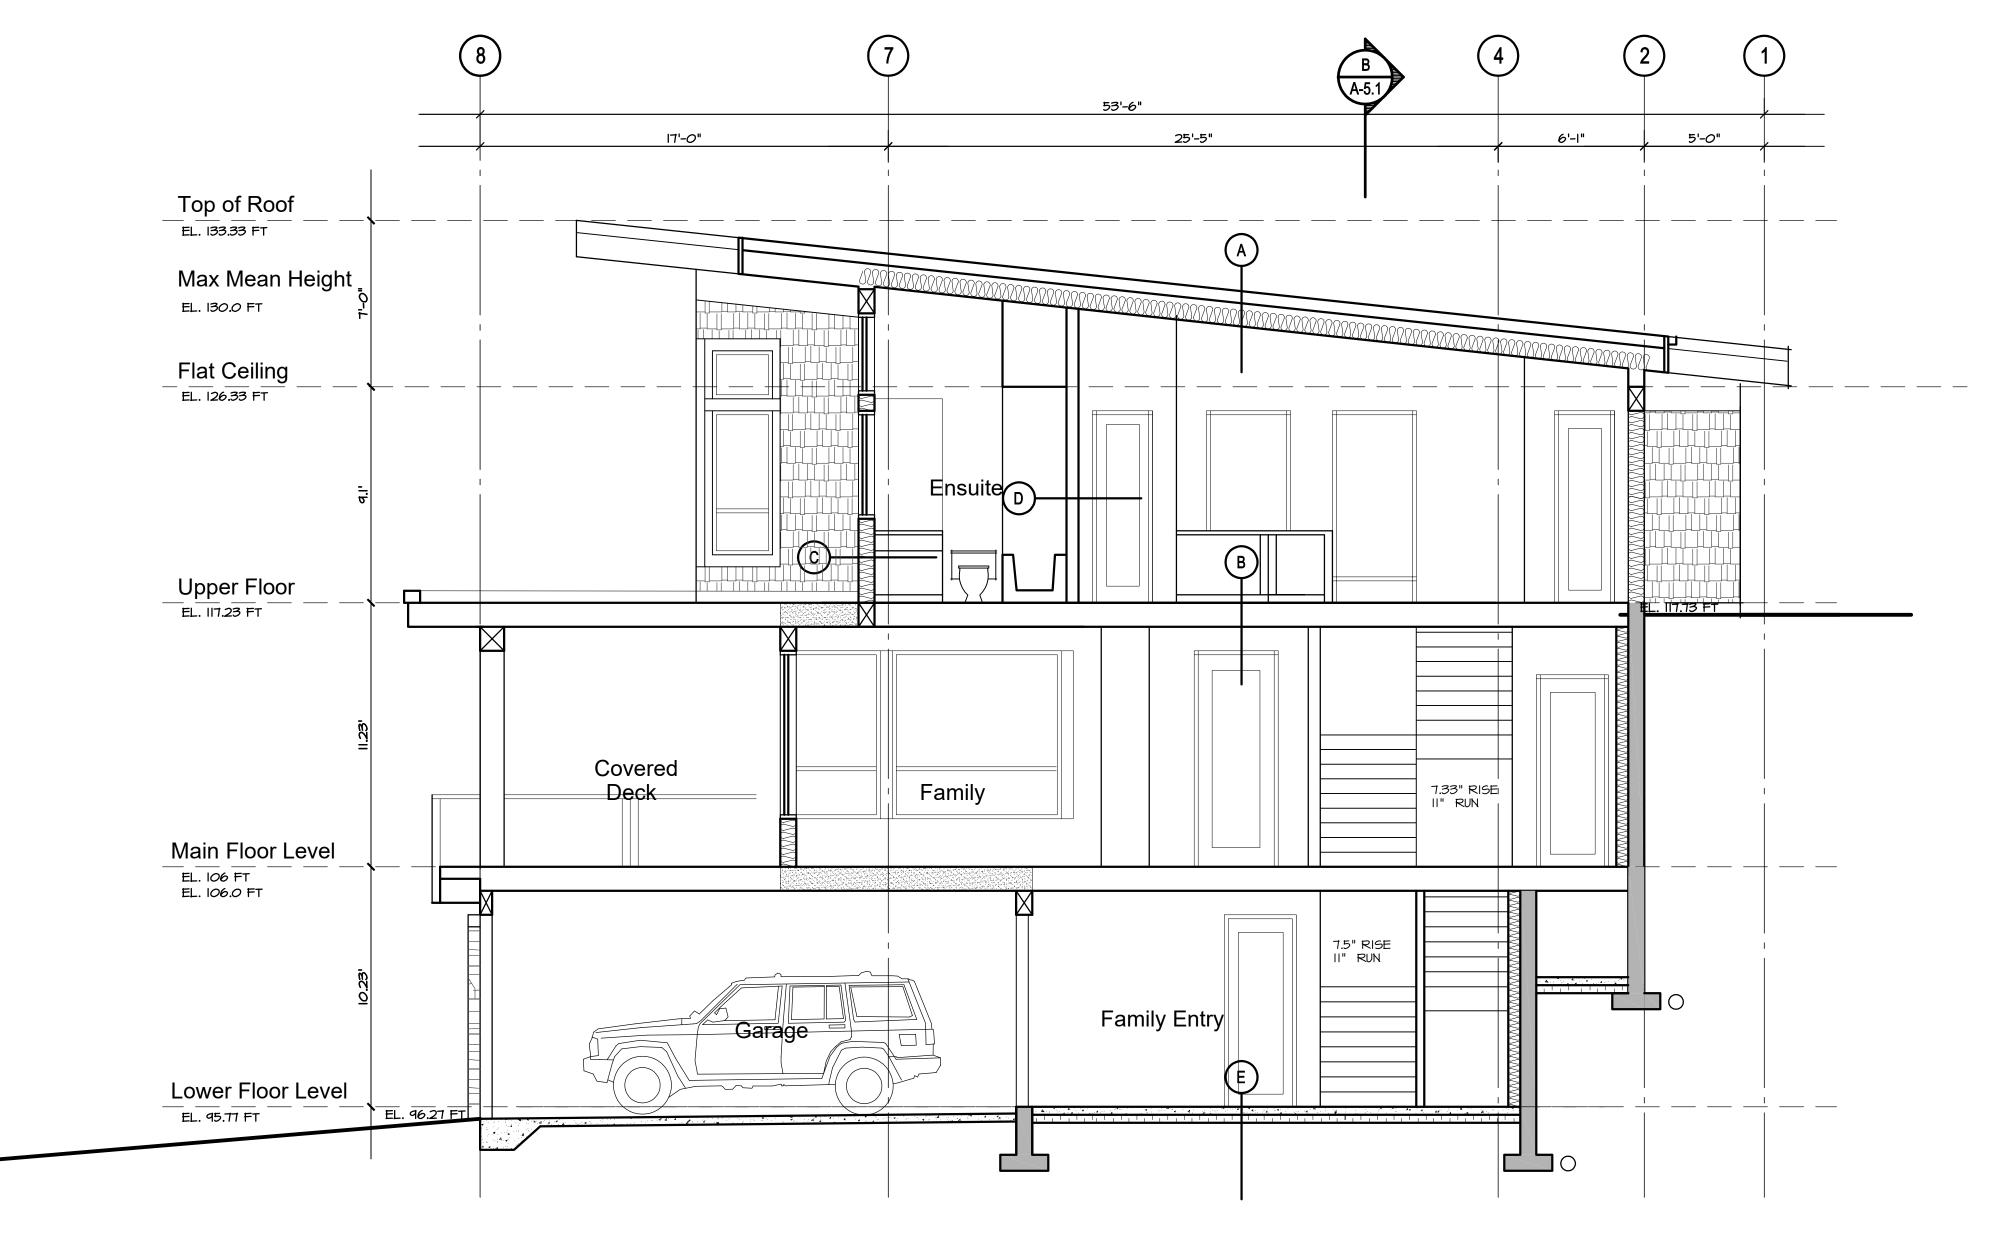

Section A

Assembly Legend


- A. STANDING SEAM ROOF CASCADIA WATERPROOF MEMBRANE ON SHEATHING, AS PER STRUCTURAL 2X4 STRAPPING ON TJI ROOF JOISTS AT 24" O.C. R-40 BATT. INSULATION 6 MIL U.V. POLY VAPOUR BARRIER 1/2" DRYWALL
- B. FLOOR FINISH ON RADIANT FLOORING - LIGHT WEIGHT 1.5" GYPCRETE ON 5/8" T & G PLYWOOD SHEATHING, NAILED AND GLUED TJI FLOOR FRAMING PER STRUCTURAL 1/2" DRYWALL (NO DRYWALL BETWEEN CRAWLSPACE AND MAIN FLOOR)
- C. HORIZONTAL SIDING RAINSCREEN AS PER CONSULTANT APPROVED DETAILS (PROVIDE MOCKUP ON SITE PRIOR TO PROCEEDING WITH INSTALLATION.)
 TYVEK COMMERICIAL WRAP, INSTALLED AS A AIR BARRIER SYSTEM 1/2" PLYWOOD SHEATHING 2X8 STUDS @ 24" O.C., AS PER STRUCTURAL R28 BATT INSULATION AND 6 MIL PLY YAPOUR BARRIER.

1.2" GYPSUM BOARD

- D. INTERIOR PARTITION WALL I/2" GYPSUM BOARD BOTH SIDES OF 2X4 STUDS UNLESS NOTED ON DRAWINGS BY STRUCTURAL OR PLUMBING WALLS SHOWN
- E. FLOOR FINISH ON 4" CONCRETE SLAB ON GRADE 4" XPS R 20 RIGID INSULATION 6 MIL U.V. POLY VAPOUR BARRIER 6" COMPACTED GRAVEL BASE
 - F. FOUNDATION WALL ASSEMBLY DIMPLEBOARD DRAINAGE MAT 2 COATS DAMP PROOFING 8" CONCRETE 2" XPS RIGID INSULATION 2X4 @ 24" O.C. W/ RI4 BATT INSULATION
- G. CANTILEVERED SPACE R-40 BATT. INSULATION FINE-LINE HEMLOCK SOFFIT W/ VENT STRIPS

JULY 12, 2021

Section

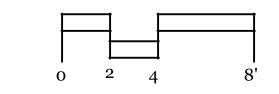






October 23, 2019 Issued for Lower Caufield Design Panel

June 18, 2021

Issued to Consultants July 12, 2021 Revisions to Capture Energy


New Residence 4841 The Dale West Vancouver, British Columbia

Section B

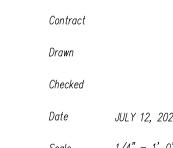

Sheet Number



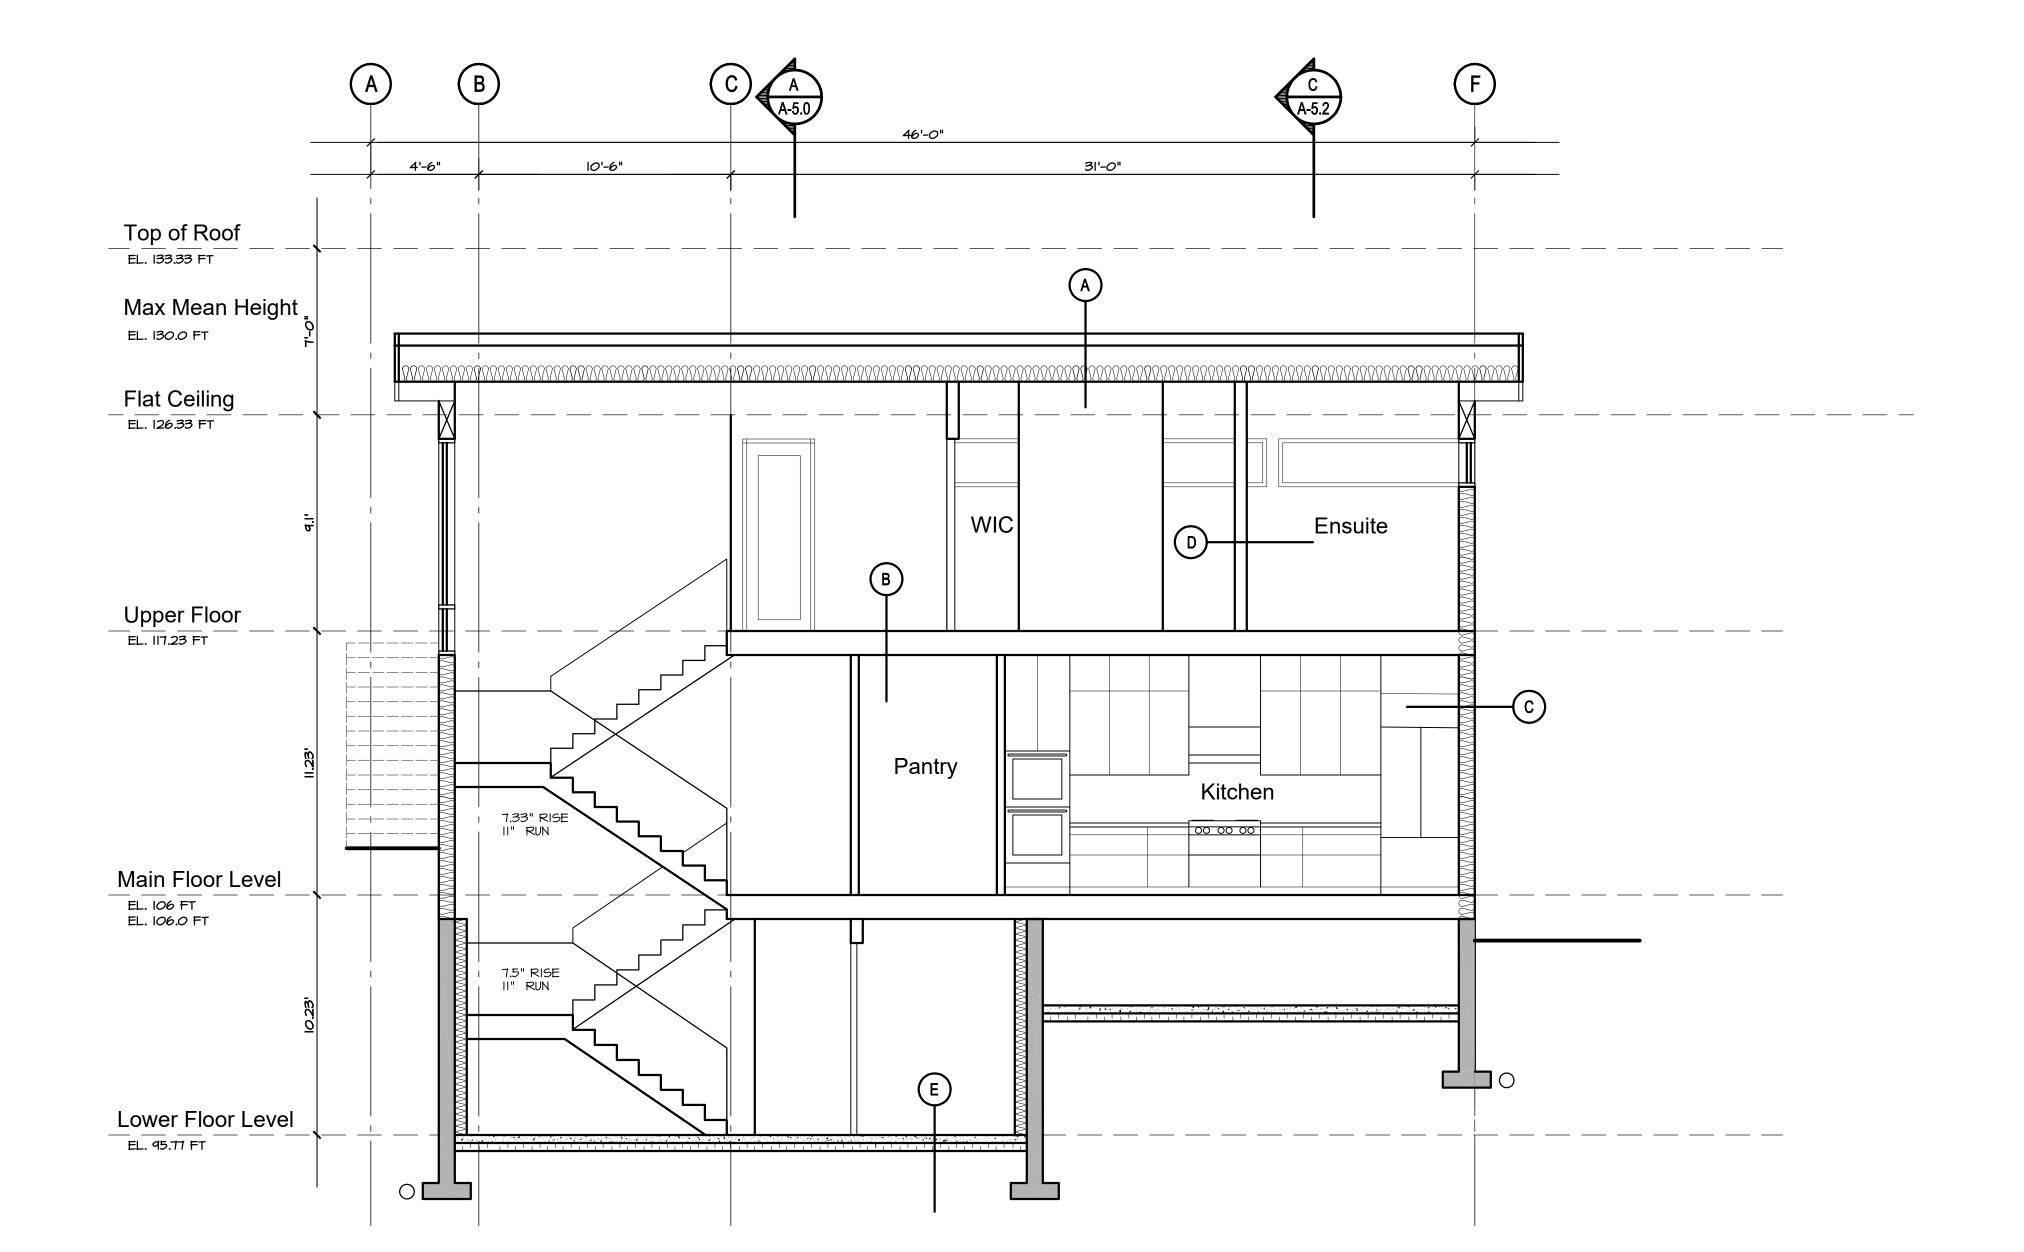

Section B

Assembly Legend

A. STANDING SEAM ROOF - CASCADIA WATERPROOF MEMBRANE ON SHEATHING, AS PER STRUCTURAL
2X4 STRAPPING ON
TJI ROOF JOISTS AT 24" O.C.
R-40 BATT. INSULATION
6 MIL U.V. POLY VAPOUR BARRIER 1/2" DRYWALL

FLOOR FINISH ON RADIANT FLOORING - LIGHT WEIGHT 1.5" GYPCRETE ON 5/8" T & G PLYWOOD SHEATHING, NAILED AND GLUED
TJI FLOOR FRAMING PER STRUCTURAL
1/2" DRYWALL (NO DRYWALL BETWEEN CRAWLSPACE AND MAIN FLOOR)

C. HORIZONTAL SIDING RAINSCREEN AS PER CONSULTANT APPROVED DETAILS (PROVIDE MOCKUP ON SITE PRIOR TO PROCEEDING WITH INSTALLATION.) TYVEK COMMERICIAL WRAP, INSTALLED AS A AIR BARRIER SYSTEM I/2" PLYWOOD SHEATHING
2X8 STUDS @ 24" O.C., AS PER STRUCTURAL
R28 BATT INSULATION AND 6 MIL PLY
VAPOUR BARRIER.
I.2" GYPSUM BOARD

D. INTERIOR PARTITION WALL I/2" GYPSUM BOARD BOTH SIDES OF 2X4 STUDS UNLESS NOTED ON DRAWINGS BY STRUCTURAL OR PLUMBING WALLS SHOWN

E. FLOOR FINISH ON 4" CONCRETE SLAB ON GRADE 4" XPS R 20 RIGID INSULATION 6 MIL U.Y. POLY VAPOUR BARRIER 6" COMPACTED GRAVEL BASE

F. FOUNDATION WALL ASSEMBLY DIMPLEBOARD DRAINAGE MAT 2 COATS DAMP PROOFING 8" CONCRETE 2" XPS RIGID INSULATION 2X4 @ 24" O.C. W RI4 BATT INSULATION I/2" GWB G. CANTILEVERED SPACE R-40 BATT. INSULATION FINE-LINE HEMLOCK SOFFIT W/ VENT STRIPS

JULY 12, 2021




October 23, 2019 Issued for Lower Caufield Design Panel

June 18, 2021

Issued to Consultants
July 12, 2021
Revisions to Capture Energy


New Residence 4841 The Dale West Vancouver, British Columbia


Section C

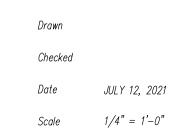


Sheet Number

Section

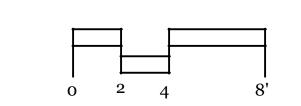

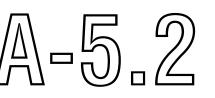

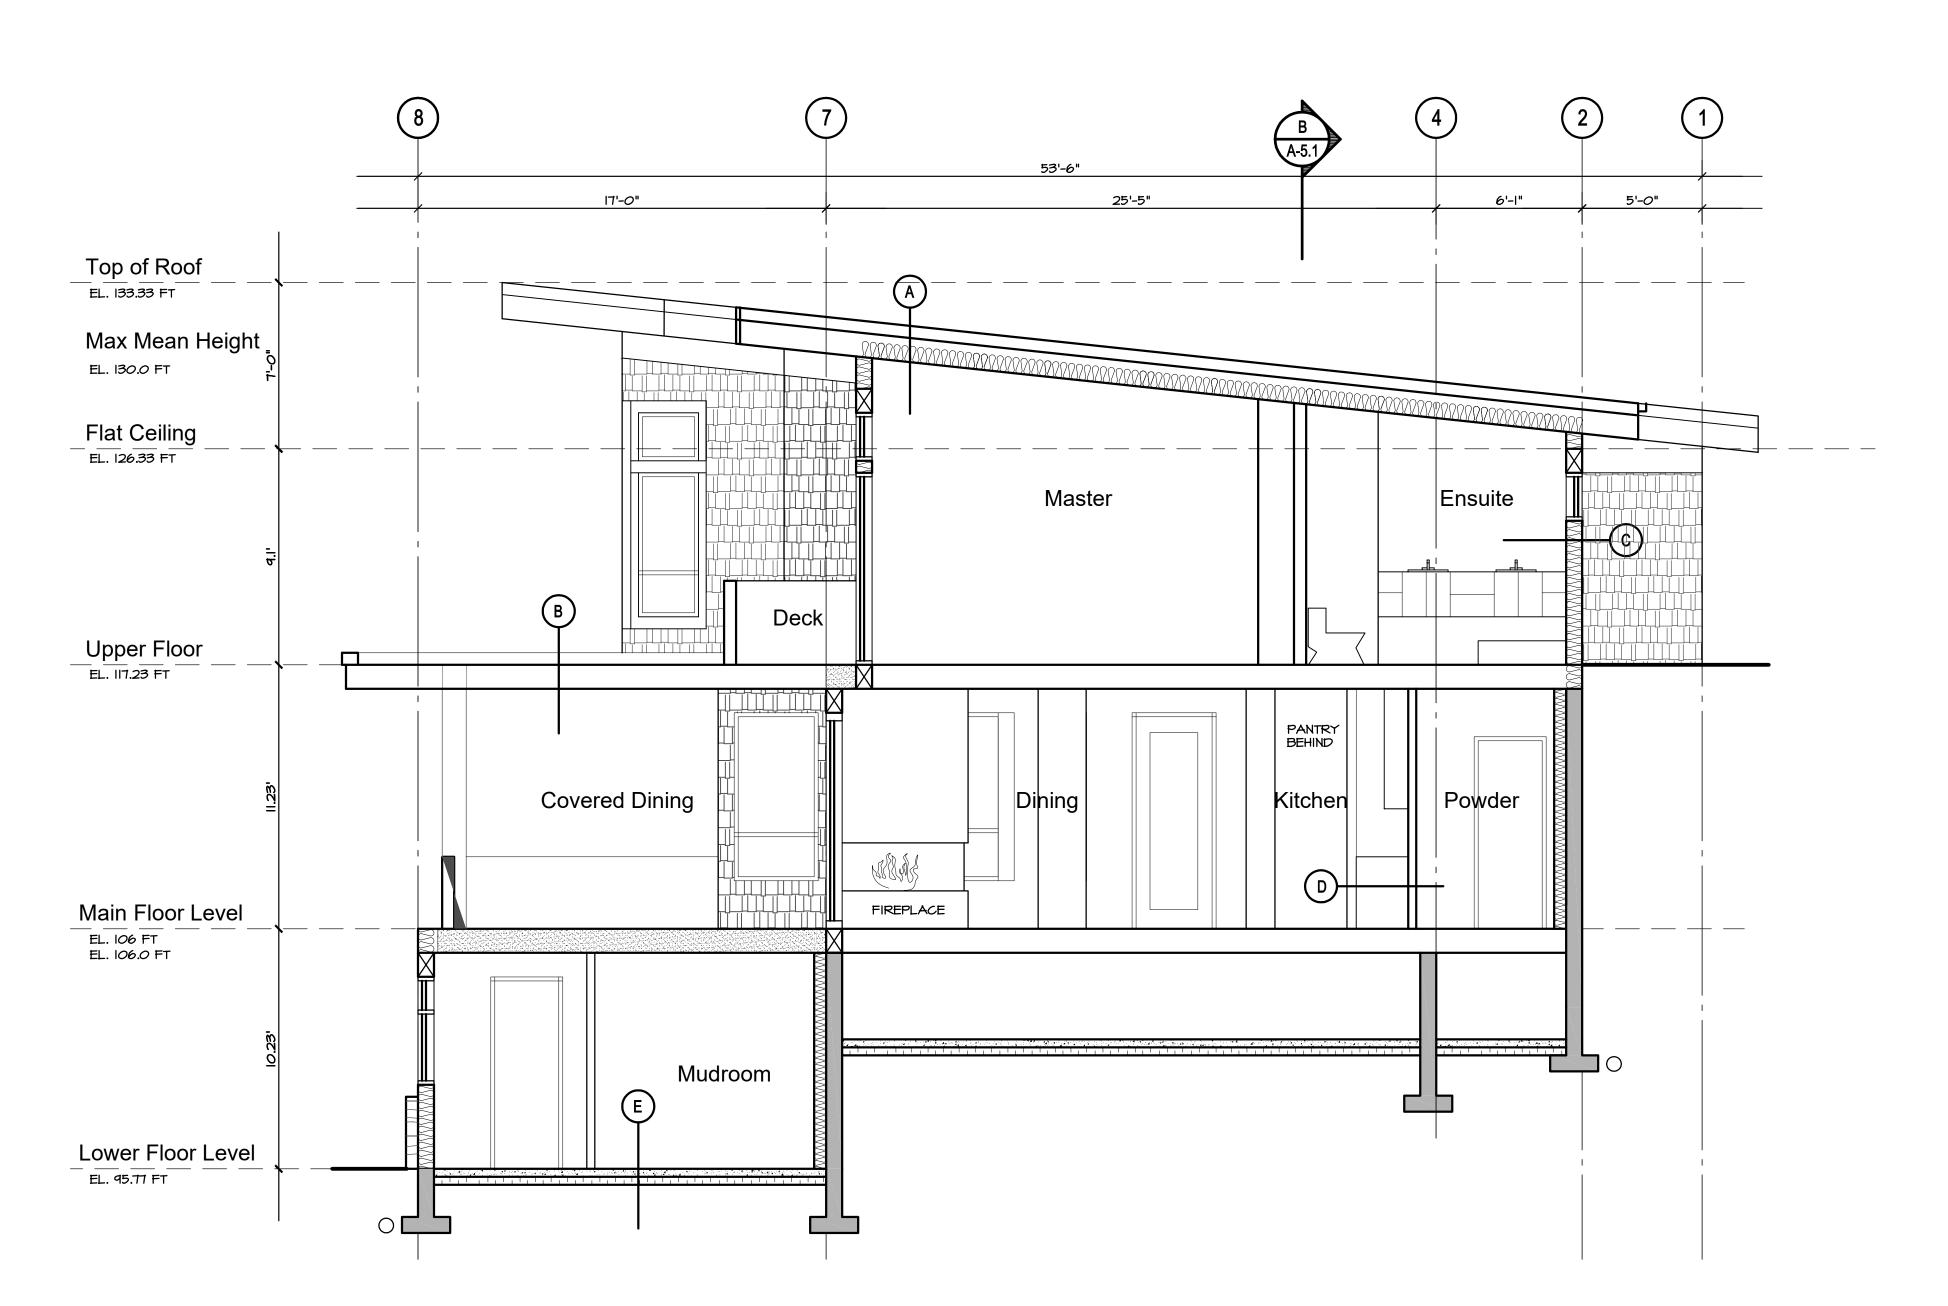

Section C

Assembly Legend

A. STANDING SEAM ROOF - CASCADIA WATERPROOF MEMBRANE ON SHEATHING, AS PER STRUCTURAL 2X4 STRAPPING ON TJI ROOF JOISTS AT 24" O.C. R-40 BATT. INSULATION 6 MIL U.V. POLY VAPOUR BARRIER 1/2" DRYWALL

RADIANT FLOORING - LIGHT WEIGHT 1.5" GYPCRETE ON 5/8" T & G PLYWOOD SHEATHING, NAILED AND GLUED TJI FLOOR FRAMING PER STRUCTURAL 1/2" DRYWALL (NO DRYWALL BETWEEN CRAWLSPACE AND MAIN FLOOR)

C. HORIZONTAL SIDING

RAINSCREEN AS PER CONSULTANT APPROVED
DETAILS (PROVIDE MOCKUP ON SITE PRIOR
TO PROCEEDING WITH INSTALLATION.)

TYVEK COMMERICIAL WRAP, INSTALLED AS A AIR BARRIER SYSTEM
I/2" PLYWOOD SHEATHING
2X8 STUDS @ 24" O.C., AS PER STRUCTURAL
R28 BATT INSULATION AND 6 MIL PLY
VAPOUR BARRIER.
I.2" GYPSUM BOARD

D. INTERIOR PARTITION WALL

1/2" GYPSUM BOARD BOTH SIDES OF 2X4

STUDS UNLESS NOTED ON DRAWINGS BY

STRUCTURAL OR PLUMBING WALLS SHOWN
IN PLAN.

E. FLOOR FINISH ON

4" CONCRETE SLAB ON GRADE

4" XPS R 20 RIGID INSULATION

6 MIL U.Y. POLY VAPOUR BARRIER

6" COMPACTED GRAVEL BASE

F. FOUNDATION WALL ASSEMBLY

DIMPLEBOARD DRAINAGE MAT
2 COATS DAMP PROOFING
8" CONCRETE
2" XPS RIGID INSULATION
2X4 @ 24" O.C. W RI4 BATT INSULATION
1/2" GMB

G. CANTILEVERED SPACE
R-40 BATT. INSULATION
FINE-LINE HEMLOCK SOFFIT
W VENT STRIPS

1. Issued for Client Review - January 19, 2018

1. per Committee coments - August 06, 2021

Consultants:

West Vancouver, BC

Planting Plan

Sheet No: L1 of 4

West Vancouver Design Rationale:

4841 The Dale

Basalt Column Loose Retaining

The landscape design follows the Architectural lead that tucks a clean crisp modern building into the hillside and allows the natural existing grades and forest cover to engulf it from the rear and sides.

The rear of the site utilises the existing levels and grades, (and wall structures) where possible, to form the multileveled outdoor living spaces on the property. Most of the paving here is natural stone slabs and the plant material is primarily native and shade loving.

The stone outcroppings will be cleaned and enhanced where possible, to add to

The stone outcroppings will be cleaned and enhanced where possible, to add to the moutainside expression of the landscape.

The front of the new house is very contemporary and has a short driveway and small formalised front semi-private garden area which adds layering to the entry of the home.

The elements in landscape design (the concrete walls, details, furnishings and lush plant material) at the front of the house all compliment the modern


The concrete stairs are detailed with large reveals to emphasize lightness.

character of the new home.

Cut Stone Slab Secondary (rear) Steps



Groundcover in between Pavers

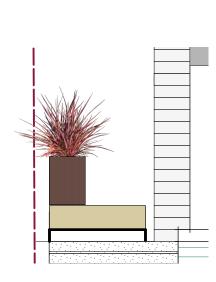


2 Custom Timber and Metal Benches
Scale: 1/4" = 1'-0"

3 Concrete Entry Stair
Scale: 1/4" = 1'-0"





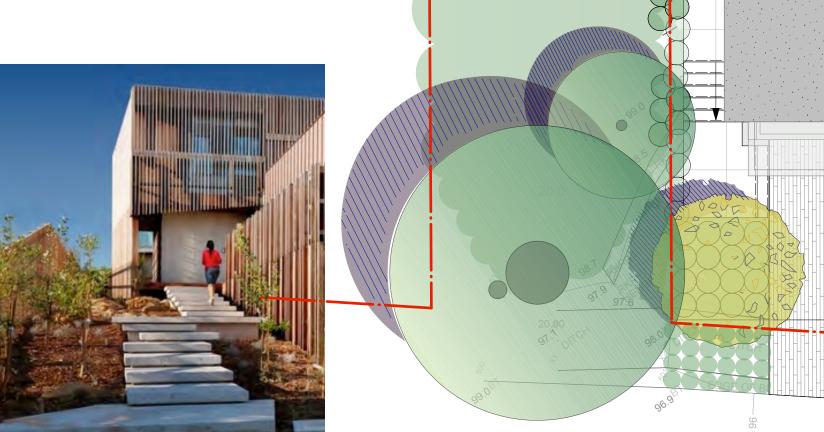























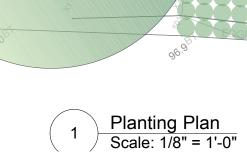

THE DALE

THE HALT

Project No: 17.037

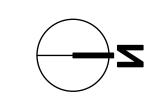

209-828 Harbourside Dr. North Vancouver British Columbia

Canada V7P 3R9

tel 604-986-9193 fax 604-986-7320

Revisions:

1. Issued for Client Review - January 19, 2018

1. per Committee coments - August 06, 2021

Consultants:


4841 The Dale - Caufield, DWV West Vancouver, BC

Grading & Layout Plan

As Noted.


Sheet No: Project No: 17.037 L2 of 4



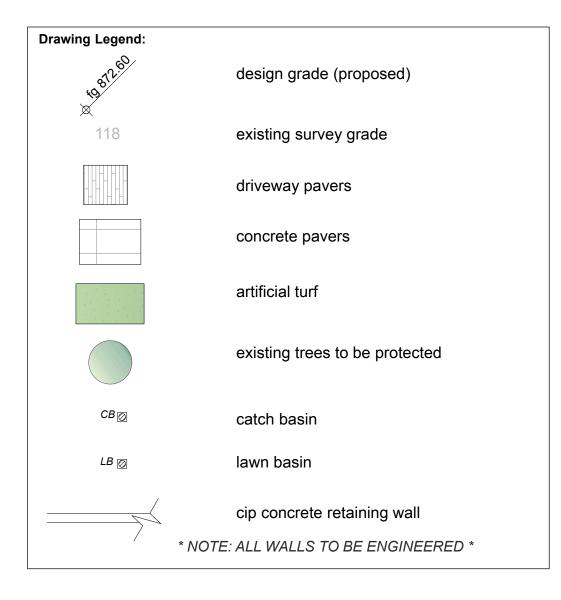

General Notes:

- All walls to be inspected and approved by geotech and structural engineer.
 Ensure positive drainage behind all walls and throughout site.
 All walls to conform to West Vancouver municipal bylaws and BPP Design Gudelines
 All landscape works (including boulevard areas) to be automatically irrigated
 Where soft landscape areas meet building foundation wall, 12-18" wide gravel drain strip to be installed at landscape grade.
 All CIP conc. walls visible from the street to be granite clad to BPP standard.
 Guardrails and handrails to be installed where required by code.
- 7. Guardrails and handrails to be installed where required by code.

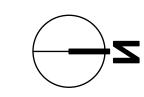



209-828 Harbourside Dr.
North Vancouver
British Columbia
Canada V7P 3R9
tel 604-986-9193

Revisions:

1. per Committee coments - August 06, 2021

1. Issued for Client Review - January 19, 2018

Consultants:

Project:

4841 The Dale - Caufield, DWV
West Vancouver, BC

Title:

Planting Plan

Drawn:
Checked:
Date:
BH
Mar 2017

Scale:
AS Noted.

Copyright reserved. This drawing and design is the property of Forma Design Inc. and may not be used without LandscapeArchitect's written permission.

Contractors shall verify and be responsible for all dimensions on the job and this office shall be

Project No: Sheet No: 17.037 L3 of 4

	146.9 146.9	THE HALT THE HA	To Tago Tago Tago Tago Tago Tago Tago Tago Tago
18 _AN 4763	CLOVELLY WALK Pleasing Diagrams Pleasing Place	Vac	Vac
	Planting Plan Scale: 1/8" = 1'-0"	THE DALE	% &1,5

PL	ANT LIST ON-SITE				
ID	Latin Name	Common Name	Quantity	Scheduled Size	Notes
TREES (DEC	LIDUOUS & CONIFEROUS)				
ACx	Acer circinatum	Vine Maple	7	2.5m ht.	
AP	Acer palmatum Green	Japanese Maple	2	2m ht.	
POM	Picea omorika	Serbian Spruce	5	3.0m	
SJ	Styrax japonicus	Japanese Snowbell Tree	6	5cm cal.	
Tph	Thuja plicata hedge	Western Red Cedar hedge	14	48" B&B	
SHRUBS					
Cht	Choisya ternata	Mexican Orange Blossom	22	#5 pot	
Cor	Cornus sericea	Red Twig Dogwood	9	#1 pot	
Photen	Phormium tenax	New Zealand Flax	2		
Syx	Symphoricarpos alba	Snowberry	69	#3 pot	
Vac	Vaccinium parvilfolium	Red Huckleberry	133	#3 pot	
PERENNIALS	S & GROUNDCOVERS				
lim	Liriope muscari	Big Blue Lily Turf	31	#1 pot	
pol	Polystichum munitum	Western sword fern	294	#1 pot	
DRNAMENT	AL GRASSES & BAMBOOS				
cmi	Carex morrowii 'Ice Dance'	Ice Dance Japanese Sedge	39	#1 pot	
msg	Miscanthus sinensis 'Gracillimus'	•	15	#1 pot	
Sten	Stipa tenuissima	Ponytail Grass	1		
PL	ANT LIST - OFFSITE				
ID	Latin Name	Common Name	Quantity	Scheduled Size	Notes
<u> </u>	Lacin Hame	Common Hame	Quartery	Octricadica dize	11000
TREES (DEC	CIDUOUS & CONIFEROUS)				
BEJ	Betula utilis var. jacquemontii	Whitebarked Himalayan Bir	1	6cm cal.	
SHRUBS					
PERENNIALS	S & GROUNDCOVERS				
pol	Polystichum munitum	Western sword fern	100	#1 pot	
	AL GRASSES & BAMBOOS				
		lee Demon Jerrery C. J.	22	Ш1	
cmi	Carex morrowii 'Ice Dance'	Ice Dance Japanese Sedge	32	#1 pot	

Planting Notes

- 1. All materials and execution of landscape works shall conform to the C.L.S./B.C.N.T.A. Landscape standard. Refer to written specifications for complete landscape documentation.
- 3. The Landscape Contractor shall ensure that the on-site planting medium/soil meets the specification and recommendations of the soil analysis taken at the time of Substantial Completion. All recommendations of the soil analysis shall be executed prior to Final Acceptance of the landscape works by the Consultant and the municipal authorities.
- 4. Minimum planting medium depths:

lawn - 6"/150mm groundcover - 12"/300 mm shrubs - 18"/450 mm

shrubs - 18"/450 mm trees - 24"/600 mm (around and beneath rootbalL)


- 5. All plant material shall meet minimum size requirements as indicated on plant list. Quality of plant material and grading of site to conform to BCNTA standard for container grown stock.
- 6. Discrepancies between plant numbers on the plant list and on the plan should be reported to the landscape architect prior to ordering plant material. In the case where there is a discrepancy between plant numbers on the plant list and on the plan, the plan shall supercede the list.
- 7. All plant material to be supplied on the job site must be obtained from a nursery participating in the BCLNA Phytophthora ramorum Certification Program. Plant material provided by the contractor found to be carring Pr will be removed, disposed of and replaced at the contractor's expense.

8. Tree Protection Measures

Where construction, demolition, or excavation is to take place within 4m of the drip line of a tree to be retained, a protection barrier at least 4'0" (1.2m) in height must be installed around the tree or group of trees to be retained. The diameter of the barrier shall be no smaller than the drip line of the tree(s). The barrier must be constructed of snow fencing staked every 3' (1m), plywood sheets fastened to wooden stakes or of another form approved by the municipality. The barrier shall be constructed prior to any site work and remain intact until all construction is complete. The barrier shall clearly display all-weather signage indicating that the area is a protected zone. Any work which must be done within the protection zone is to be done by hand. No burning is to take place close enough for the flames or heat to damage any tree to be retained.


- 9. Obstructions If obstructions or other conditions detrimental to healthy plant growth are encountered, notify the landscape architect and request additional instructions.
- 10. Plants shall be nursery grown under climatic conditions similar to those in the location of the project. Plants shall be healthy, vigorous and of normal habit of growth for the species. They shall be free from diseases, insects, insect eggs and larvae and shall equal or exceed the size indicated on the plant list. The plants shall not be pruned prior to delivery except upon special approval.



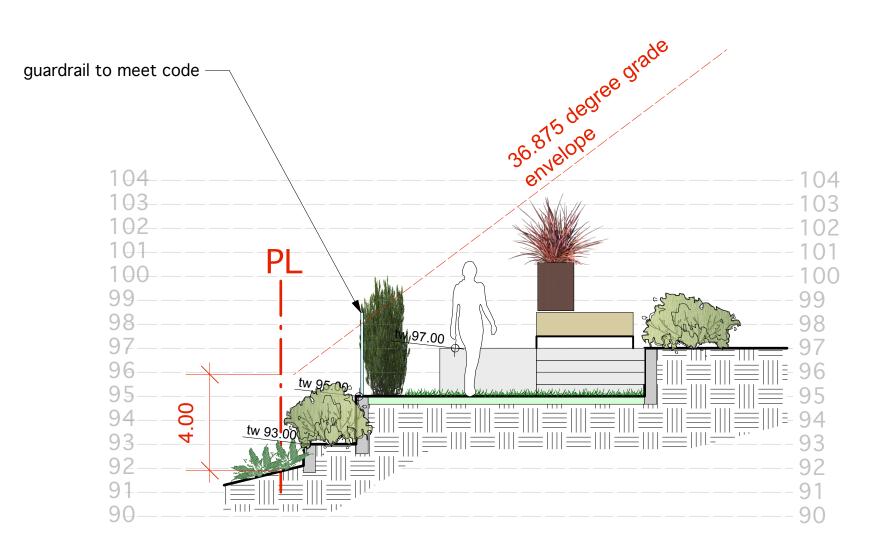



front yard section Scale: 1/4" = 1'-0"



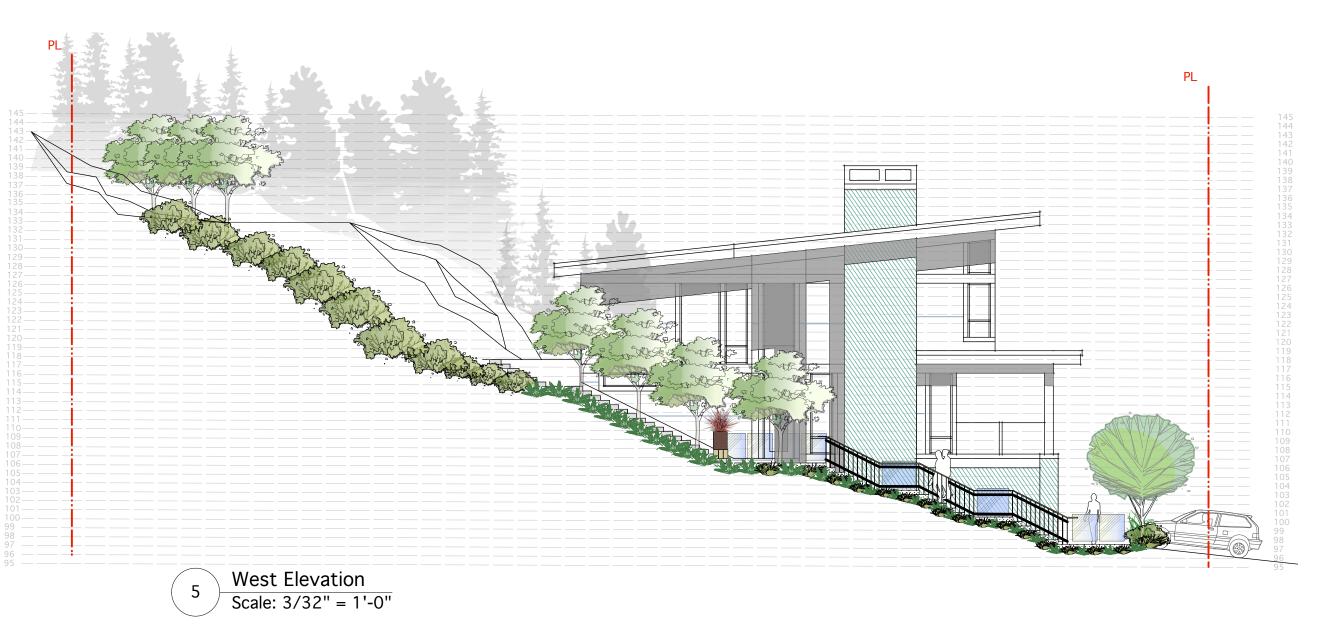



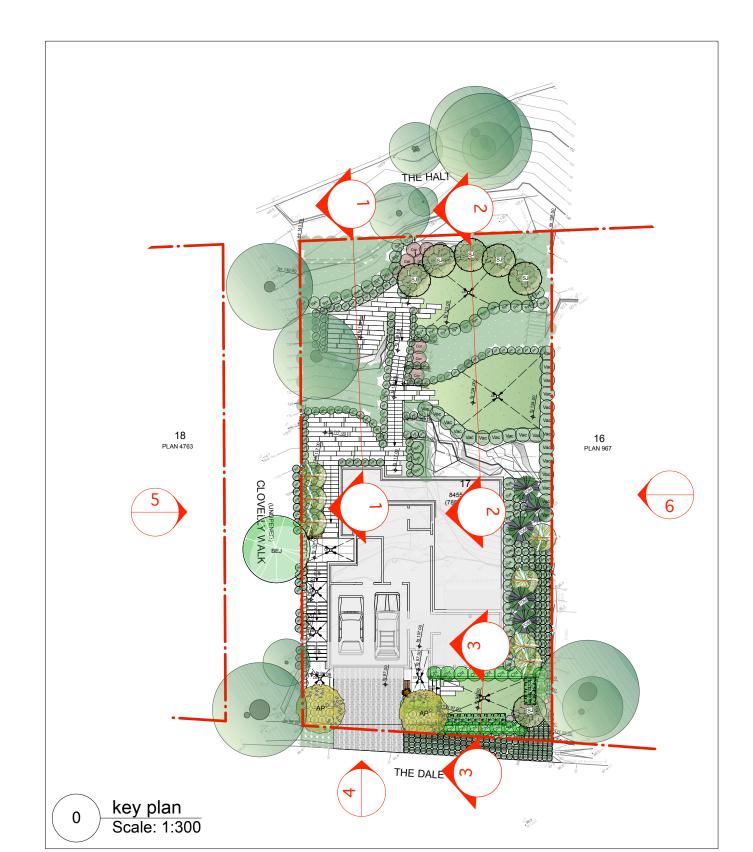

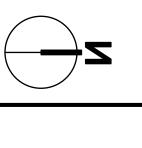

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Davision

1. Issued for Client Review - January 19, 2018

1. per Committee coments - August 06, 2021

Consultants:

Project:

4841 The Dale - Caufield, DWV
West Vancouver, BC

T:...

Sections & Elevations

Scale: As

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Contractors shall verify and be responsible for dimensions on the job and this office shall be informed of any changes made on site.

Project No:

17.037

Sheet No: L4 of 4